Appendix E: Urban Design and Landscape Concept



PUBLIC REALM PRINCIPLES



CLEAR & INTUITUVE

I know where I'm going.

A generous and clear groundplane with an enhanced sense of arrival.

Strengthen east/west connectivity

Clear connections from beyond the precinct.



SAFE & WELCOMING

I feel safe. I can stay or just pass through at night or day.

Clear sightlines and lighting to enhance feelings of safety.



TREES & SHADE

Create a sense of human scale and enclosure.

Provide shade, shelter and thermal comfort.



MULTI-FUNCTIONAL

Flexibility of the public realm to allow for a number of different uses & functions.



CULTURALLY & SOCIALLY INCLUSIVE

Spaces that promote social, cultural and knowledge exchange.

KEY THEMES



OUTDOORISH

Brooks Country Feel Simple Experiencing Seasons

The Byford station precinct contributes a country feel to the town centre. The hills and brooks can be experienced everywhere with each season creating its own spectacle. Spaces and buildings remind people of the natural landscape and rural farms while accommodating the urban convenience of a town centre. Life happens preferably outside and spaces provide for that. Even hikers and horses can be seen in town.



GROWING

Buzz of the old and new Exploring and developing Youthful & Fresh Grounded

The Byford Station precinct is a place of becoming, its a place of settling in a settled environment.

Old and new go together hand-in-hand. The place feels comfortable and safe. It is youthful and forward looking while remembering the past; the orchards, the brickworks and country.



INFORMAL


Open and Friendly Relaxed Peaceful Playful

Complementing the other two themes, the Byford station precinct feels informal, open and relaxed. It is a place breathing a slow pace even when people might be rushing through to catch their train. The place is functional and organised, but without looking rigid and constricting. It is playful, fluent and friendly.

BYFORD PRECINCT ZONES




LANDSCAPE MASTERPLAN - DAY 1

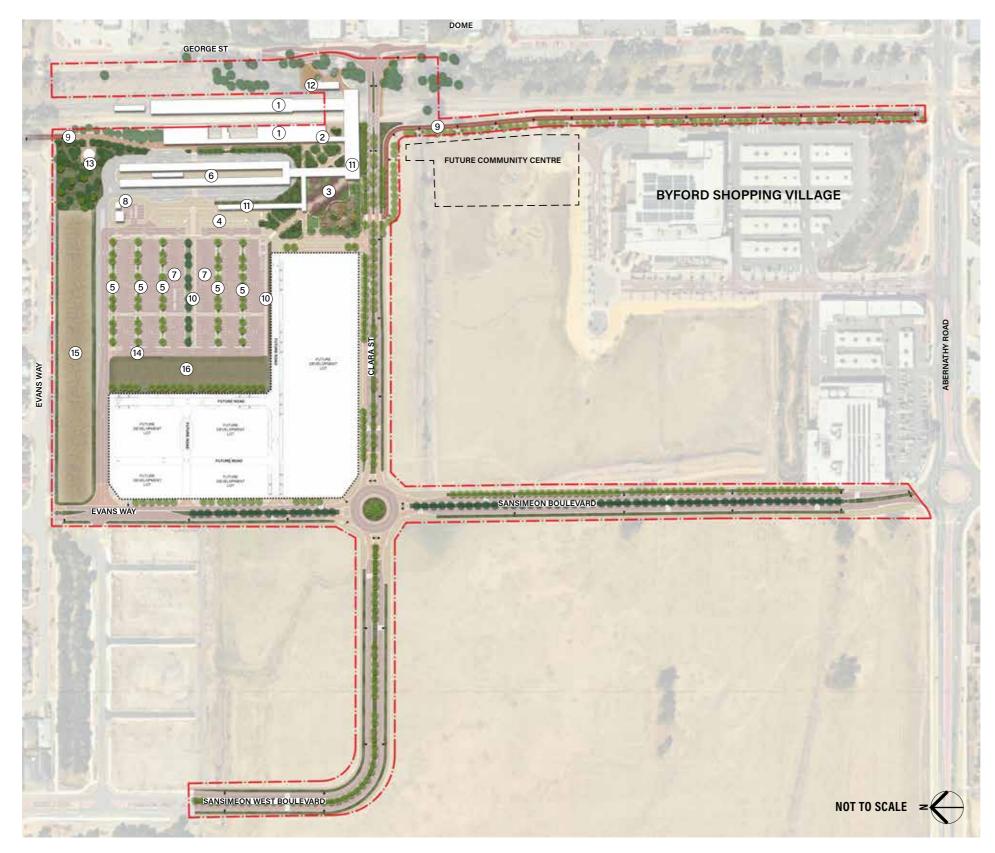

LEGEND

- 1 Train Station
- 2 Kiosk
- (3) Public Precinct
- (4) Kiss & Ride
- (5) WSUD
- (6) Bus Terminal
- 7 Public Parking
- (8) Staff Parking
- 9 Principal Shared Path
- 10 Pedestrian Pathway
- (11) Shelters
- 12 Bicycle Shelter
- (13) Irrigation Tank
- (14) Access Road
- (15) Multi-Use Corridor
- (6) Revegetation


LANDSCAPE MASTERPLAN - DAY 1 - PUBLIC PRECINCT

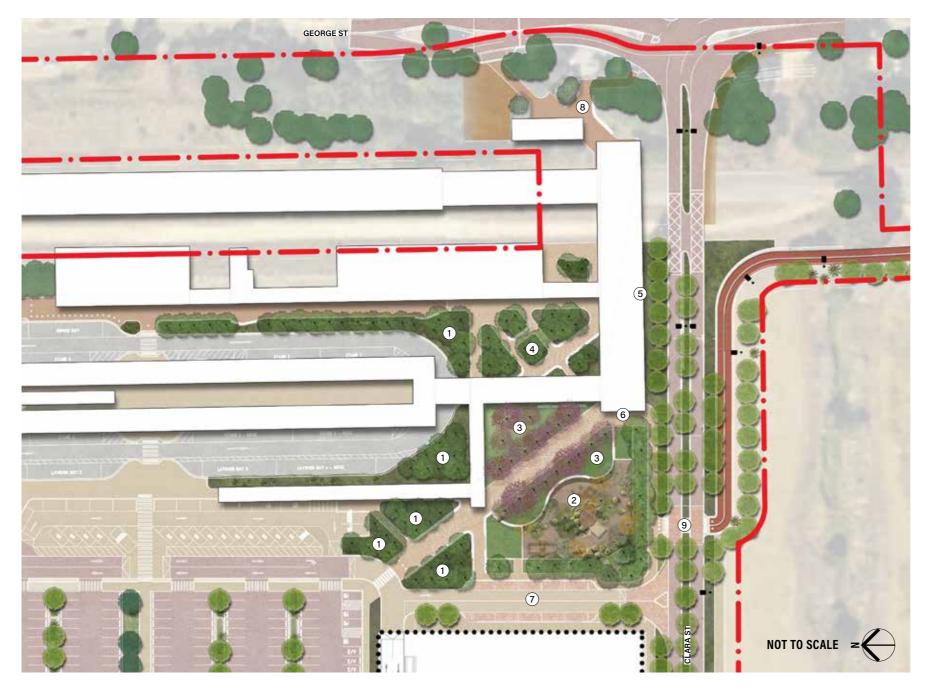

LEGEND

- 1 Welcome Gardens
- 2 Play Space
- 3 The Green
- (4) Bush Plaza
- 5 Bike Racks
- 6 Cafe cart opportunity
- 7 Plaza St including power & water
- George St Entry
- 9 Clara St Crossing


LANDSCAPE MASTERPLAN - ULTIMATE

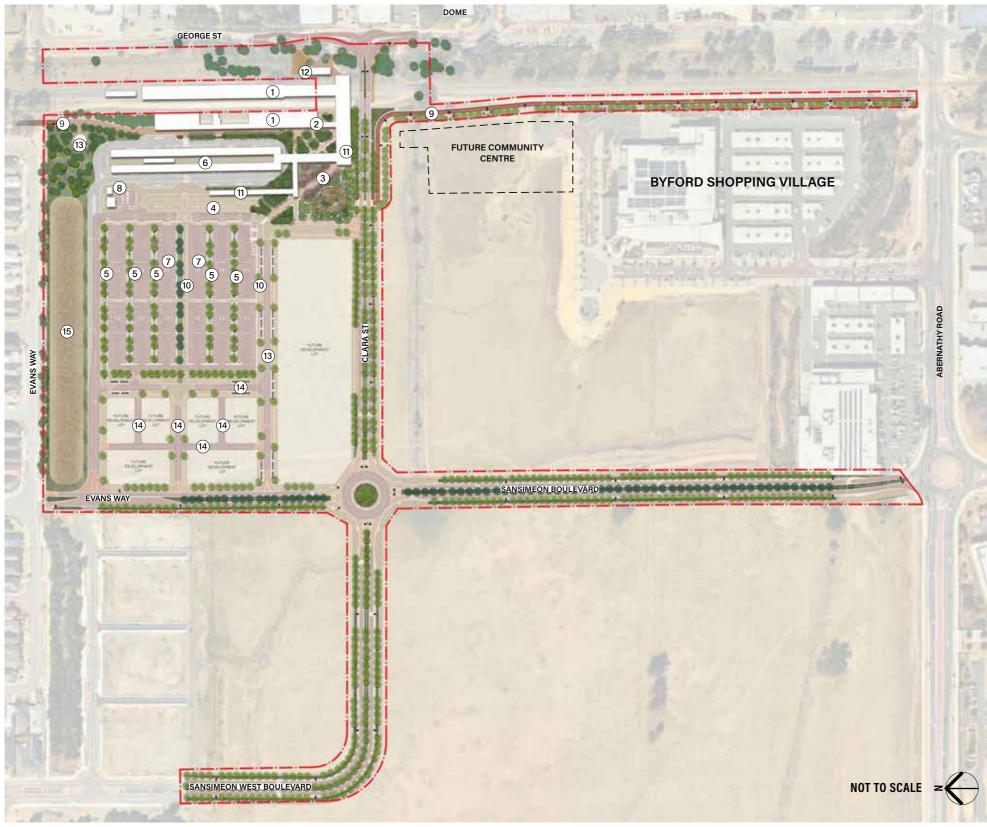

LEGEND

- 1 Train Station
- 2 Kiosk
- (3) Public Precinct
- 4 Kiss & Ride
- **5** WSUD
- (6) Bus Terminal
- (7) Public Parking
- (8) Staff Parking
- (9) Principal Shared Path
- 10 Pedestrian Pathway
- 11) Shelters
- 12) Bicycle Shelter
 - (3) Irrigation Tank
 - (14) Future Roads
 - (15) Multi-Use Corridor


LANDSCAPE MASTERPLAN - ULTIMATE - PUBLIC PRECINCT

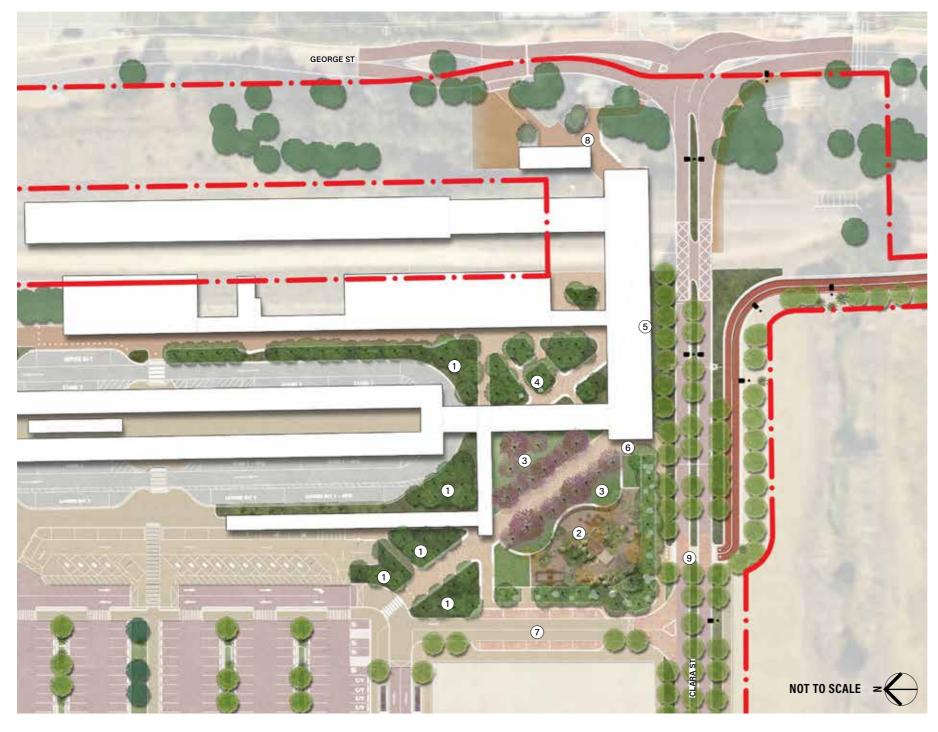


LEGEND

- (1) Welcome Gardens
- 2 Play Space
- 3 The Green
- 4 Bush Plaza
- (5) Bike Racks
- 6 Cafe cart opportunity
- Plaza St including power & water
- 8 George St Entry
- 9 Clara St Crossing

INVESTMENT DIAGRAM

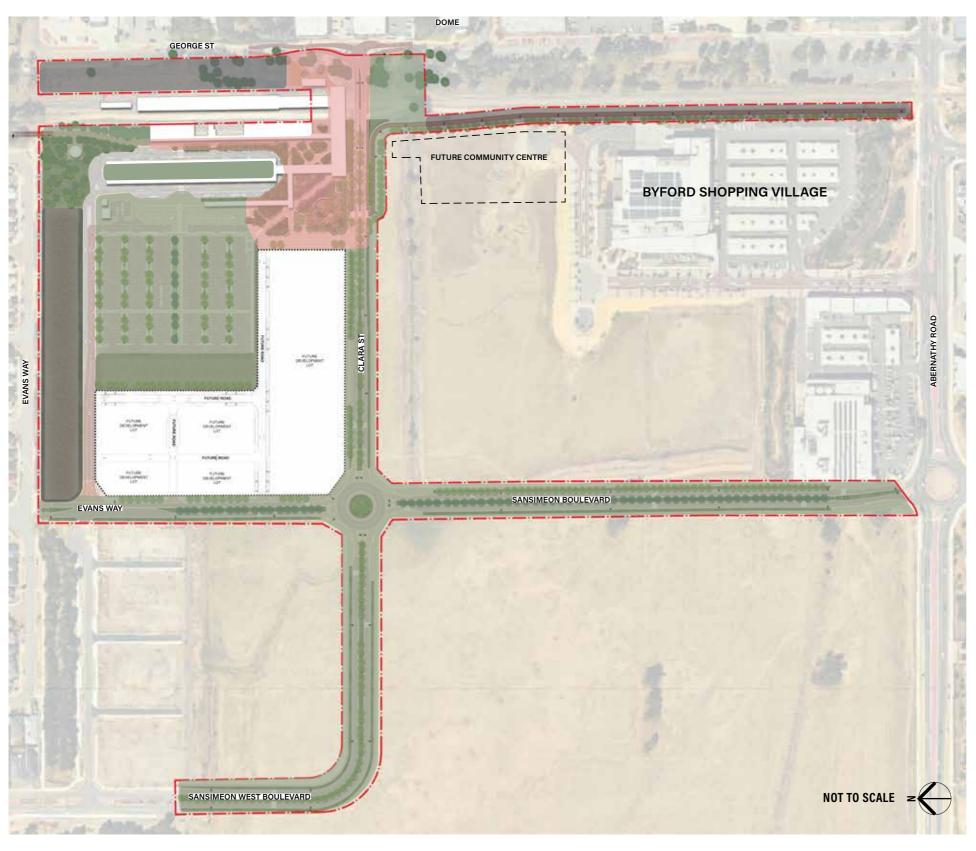

LEGEND

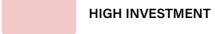







___ EXTENT OF WORKS

TREE RETENTION

A canopy mapping exercise was undertaken in March 2023 to develop baseline canopy data. The existing canopy pre-development is:

- ~ 9,501 M² OF CANOPY
- ~ 8.22% CANOPY COVERAGE WITHIN DEVELOPMENT ENVELOPE

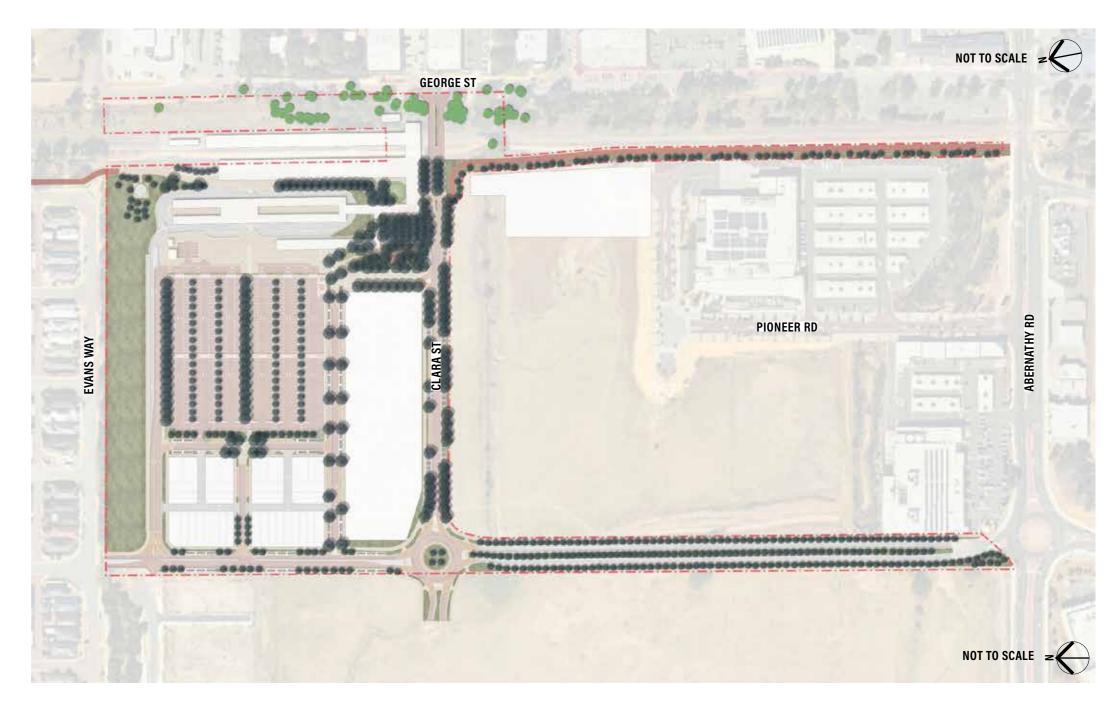




FIGURE 1. EXISTING BASELINE CANOPY WITHIN THE DEVELOPMENT ENVELOPE - MARCH 2023

PROJECTED CANOPY YEAR 10

- ~ 33,718M² PROJECTED CANOPY
- ~ 29.17% PROJECTED CANOPY



KEY

DEVELOPMENT ENVELOPE




EXISTING TREE CANOPY



PROPOSED TREES

FIGURE 2. LIKELY CANOPY PROJECTION YEAR 10 - MARCH 2023

SECTIONAL STUDY

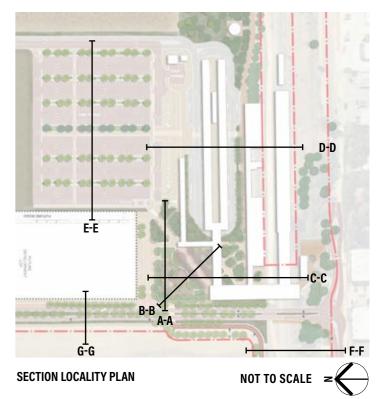



SECTION A-A



SECTION B-B



SECTION C-C



SECTION D-D



SECTION E-E




SECTION F-F



SECTION G-G

BUSH PLAZA

Tall, clear trunked trees to provide shade, shelter Clear sightlines.
Simple and uncluttered space
Approx 600m2
Low walled seating elements
Safe & well lit

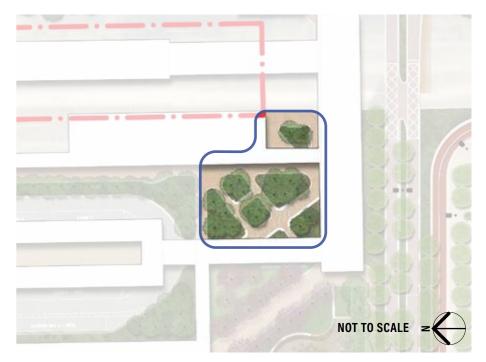



PLAZA ST - FUNCTION & USE

Plaza St provides a simple, flexible space for markets, food trucks, and events.

Opportunity for 10+ food trucks.


~Close down PLaza St

Lighting, power and water integrated



THE GREEN

Turf can be used for activation and events
Deciduous trees located on north side provide
shade and shelter in summer and sun in winter
Low seating walls provides an occupiable edge,
Sloped turf area
Double row of trees along Clara St

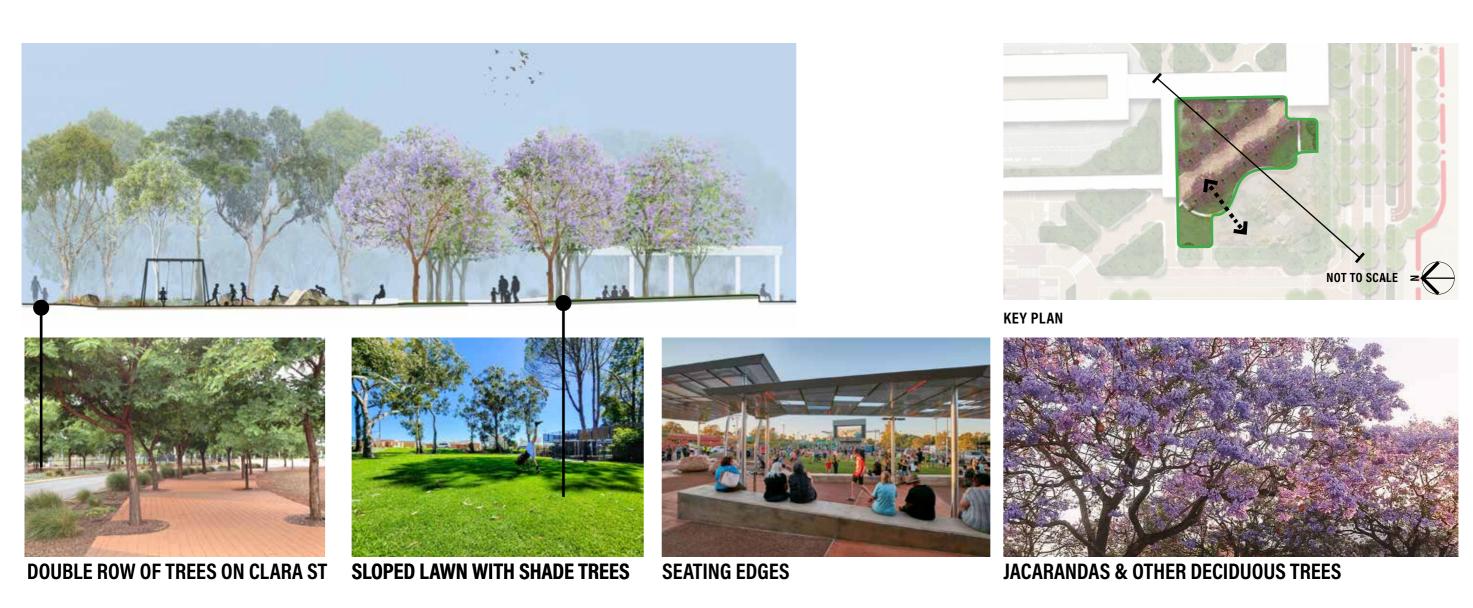

THE PLAY SPACE

A nature playground, with seating walls and shade trees.

Multipurpose elements celebrate local materials and serve as meeting places or play
Celebrates the local fauna & flora









COLOURS & TEXTURES

SUBTLE ART & STORY TELLING OPPORTUNITIES

SEATING

KEY PLAN











CELEBRATE WATER IN LANDSCAPE MISTERS/SENSORY


RAKALI

NATURE PLAY

SUBIACO THEATURE PLAY SPACE

CIRCULATION & SEATING

Clear, generous, shaded and safe pathways, access for food trucks and vehicles with regular places of rest and respite.

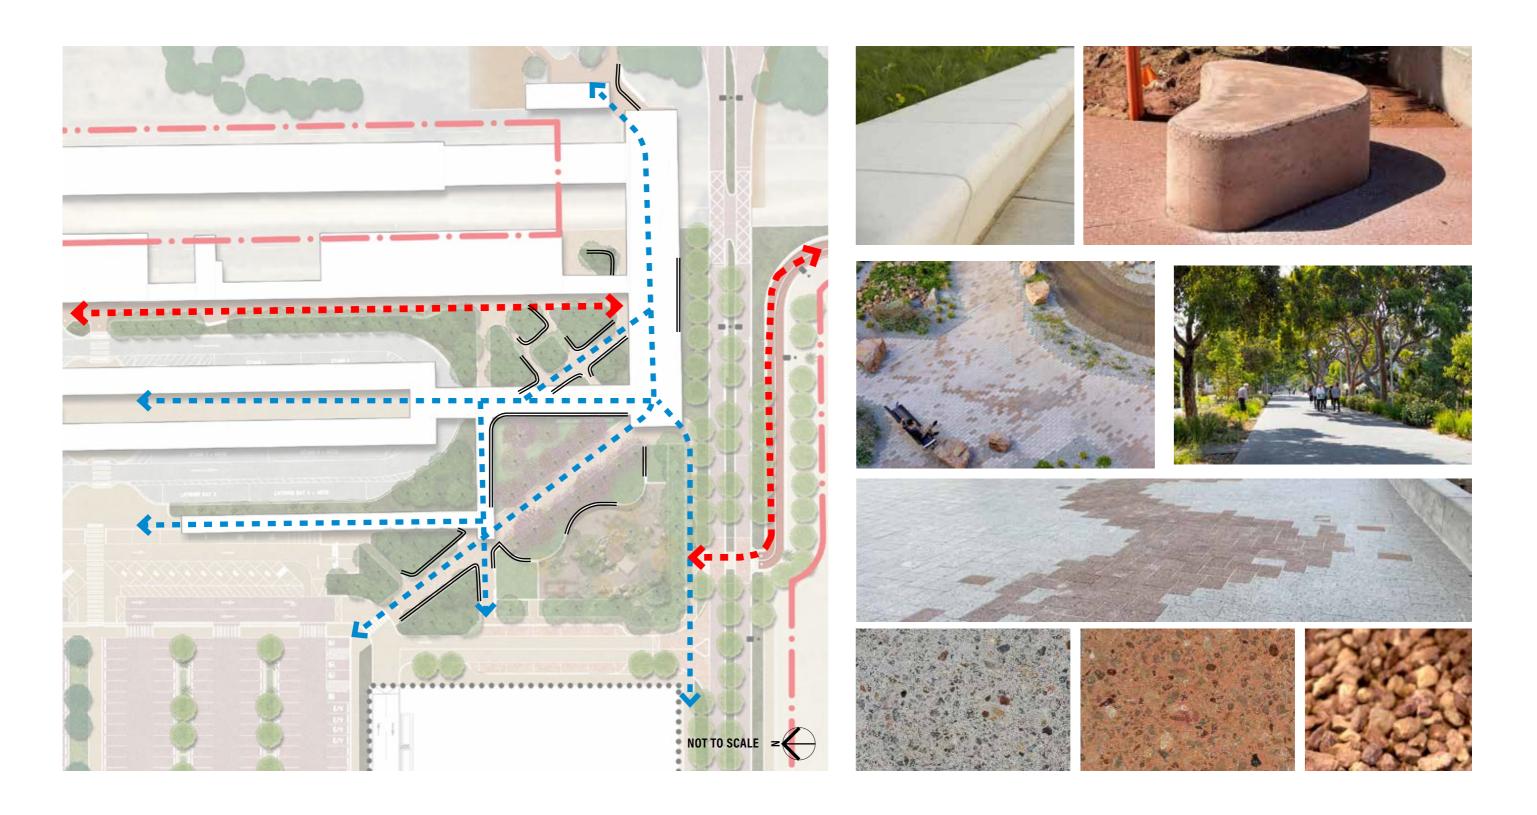

PLANTING

Extensive tree planting will provide a +30% tree canopy for the precinct.

~ 200 mature transplanted Balga providing visual impact from day one.

SUITABILITY FOR SPACE & FUNCTION ESPECIALLY SIGHT-LINES & SAFETY



1 LONG LASTING & LOW MAINTENANCE




3 PREFERENCE FOR NATIVE AND ENDEMIC



AESTHETICS AND SENSE OF PLACE



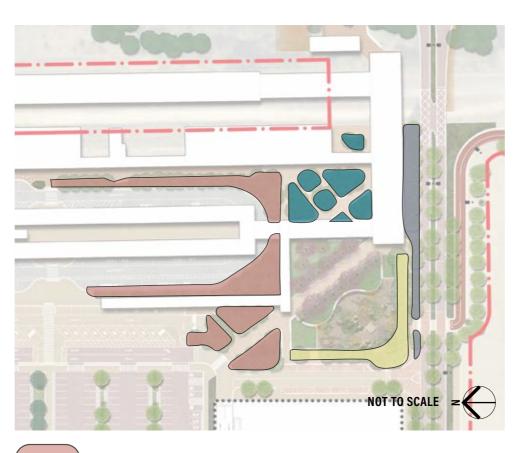





























MATERIAL SELECTIONS


Materials that builds on byfords landscape character and reinforces wayfinding and sense of place.



TREE SELECTION PRINCIPLES

The following principles for street tree selection and placement within the Precinct


Prioritise clear trunked tree species to offer clear sightlines. Ensure trees are located at a suitable distance from crossovers and street intersections.

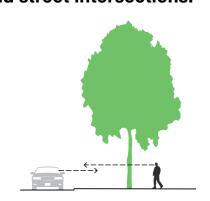

Planting a diversity of tree families, genus, and species will provide visual and seasonal interest, and resilience from pest and disease.



Select tree species to ensure selections are in scale and harmony with the existing streetscape and its functions, intersections.

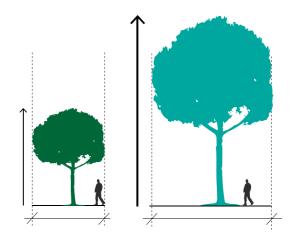

LARGE CANOPIED TREES


Preferencing taller, broad canopied tree species to maximise shade and cooling benefits.




CLOSE SPACING

Planting trees with a close spacing to provide a quick increase in canopy cover and a continuous and connected canopy cover.

Trees planted closely will develop more upright forms, and be less susceptible to wind damage and heat stress.

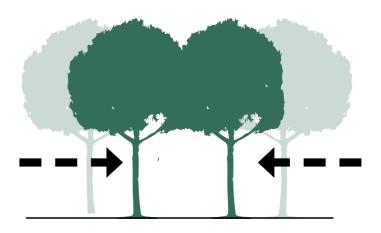


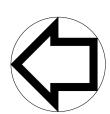

BYFORD RAIL EXTENSION

BYFORD STATION PRECINCT LANDSCAPE WORKS

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SCALE AMERICA 1907-1907 1.0 A. A. SPECTRON PROPERTY AMERICAN PROPERTY PR	B.01	SHEET LAYOUT PLAN	LANDSCAPE	BYFORD STATION PRECINCT	11-A-109-LA0017	30-UDL-DWG-LA-330-00021
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20 U.U. D. C. A. 195 C. 1900	B.01	TREE RETENTION PLAN - SHEET 03	LANDSCAPE	BYFORD STATION PRECINCT	11-A-109-LA0020	30-UDL-DWG-LA-330-00102
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30-UDL_DMG_LA_330_0307 11.A_109_LA0005 8YFORD STATION PRECINCT LANDSCAPE GENERAL ARRANGEMENT & FINISHES PLAN - SHEET 0						
30-UDI_OWG_LA_330_00308 1.A_109_LA0066 BYFORD STATION PRECINCT LANDSCAPE GENERAL ARRANGEMENT & FINISHES PLAN - SHEET 10						
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11-A-109-LA0068 BYFORD STATION PRECINCT LANDSCAPE GENERAL ARRANGEMENT & FINSHES PLAN - SHEET 19	B.01					
30-UDL_DWG_LA_330_00311 11_A_109_LA0069 BYFORD STATION PRECINCT ANDSCAPE GENERAL ARRANGEMENT & FINISHES PLAN - SHEET 17	B.01					
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30-UDL-DWG-LA-330-00402	B.01					
30-UDL-DWG-LA-330-00404	B.01					
30-UDL-DWG-LA-330-00404 11-A-109-LA0082 BYFORD STATION PRECINCT LANDSCAPE PLANTING PLAN - SHEET 05 30-UDL-DWG-LA-330-00406 11-A-109-LA0083 BYFORD STATION PRECINCT LANDSCAPE PLANTING PLAN - SHEET 06 30-UDL-DWG-LA-330-00406 11-A-109-LA0085 BYFORD STATION PRECINCT LANDSCAPE PLANTING PLAN - SHEET 07 30-UDL-DWG-LA-330-00408 11-A-109-LA0086 BYFORD STATION PRECINCT LANDSCAPE PLANTING PLAN - SHEET 08 30-UDL-DWG-LA-330-00408 11-A-109-LA0086 BYFORD STATION PRECINCT LANDSCAPE PLANTING PLAN - SHEET 10 30-UDL-DWG-LA-330-00409 11-A-109-LA0087 BYFORD STATION PRECINCT LANDSCAPE PLANTING PLAN - SHEET 10 30-UDL-DWG-LA-330-00410 11-A-109-LA0089 BYFORD STATION PRECINCT LANDSCAPE PLANTING PLAN - SHEET 11 30-UDL-DWG-LA-330-00510 11-A-109-LA0089 BYFORD STATION PRECINCT LANDSCAPE PLANTING PLAN - SHEET 12 30-UDL-DWG-LA-330-00500 11-A-109-LA0099 BYFORD STATION PRECINCT LANDSCAPE PLANTING PLAN - SHEET 12 30-UDL-DWG-LA-330-00500 11-A-109-LA0099 BYFORD STATION PRECINCT LANDSCAPE PTA ASSET PLAN - SHEET 10 30-UDL-DWG-LA-330-00500 11-A-109-LA0100 BYFORD STATION PRECINCT LANDSCAPE PTA ASSET PLAN - SHEET 03 30-UDL-DWG-LA-330-00500 11-A-109-LA0101 BYFORD STATION PRECINCT LANDSCAPE PTA ASSET PLAN - SHEET 03 30-UDL-DWG-LA-330-00500 11-A-109-LA0101 BYFORD STATION PRECINCT LANDSCAPE PTA ASSET PLAN - SHEET 04 30-UDL-DWG-LA-330-00500 11-A-109-LA0101 BYFORD STATION PRECINCT LANDSCAPE PTA ASSET PLAN - SHEET 05 30-UDL-DWG-LA-330-00500 11-A-109-LA0103 BYFORD STATION PRECINCT LANDSCAPE PTA ASSET PLAN - SHEET 06 30-UDL-DWG-LA-330-00500 11-A-109-LA0103 BYFORD STATION PRECINCT LANDSCAPE PTA ASSET PLAN - SHEET 07 30-UDL-DWG-LA-330-00500 11-A-109-LA0103 BYFORD STATION PRECINCT LANDSCAPE PTA ASSET PLAN - SHEET 07 30-UDL-DWG-LA-330-00500 11-A-109-LA0104 BYFORD STATION PRECINCT LANDSCAPE PTA ASSET PLAN - SHEET 10 30-UDL-DWG-LA-330-00500 11-A-109-LA0107 BYFORD STATION PRECINCT LAN	B.01					
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30-UDL-DWG_LA-330-00408	B.01	PLANTING PLAN - SHEET 07	LANDSCAPE	BYFORD STATION PRECINCT	11-A-109-LA0084	30-UDL-DWG-LA-330-00406
30-UDL-DWG-LA-330-00409	B.01			BYFORD STATION PRECINCT		30-UDL-DWG-LA-330-00407
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11-A-109-LA0089 BYFORD STATION PRECINCT LANDSCAPE PLANTING PLAN - SHEET 12	B.01	PLANTING PLAN - SHEET 10	LANDSCAPE	BYFORD STATION PRECINCT	11-A-109-LA0087	30-UDL-DWG-LA-330-00409
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11-A-109-LA0099 BYFORD STATION PRECINCT LANDSCAPE PTA ASSET PLAN - SHEET 02	B.01	PLANTING PLAN - SHEET 12	LANDSCAPE	BYFORD STATION PRECINCT	11-A-109-LA0089	30-UDL-DWG-LA-330-00411
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11-A-109-LA0103 BYFORD STATION PRECINCT LANDSCAPE PTA ASSET PLAN - SHEET 06	A.01					
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30-UDL-DWG-LA-330-01010 11-A-109-LA0128 BYFORD STATION PRECINCT LANDSCAPE SOFTSCAPE DETAILS 01	B.01	FURNITURE DETAILS 01	LANDSCAPE	BYFORD STATION PRECINCT	11-A-109-LA0123	30-UDL-DWG-LA-330-01005
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30-UDL-DWG-LA-330-01011 11-A-109-LA0129 BYFORD STATION PRECINCT LANDSCAPE SOFTSCAPE DETAILS 02	B.01	SOFTSCAPE DETAILS 01	LANDSCAPE	BYFORD STATION PRECINCT	11-A-109-LA0128	30-UDL-DWG-LA-330-01010
	B.01	SOFTSCAPE DETAILS 02	LANDSCAPE	BYFORD STATION PRECINCT	11-A-109-LA0129	30-UDL-DWG-LA-330-01011
BO-UDL-DWG-LA-330-01012 11-A-109-LA0130 BYFORD STATION PRECINCT LANDSCAPE SOFTSCAPE DETAILS 03	B.01	SOFTSCAPE DETAILS 03	LANDSCAPE	BYFORD STATION PRECINCT	11-A-109-LA0130	30-UDL-DWG-LA-330-01012

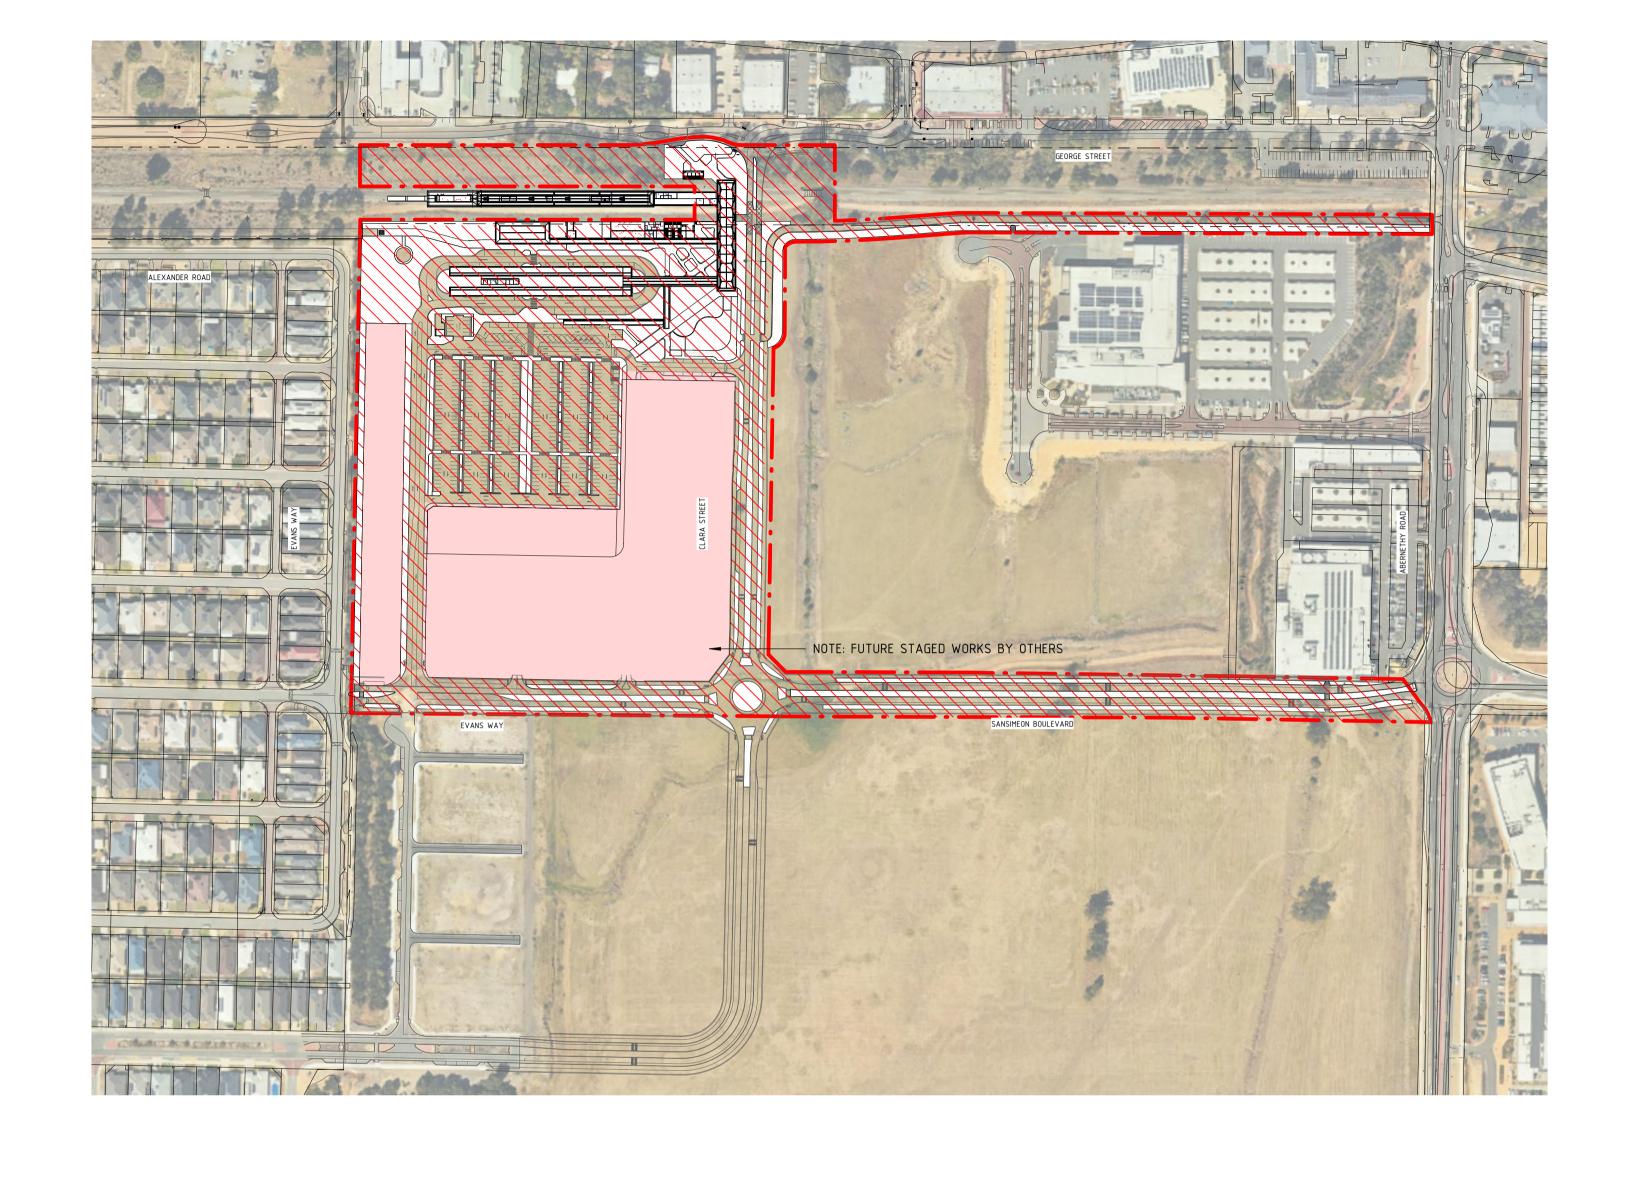

R30-UDL-DWG-LA-330-01013 | 11-A-109-LA0131 | BYFORD STATION PRECINCT | LANDSCAPE | SOFTING PRECINCT | LANDSCAPE | LANDSCAPE | LANDSCAPE | LANDSCAPE | LANDS



REFERENCES	SCALE		DESIGNED	CHaldavianth	Γ
R30-MET-XRF-CI-300-00001	1: 2500			C.Holdsworth	
R30-MET-XRF-CI-300-00002 R30-MET-XRF-CI-300-00003			DRAWN	Y.Demissie	
XR01CI_CLARA_GEORGE_DESIGN_PCG2020			CHECKED	M.I.I'-	
	DATUM			M.Harris	
	HORIZONTAL:	PCG2020	APPROVED	J.Davis	
	VERTICAL:	AHD71	DATE	10 07 22	


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h	Government of Western Australia Public Transport Authority B	YFORD RAIL EX	TENSION
	BYFORD STATION PRECINCT		
	LANDSCAPE		
	COVER SHEET		
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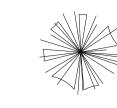
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AT ORIGINAL PLOT SIZE to a third party nor be used for any unauthorised purpose. Contractor No: R30-UDL-DWG-LA-330-00001 Rev: B.01


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LEGEND






T7-01 GRASS TREE TRANSPLANT

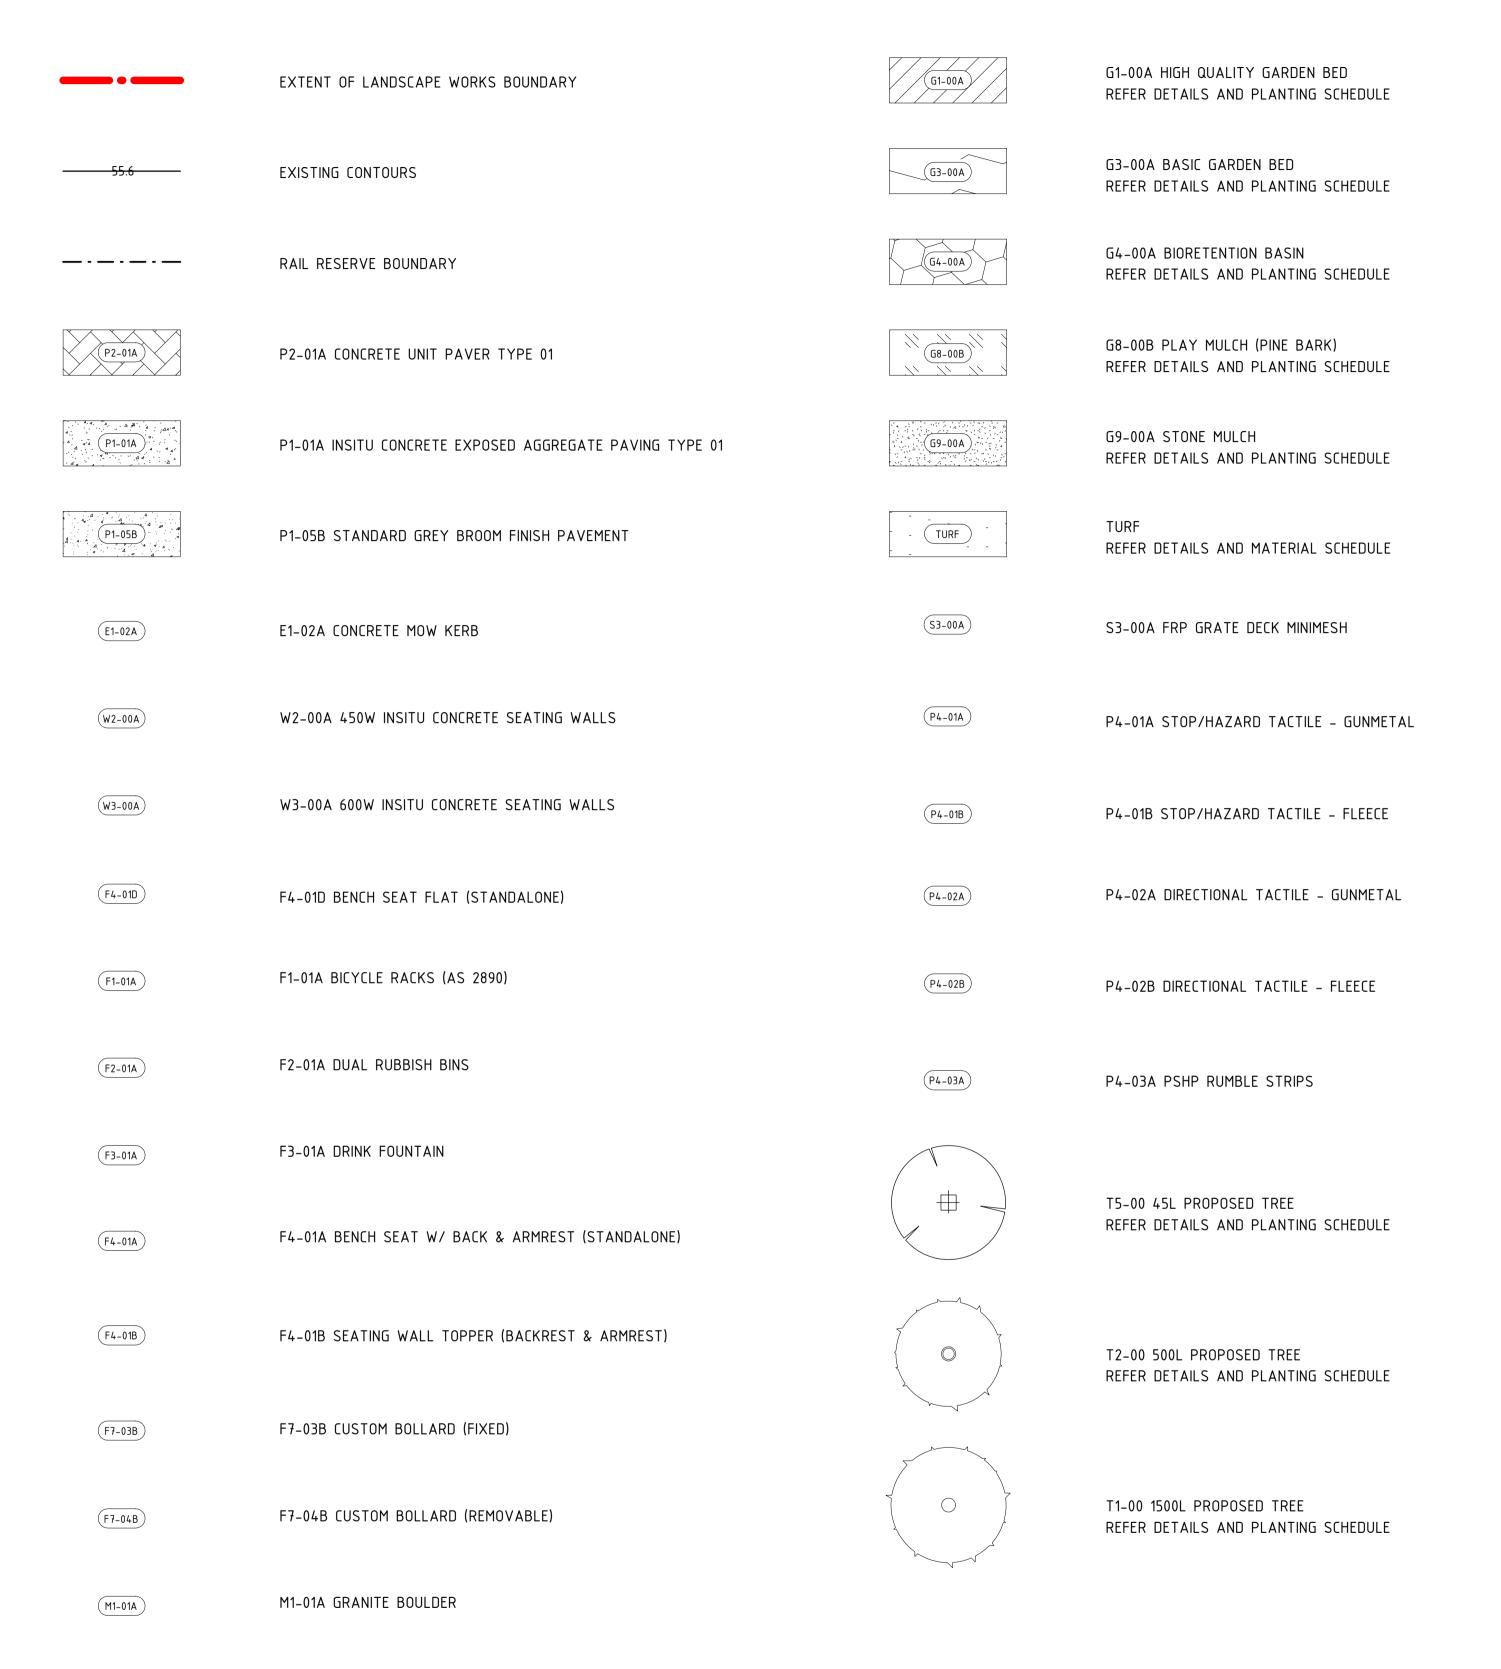

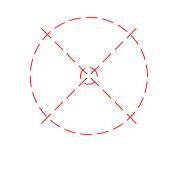EXISTING TREE TO BE REMOVED.

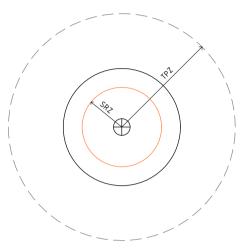

REFERENCES

EXISTING TREE TO BE RETAINED AND PROTECTED WITH STRUCTURAL ROOT ZONE (SRZ) & TREE PROTECTION ZONE (TPZ) TO AS. 4970

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1						
B.01	10.07.23	ISSUE FOR IDD-IDC	CH	YD	MH	JD
Α	12.10.22	ISSUE FOR RD	CH	YD	MH	AE
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SCALE		DESIGNED	C.Holdsworth	
		DRAWN	Y.Demissie	-
DATUM		CHECKED	M.Harris	
HORIZONTAL:	PCG2020	APPROVED	J.Davis	
VERTICAL:	AHD71	DATE	10.07.23	

	DETAILED DESIGN				
h	Government of Western Australia Public Transport Authority	BYFORD RAIL EX	TENSION		
	BYFORD STATION PRECING	.T			
	LANDSCAPE				
	LEGEND & NOTES				
}	PTA Drawing No: 11-A-109	9-LA0012	Rev: B.01		

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AT ORIGINAL PLOT SIZE

WALL SCHEDULE				
Type Mark	Description	Count		
W2-00A	Seating Wall - 450mm	55		

FLOOR SCHEDULE					
Type Mark	Description	Area	Count		
P1-01A	In-situ / Coloured, Exposed-Aggregate Concrete - Type 1	4517 m ²	4		
P1-05B	Standard Broom Finish Grey Concrete	1632 m ²	33		
P2-01A	Concrete / Engineered Stone Unit Pavement – Type 1	2713 m ²	6		
P4-03A	4-03A Thermoplastic raised marking material – Rumble Strips 3 m ² 1				
Grand total: 44		8866 m²			

	FURNITURE SCHEDULE	
Type Mark	Description	Count
F7-04B	Arbour Structure	6
F4-01A	Bench Seat	1
F2-01A	Bin Enclosure	6
F1-01A	Dero Surface Mounted Bike Rack - Hoop as Specified	10
F3-01A	Drink Fountain with Dog Bowl	2
F4-01B	Seating Wall Topper – Bench Seat	7
F7-03B	Stainless Steel Bollards – Fixed	27

Type Mark	Description	Size	Count
	'		
Γ1–09	Corymbia calophylla	1500L	4
T1-10	Eucalyptus accedens	1500L	3
T1-22	Eucalyptus leucoxylon	1500L	1
T1-34	Eucalyptus torquata	1500L	7
T1-37	Eucalyptus wandoo	1500L	4
T1-40	Jacaranda mimosifolia	1500L	9
T1-57	Quercus robur	1500L	3
T1-62	Ulmus parvifolia	1500L	7
T1-64	Eucalyptus victrix	1500L	9
T1-65	Eucalyptus lane-poolei	1500L	4
T2-04	Eucalyptus sideroxylon	500L	23
T2-09	Corymbia calophylla	500L	26
T2-19	Corymbia maculata	500L	6
T2-22	Eucalyptus leucoxylon	500L	24
T2-29	Eucalyptus rudis	500L	29
T2-34	Eucalyptus torquata	500L	15
T2-37	Eucalyptus wandoo	500L	15
T2-44	Melaleuca leucadendra	500L	4
T2-46	Melaleuca quinquinervia	500L	5
T2-49	Agonis flexuosa	500L	3
T2-50	Melaleuca viridiflora	500L	1
T2-64	Eucalyptus victrix	500L	7
T5-04	Eucalyptus sideroxylon	45L	46
T5-10	Eucalyptus accedens	45L	5
T5–14	Eucalyptus erythrocorys	45L	19
T5–17	Eucalyptus gomphocephala	45L	7
T5–19	Corymbia maculata	45L	19
T5-22	Eucalyptus leucoxylon	45L	40
T5-25	Eucalyptus marginata	45L	8
T5-29	Eucalyptus rudis	45L	24
T5-34	Eucalyptus torquata	45L	3
T5-37	Eucalyptus wandoo	45L	18
T5-44	Melaleuca leucadendra	45L	13
T5-46	Melaleuca quinquinervia	45L	39
T5-47	Melaleuca rhaphiophylla	45L	23
T5-50	Melaleuca viridiflora	45L	13
T7-01	Xanthorrhoea preissii		200

Type Mark	Description	Area	Coun
	·		
G1-00A	High Quality Irrigated Amenity Planting	1287 m²	6
G1-00B	High Quality Irrigated Amenity Planting	266 m²	3
G1-00C	High Quality Irrigated Amenity Planting	251 m²	5
G1-00D	High Quality Irrigated Amenity Planting	365 m ²	2
G1-00E	High Quality Irrigated Amenity Planting	399 m²	1
G3-00A	Basic Non-Irrigated Amenity Planting	4498 m²	55
G4-00A	Non-Irrigated Swales and Basin	4841 m ²	5
G4-00B	Non-Irrigated Swales and Basin	1870 m ²	2
G4-00C	Non-Irrigated Swales and Basin	5073 m ²	18
G4-00D	Non-Irrigated Swales and Basin	2581 m ²	5
G4-00E	Non-Irrigated Swales and Basin	2654 m²	1
G8-00B	Play Mulch	575 m ²	1
G9-00A	Stone Mulch	1057 m ²	4
Grand total: 10	8	25717 m ²	

PLANT SCHEDULE (G1-00A)					
		_	AREA	RATE (per m2)	
WELCOME	PLACE	Irrigated (Permanent)	1299sqm	4	
Code	Botanical Name	Common Name	Size	Total	
AAP	Acacia applanata	Golden Grass Wattle	140mm	472	
BAE	Beaufortia aestiva	Summer Flame	140mm	472	
BER	Bossiaea eriocarpa	Common Brown Pea	140mm	472	
CAC	Conostylis aculeata	Prickly conostylis	140mm	472	
CCA	Conostylis candicans	Cottonheads	140mm	472	
DRE	Dianella revoluta	Blue Flax Lily	140mm	472	
EGL	Eremophila glabra	Emu Bush	140mm	472	
GCR	Grivellea crithmifolia (prostrate)	Little Crith	140mm	472	
HPU	Hemiandra pungens	Snake Plant	140mm	472	
LLI	Lomandra little con	Mat Rush	140mm	472	
POC	Patersonia occidentalis	Purple Flag	140mm	472	
	<u>'</u>		<u>'</u>	5196	

	PLANT	SCHEDULE (G1-00E	3)	
			AREA	RATE (per m2)
PLAZA 1		Irrigated (Permanent)	266sqm	4
Code	Botanical Name	Common Name	Size	Total
AAP	Acacia applanata	Golden Grass Wattle	140mm	89
AHU	Anigozanthos humilis	Catspaw	140mm	89
AGR	Aotus gracillima		140mm	89
BSQ	Beaufortia squarrosa	Sand Bottlebrush	140mm	89
BER	Bossiaea eriocarpa	Common Brown Pea	140mm	89
BOR	Bossiaea ornata	Broad Leaved Brown Pea	140mm	89
ССО	Chorizema cordatum	Heat Leafed Flamed Leaf	140mm	89
GOB	Grevillea obtusifolia	Leaved Grevillea	140mm	89
HSC	Hibbertia scandens	Snake Vine	140mm	89
KPR	Kennedia prostrata	Running Postman	140mm	89
LF0	Lechenaultia formosa	Red Lechenaultia	140mm	89
LLO	Lechenaultia lola		140mm	89

PLANT SCHEDULE (G1-00C)					
			AREA	RATE (per m2)	
PLAZA 2		Irrigated (Permanent)	251sqm	4	
Code	Botanical Name	Common Name	Size	Total	
ASC	Agrostocrinum scabrum	Blue Grass Lily	140mm	143	
AVI	Anigozanthos viridis	Green Kangaroo Paw	140mm	143	
BIBERIDI	Brachyscome iberidifolia	Swan River Daisy	140mm	143	
ВСО	Burchardia congesta	Milkmaids	140mm	143	
DTE	Dampiera teres	Terete-leaved Dampiera	140mm	143	
DRE	Dianella revoluta	Blue Flax Lily	140mm	143	
HPU	Hemiandra pungens	Snake Plant	140mm	143	
LBI	Lechenaultia biloba	Blue Lechenaultia	140mm	143	
LAN	Lobelia anceps	Angled Lobelia	140mm	143	
LLI	Lomandra little con	Mat Rush	140mm	143	
OLA	Orthrosanthus laxus	Morning Iris	140mm	143	
DLI	Dampiera linearis	Common Damperia	140mm	143	

	PLANT	SCHEDULE (G1-00)	ס)	
				RATE (per m2)
PLAY SP	ACE	Irrigated (Permanent)	365sqm	4
Code	Botanical Name	Common Name	Size	Total
AAP	Acacia applanata	Golden Grass Wattle	140mm	81
BNI	Banksia nivea	Honeypot Dryandra	140mm	81
CHI	Calothamnus hirsutus	Low Woolly Bush	140mm	81
DLI	Dampieria linearis	Western Blue	140mm	81
DRE	Dianella revoluta	Blue Flax Lily	140mm	81
GOB	Grevollea obtusifolia	Leaved Grivella	140mm	81
HSC	Hibbertia scandens	Snake Vine	140mm	81
TMU	Thysanotus multiflorus	Fringe Lily	140mm	81
DCI	Darwinia Citrodora	Lemon Scented Darwinia	140mm	81
MIN	Melelueca incana	Grey Honey Myrtle	140mm	81
CVI	Carpobrotus virescens	Coastal Pigface	140mm	81
MPA	Myoporum parvifolium	Boobialla	140mm	81


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	PLANT S	CHEDULE (G1-00E	ː)	
			AREA	RATE (per m2)
SHADE Irrigated (Permanent)			399sqm	3
Code	Botanical Name	Common Name	Size	Total
ALA	Acacia lasiocarpa, (prostrate)	Panjang	50mm Tube	200
ССО	Chorizema cordata	Heart Leafed Flamed Leaf	50mm Tube	200
GOB	Grevillea obtusifolia (prostrate)	Leaved Grevillea	140mm	200
HSC	Hibbertia scandens	Guinea Flower	140mm	200
MIN	Melaleuca incana	Grey honeymyrtle	50mm Tube	200
LLI	Lomandra little con	Mat Rush	140mm	200
BRE	Banksia repens	Creeping Banksia	140mm	200

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DETAILED DESIGN





REFERENCES	SCALE		DESIGNED	C.Holdsworth
			DRAWN	Y.Demissie
	DATUM		CHECKED	M.Harris
	HORIZONTAL:	PCG2020	APPROVED	J.Davis
	VERTICAL:	AHD71	DATE	10.07.23

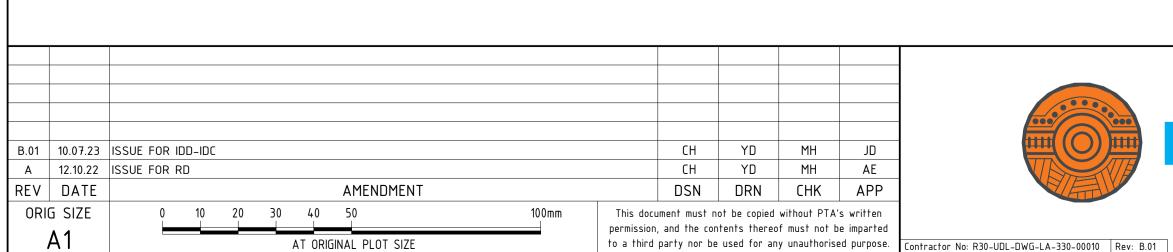Government of Western Australia
BYFORD RAIL EXTENSION

BYFORD STATION PRECINCT

LANDSCAPE
SCHEDULES SHEET 01

PTA Drawing No: 11-A-109-LA0014

Rev: B.01

PLANT SCHEDULE (G3-00A)					
			AREA	RATE (per m2)	
SWALE MIX Irrigated (Temporary)			5075sqm	8	
Code	Botanical Name	Common Name	Size	Total	
AEL	Austrostipa elegantissima	Feather Spear Grass	140mm	4060	
BJU	Baumea juncea	Bare Twig Rush	140mm	4060	
BAR	Baumea articulata	Jointed Rush	140mm	4060	
FNO	Ficinia nodosa	Knotted Club Rush	140mm	4060	
LCA	Lepidosperma calcicola	Coastal Sedge	140mm	4060	
MIN	Melaleuca incana	Grey Honeymyrtle	140mm	4060	

24360

	PLANT SC	HEDULE (G4-00	DA)	
			AREA	RATE (per m2)
REVEGETA	TION 1	Non-Irrigated	4841sqm	4
Code	Botanical Name	Common Name	Size	Total
APU	Acacia pulchella	Prickly Moses	50mm Tube	1210
CAC	Conostylis aculeata	Prickly Conostylis	50mm Tube	1210
EGL	Eremophila glabra	Emu Bush	50mm Tube	1210
POC	Patersonia occidentalis	Purple Flag	50mm Tube	1210
GTH	Grevillea thelemanniana (prostrate)	Spider Net Grevillea	50mm Tube	1210
HPU	Hemiandra pungens	Snake Bush	50mm Tube	1210
SIN	Scholtzia involucrata	Spiked Scholtzia	50mm Tube	1210
BER	Bossiaea eriocarpa	Common Brown Pea	50mm Tube	1210
AGL	Acacia glaucoptera	Flat Wattle	50mm Tube	1210
HLI	Hakea lissocarpa	Honey Bush	50mm Tube	1210
BIB	Brachyscome iberidifolia	Swan River Daisy	50mm Tube	1210
VPL	Verticordia plumosa	Plumed Featherflower	50mm Tube	1210
GCR	Grevillea crithmifolia (prostrate)	Little Crith	50mm Tube	1210
CFR	Calytrix fraseri A.Cunn	Pink Summer Caltyrix	50mm Tube	1210
GCA	Gastrolobium capitatum	Bacon & Eggs	50mm Tube	1210
GQU	Grevillea quercifolia	Oak leaved Grevillea	50mm Tube	1210

	PLANT SC	HEDULE (G4-00)B)	
			AREA	RATE (per m2)
REVEGETATION 2		Non-Irrigated	1870sqm	3
Code	Botanical Name	Botanical Name Common Name		Total
APU	Acacia pulchella	Prickly Moses	50mm Tube	701
CAC	Conostylis aculeata	Prickly Conostylis	50mm Tube	701
EGL	Eremophila glabra	Emu Bush	50mm Tube	701
POC	Patersonia occidentalis	Purple Flag	50mm Tube	701
GTH	Grevillea thelemanniana (prostrate)	Spider Net Grevillea	50mm Tube	701
HPU	Hemiandra pungens	Snake Bush	50mm Tube	701
SIN	Scholtzia involucrata	Spiked Scholtzia	50mm Tube	701
BER	Bossiaea eriocarpa	Common Brown Pea	50mm Tube	701
AGL	Acacia glaucoptera	Flat Wattle	50mm Tube	701
HLI	Hakea lissocarpa	Honey Bush	50mm Tube	701
BIB	Brachyscome iberidifolia	Swan River Daisy	50mm Tube	701
VPL	Verticordia plumosa	Plumed Featherflower	50mm Tube	701
GCR	Grevillea crithmifolia (prostrate)	Little Crith	50mm Tube	701
CFR	Calytrix fraseri A.Cunn	Pink Summer Caltyrix	50mm Tube	701
GCA	Gastrolobium capitatum	Bacon & Eggs	50mm Tube	701
GQU	Grevillea quercifolia	Oak leaved Grevillea	50mm Tube	701

11220

	PLANT SC	HEDULE (G4-0	0C)	
			AREA	RATE (per m2)
VERGES		Non-Irrigated	3866sqm	3
Code	Botanical Name	Common Name	Size	Total
ALA	Acacia lasiocarpa (prostrate)	Prostrate Wattle	50mm Tube	1933
CAC	Conostylis aculeata	Prickly Conostylis	140mm	1933
DPI	Darwinia pinifolia	Dwarf Dryandra	50mm Tube	1933
DRE	Dianella revoluta	Little Rev	14 0 m m	1933
EGL	Eremophila glabra	Emu Bush	140mm	1933
FNO	Ficinia nodosa	Knotted Club Rush	50mm Tube	1933
GTH	Grevillea thelemanniana (prostrate)	Spider Net Grevillea	50mm Tube	1933
GCR	Grevillea crithmifolia (prostrate)	Little Crith	50mm Tube	1933
HPU	Hemiandra pungens	Snake Bush	50mm Tube	1933

17397

	PLANT	SCHEDULE (G4-00	(םכ	
			AREA	RATE (per m2)
SWALE MIX		Non-Irrigated	2504sqm	8
Code	Botanical Name	Common Name	Size	Total
AEL	Austrostipa elegantissima	Feather Spear Grass	140mm	2862
BJU	Baumea juncea	Bare Twig Rush	140mm	2862
BAR	Baumea articulata	Jointed Rush	140mm	2862
FNO	Ficinia nodosa	Knotted Club Rush	140mm	2862
LCA	Lepidosperma calcicola	Coastal Sedge	140mm	2862
MIN	Melaleuca incana	Grey Honeymyrtle	140mm	2862

	PLANT SO	HEDULE (G4-00	E)	
		T	AREA	RATE (per m2)
PSHP EDG	iES	Non-Irrigated	2654sqm	3
Code	Botanical Name	Common Name	Size	Total
GTH	Grevillea thelemannian (prostrate)	Spider Net Grevillea	50mm Tube	531
EGL	Eremophila glabra	Emu Bush	50mm Tube	531
HR0	Hypocalymma robustum	Swan River Mrytle	50mm Tube	531
DRE	Dianella revoluta	Flax Lily	140mm	531
FN0	Ficinia nodosa	Knotted Club Rush	140mm	531
GCR	Grevillea crithmifolia (prostrate)	Little Crith	50mm Tube	531
CAC	Conostylis aculeata	Prickly Conostylis	50mm Tube	531
CJU	Conostylis juncea	Running Postman	50mm Tube	531
AHU	Alyogyne huegelii	Native Hibiscus	50mm Tube	531
HPU	Hemiandra pungens	Snake Bush	14 0 m m	531
BIB	Brachyscome iberidifolia	Swan River Daisy	50mm Tube	531
CFR	Calytrix fraseri A.Cunn	Pink Summer Caltyrix	50mm Tube	531
DCI	Darwinia citriodora	Lemon Scented Darwinia	140mm	531
DPH	Daviesia physodes	Fire Bush	50mm Tube	531
AGL	Acacia glaucoptera	Flat Wattle	50mm Tube	531

7962

A.01 10.07.23 ISSUE FOR IDD-IDC

REV DATE

ORIG SIZE

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A 1 ORIGINAL PLOT SIZE

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AT ORIGINAL PLOT SIZE

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Ocentractor No. R30-UDL-DWG-LA-330-00011 Rev. A.01



REFERENCES	SCALE		DESIGNED	C.Holdsworth
			DRAWN	Y.Demissie
	DATUM		CHECKED	M.Harris
	HORIZONTAL:	PCG2020	APPROVED	J.Davis
	VERTICAL:	AHD71	DATE	10.07.23

DETAILED DESIGN

Government of Western Australia
BYFORD RAIL EXTENSION

BYFORD STATION PRECINCT
LANDSCAPE
SCHEDULES SHEET 02

PTA Drawing No: 11-A-109-LA0015


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B.01 10.07.23 ISSUE FOR IDD-IDC

A 12.10.22 ISSUE FOR RD

CH YD MH AE

REV DATE

ORIG SIZE
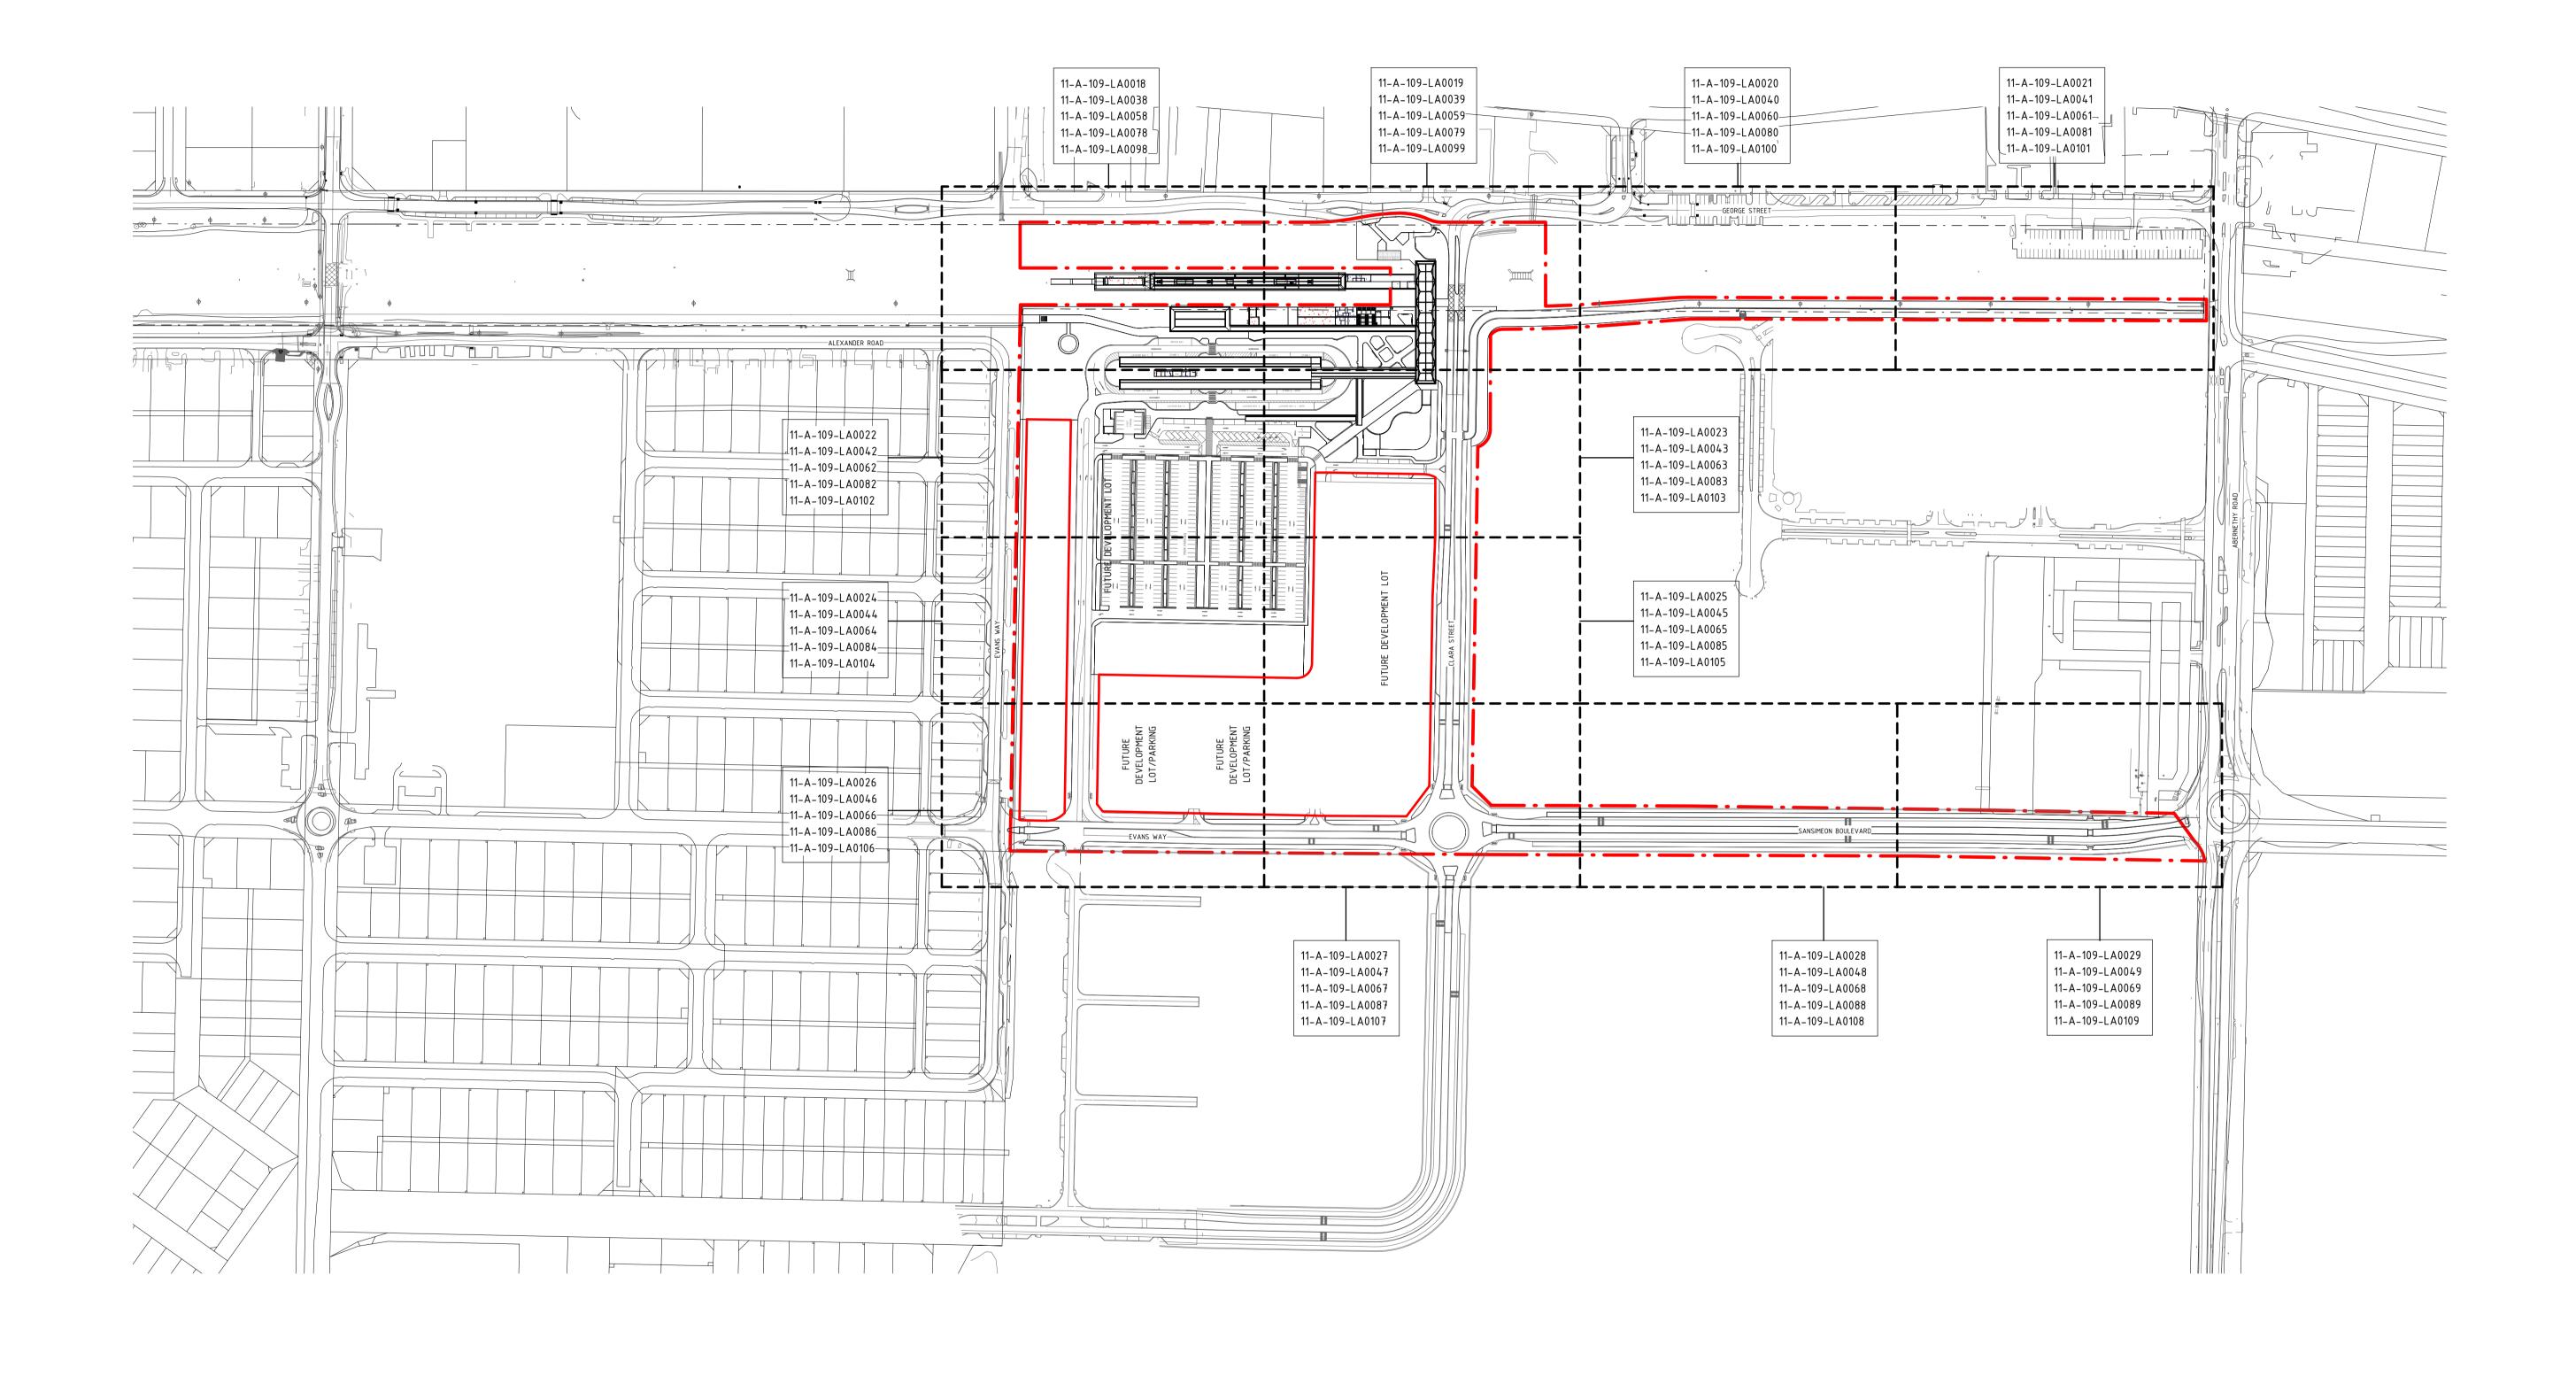
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AT ORIGINAL PLOT SIZE

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Contractor No: R30-UDL-DWG-LA-330-00021 Rev: B.01


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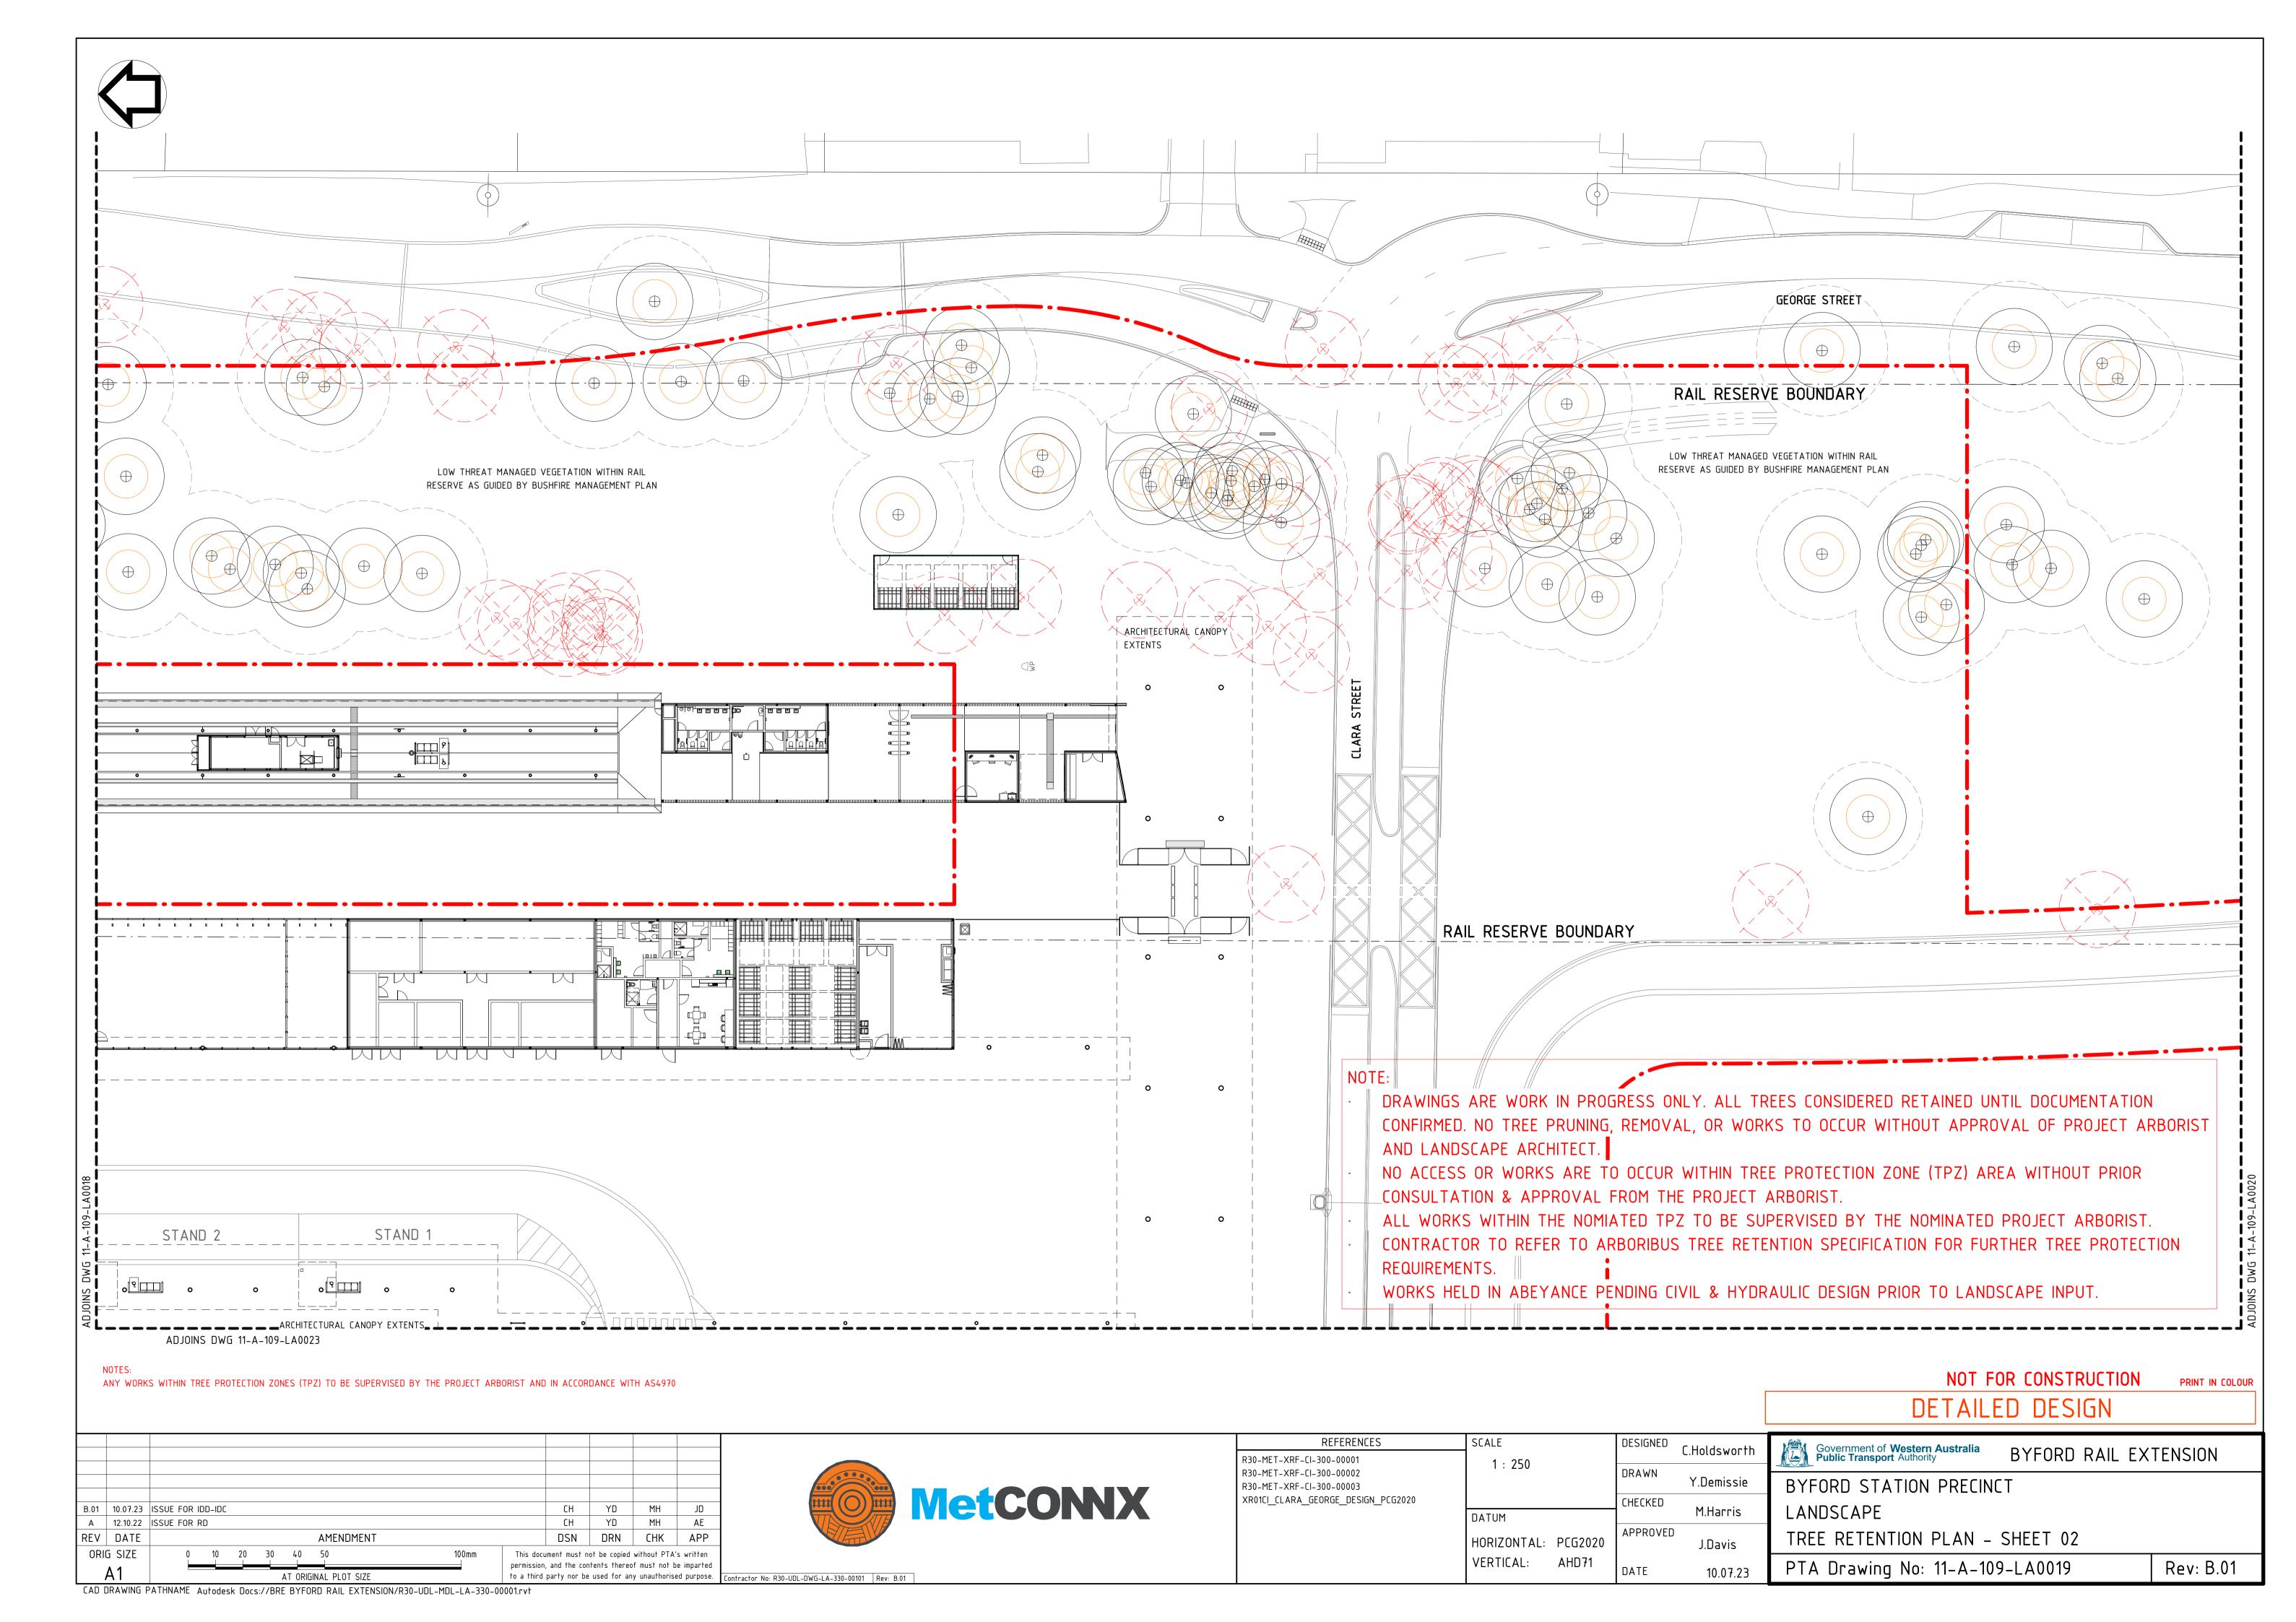



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	DATUM			M.Harris
	LIODIZONEAL	Deconon	APPROVED	
	HORIZONTAL:	PLG2020		J.Davis
	VERTICAL:	AHD71	DATE	10 07 22


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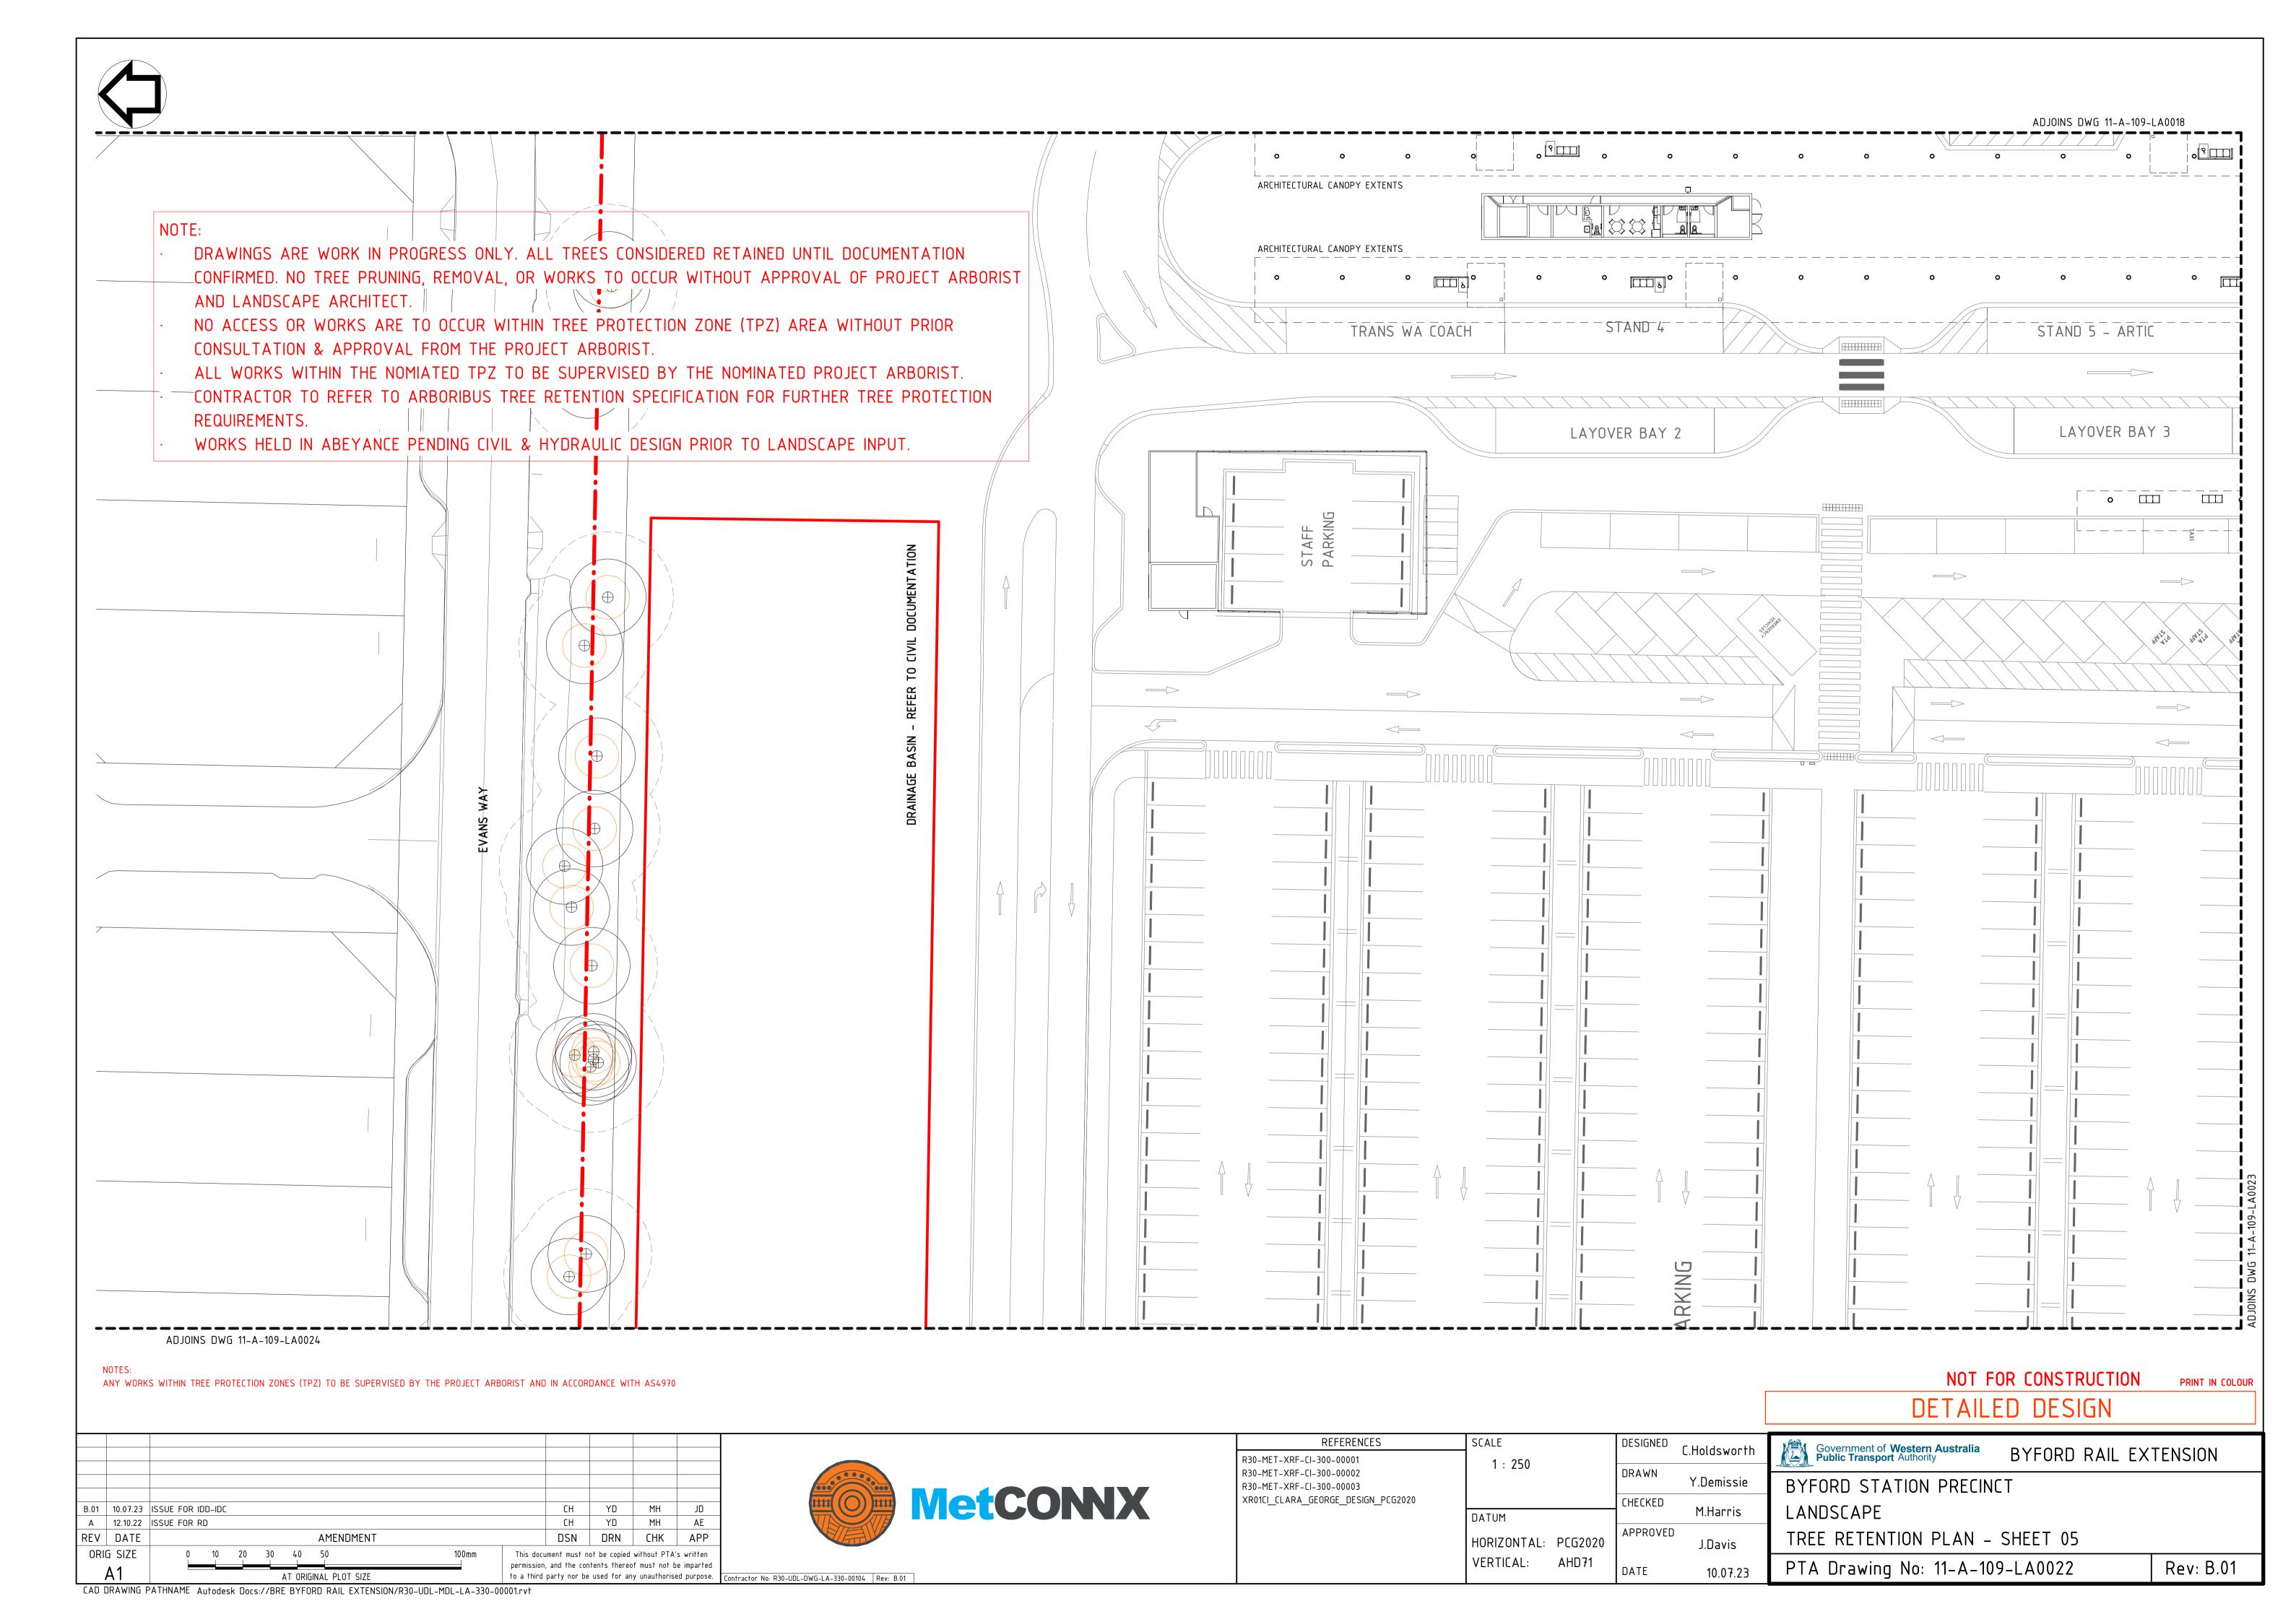
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LANDSCAPE				
SHEET LAYOUT PLAN				
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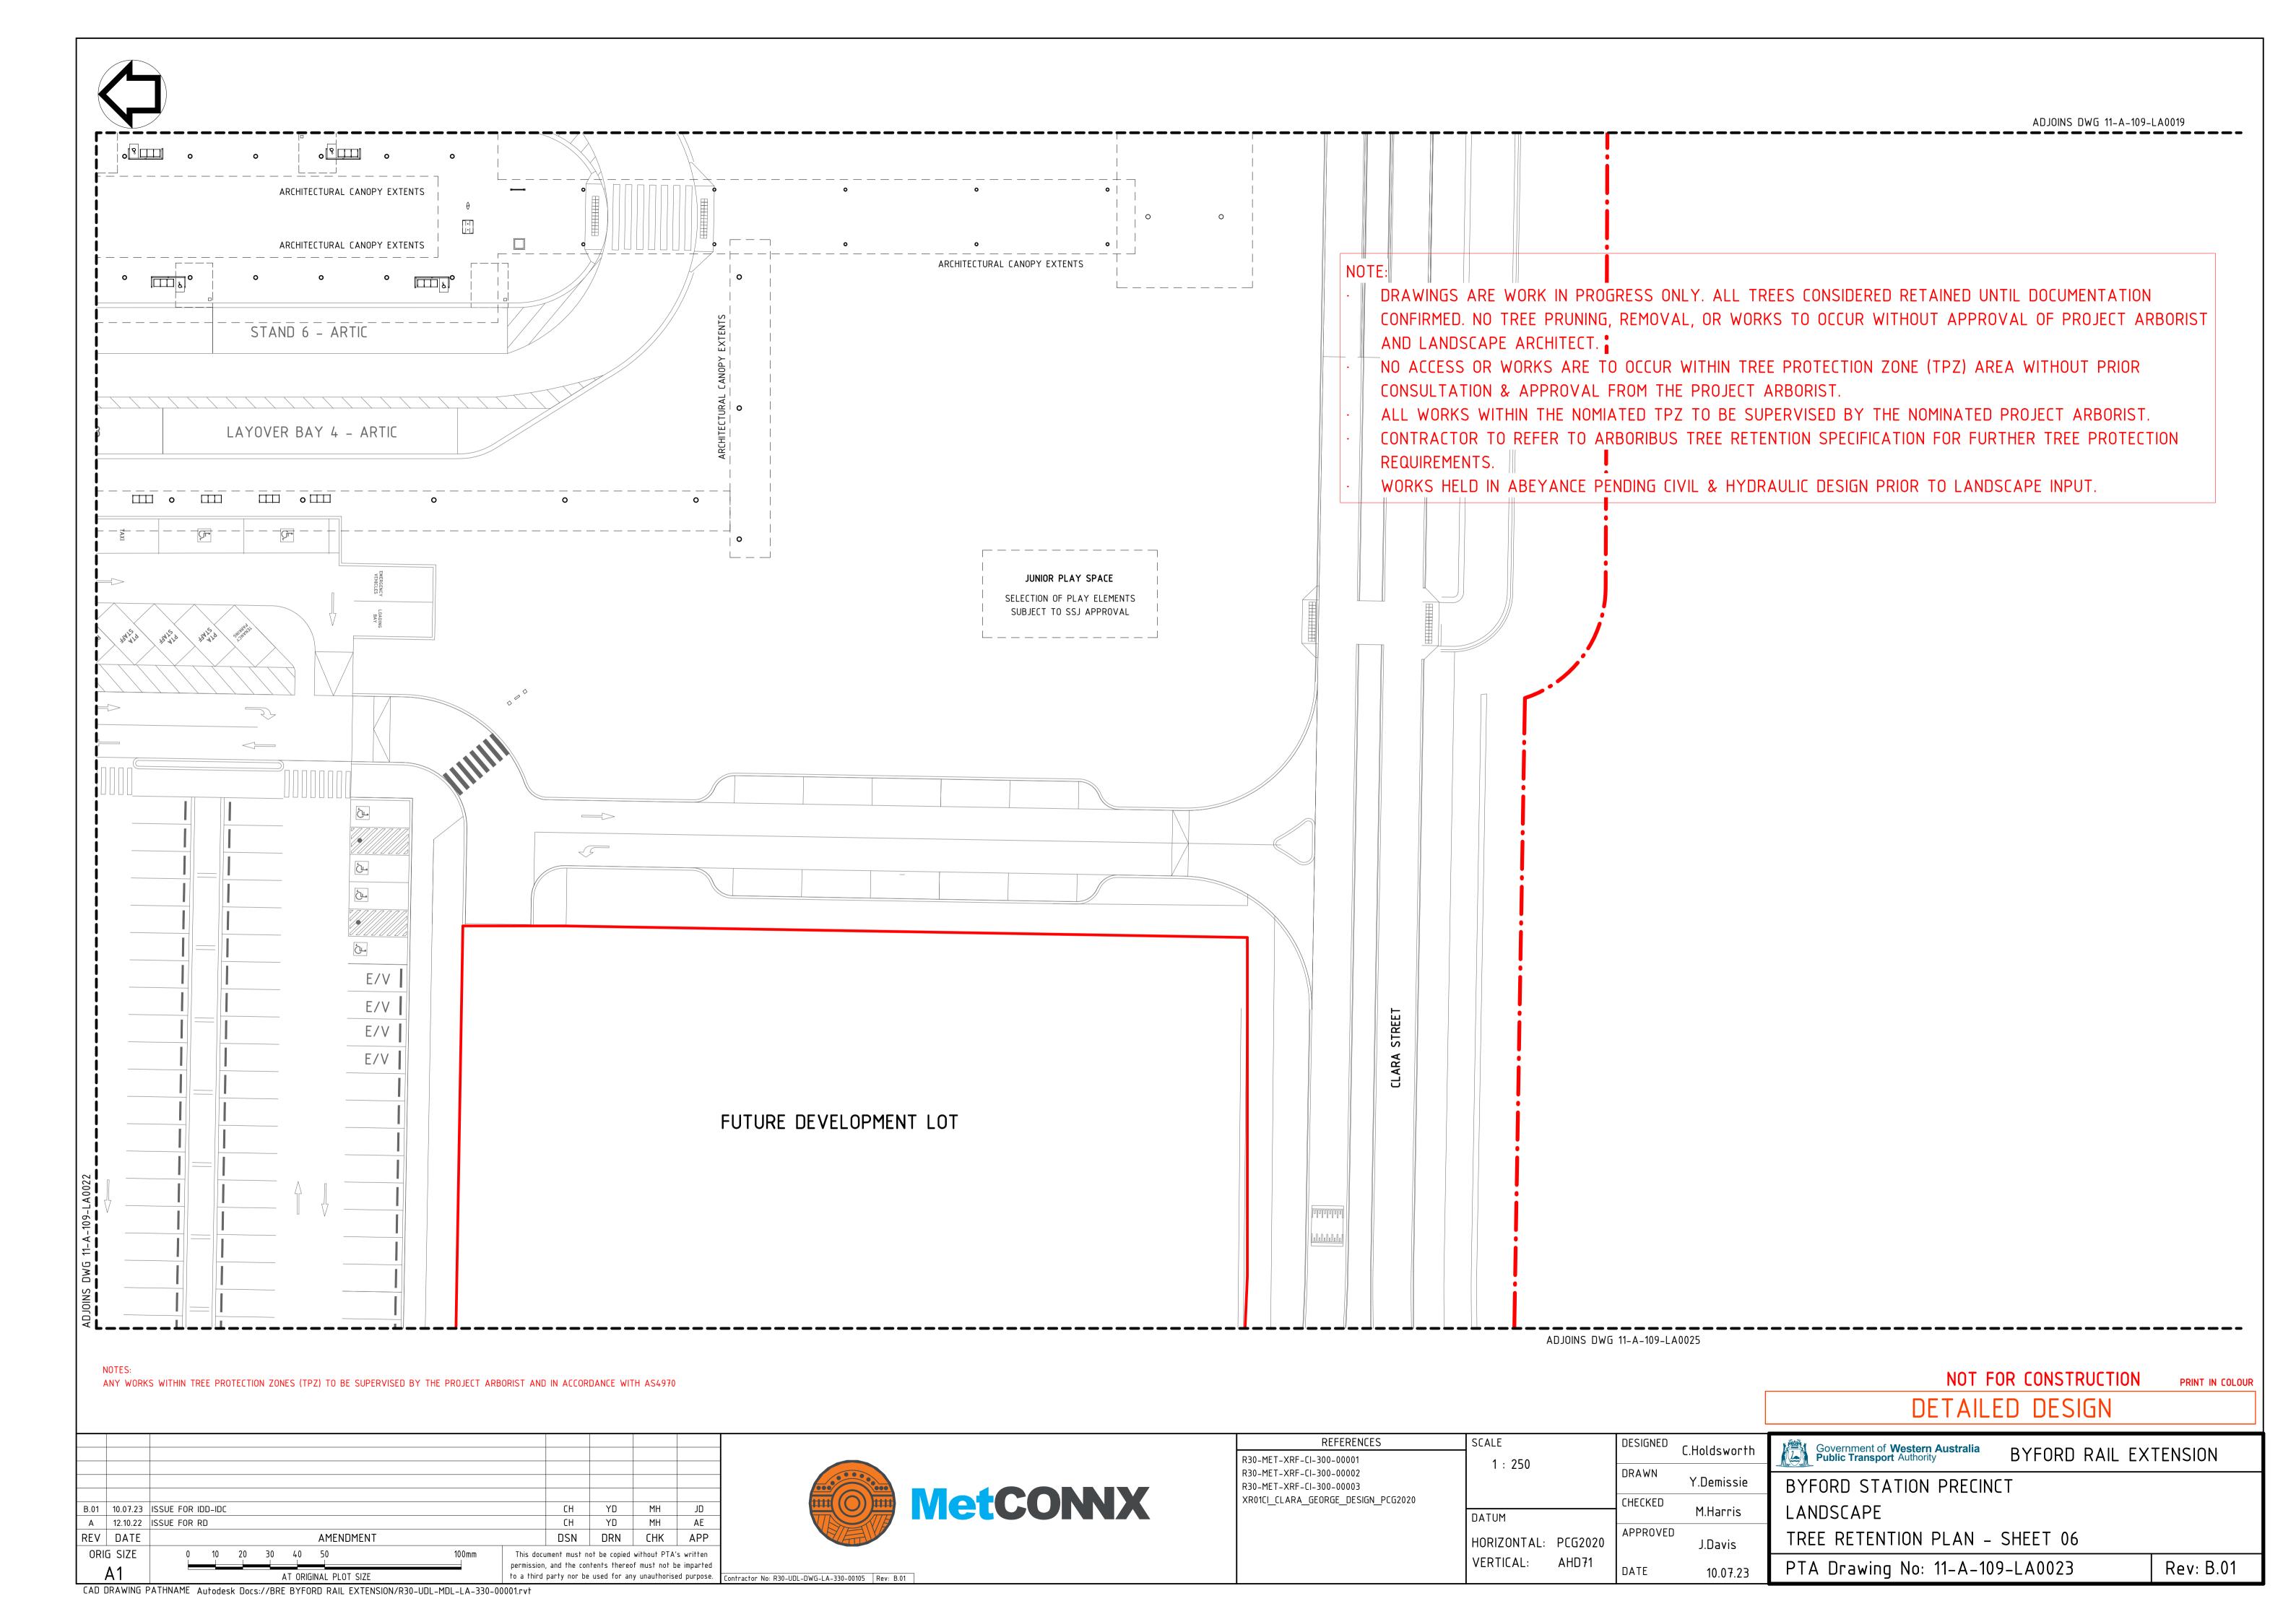








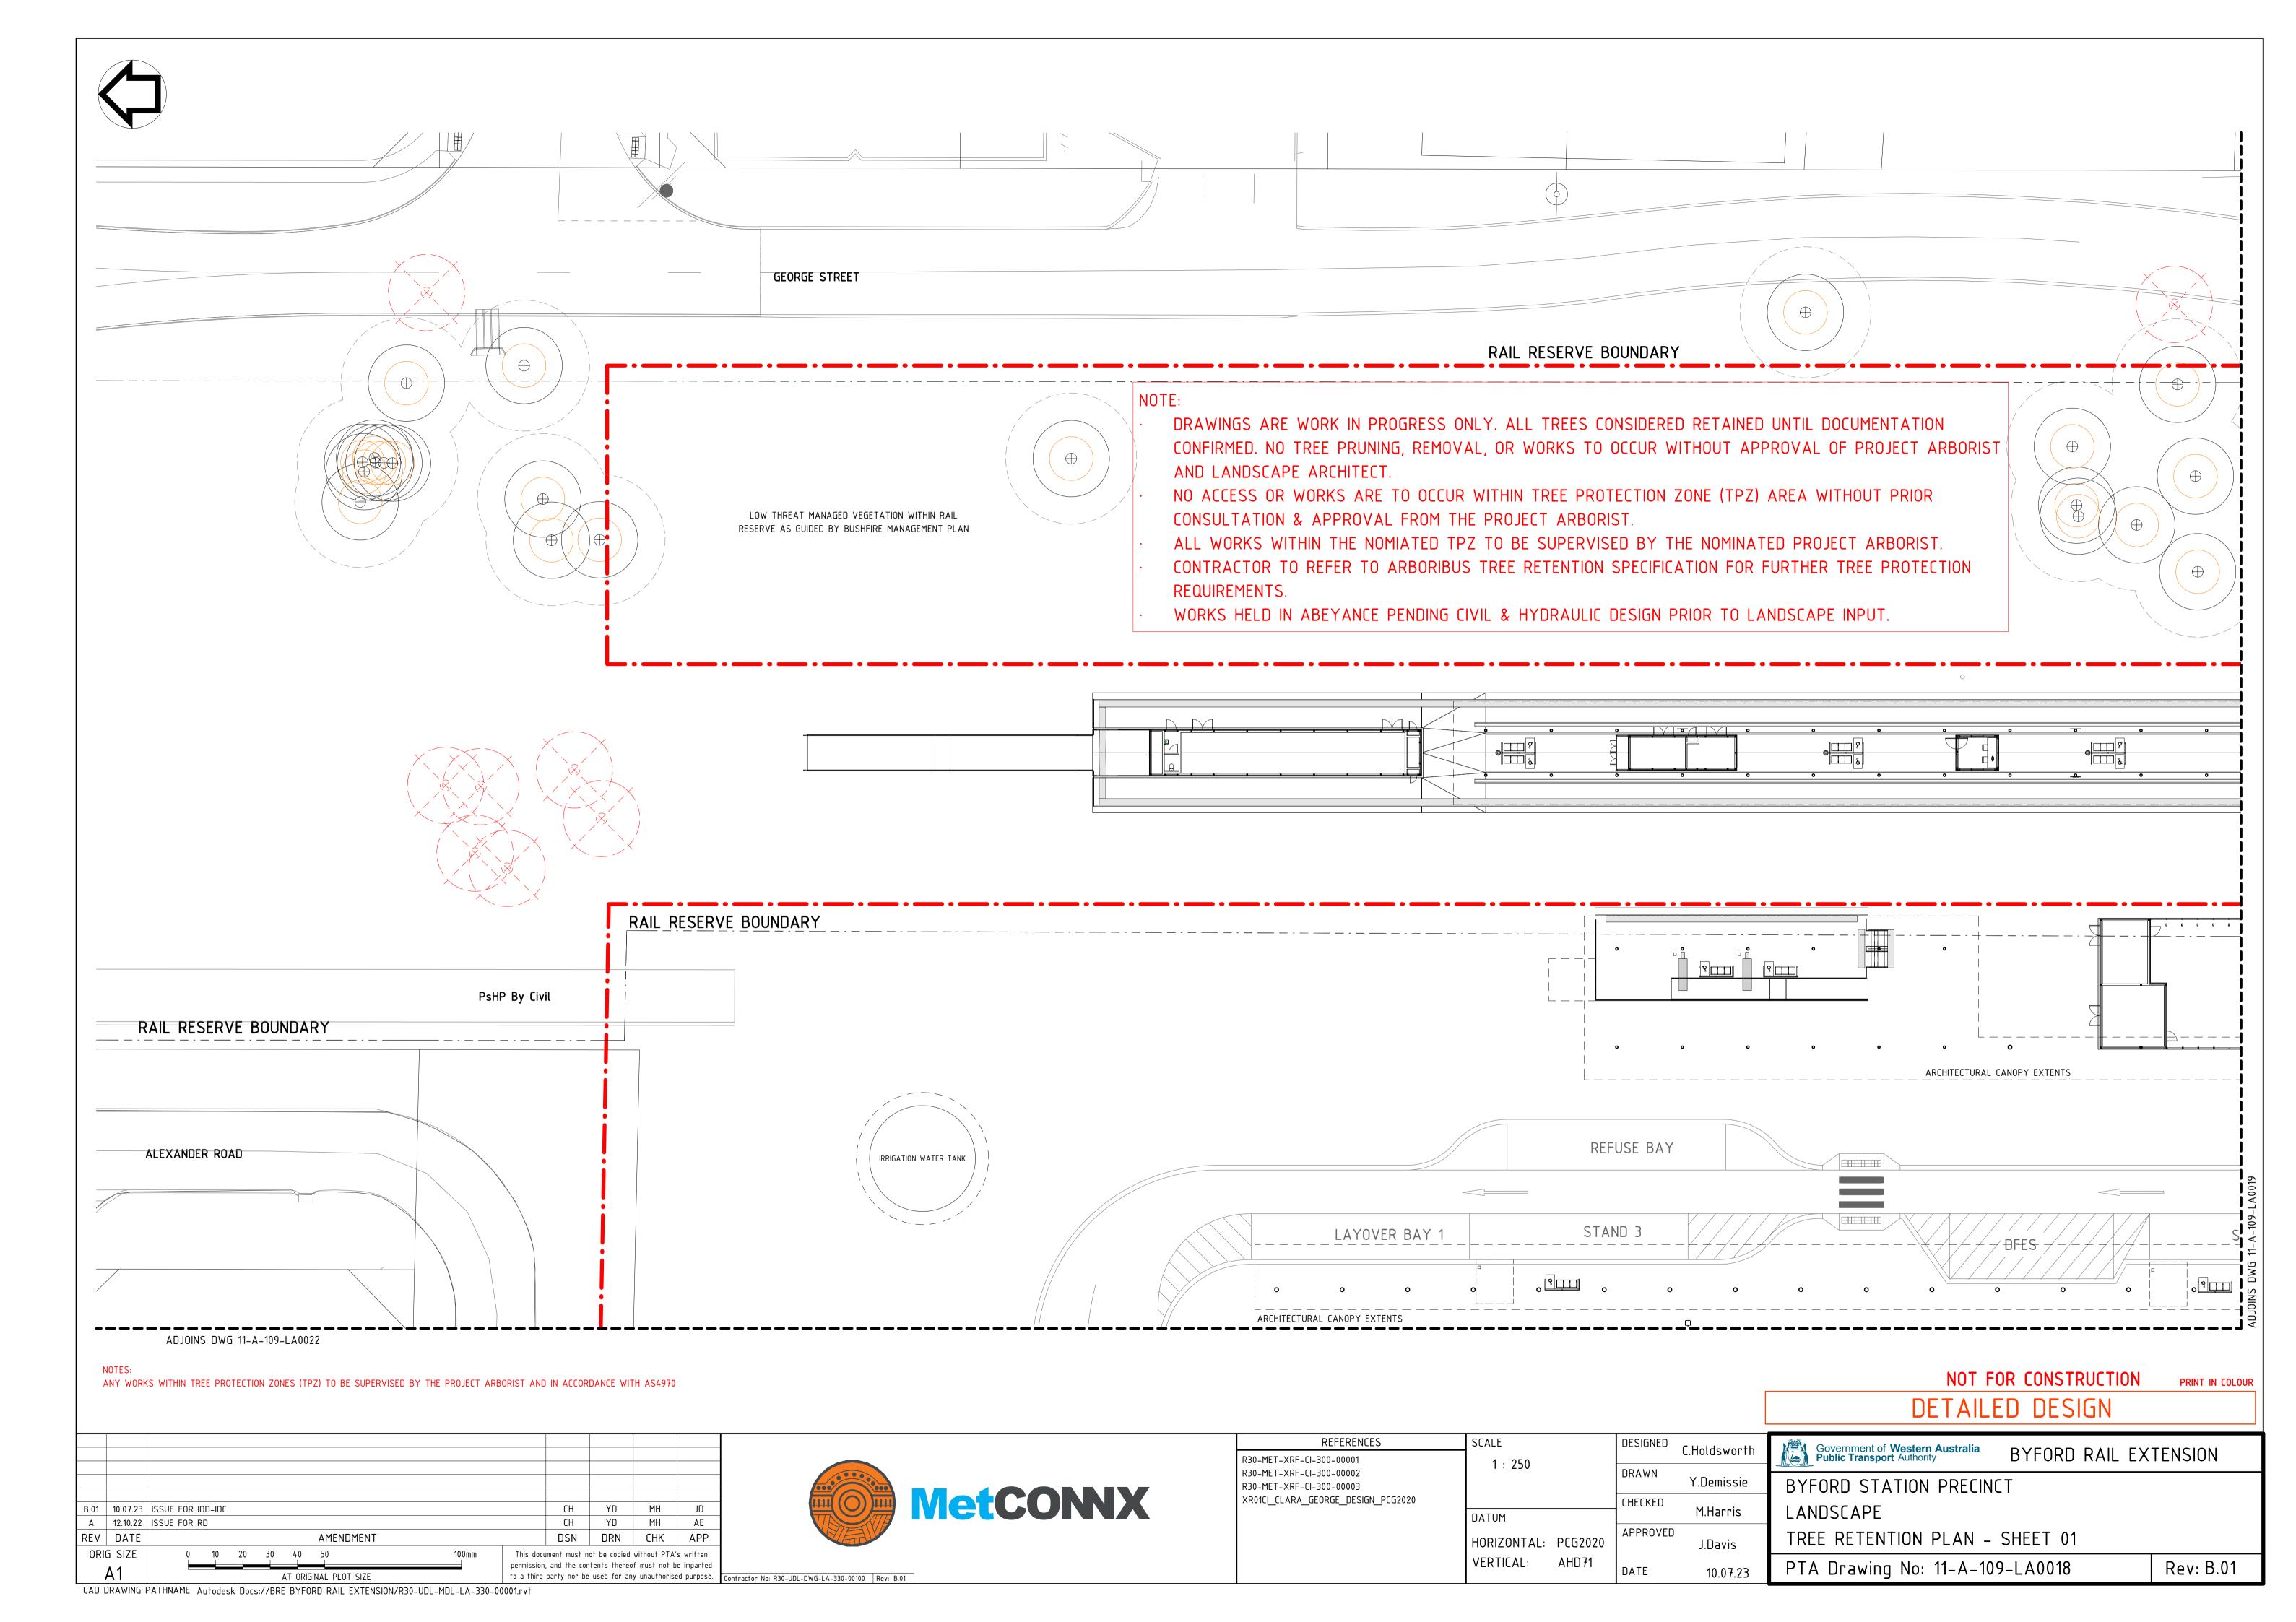


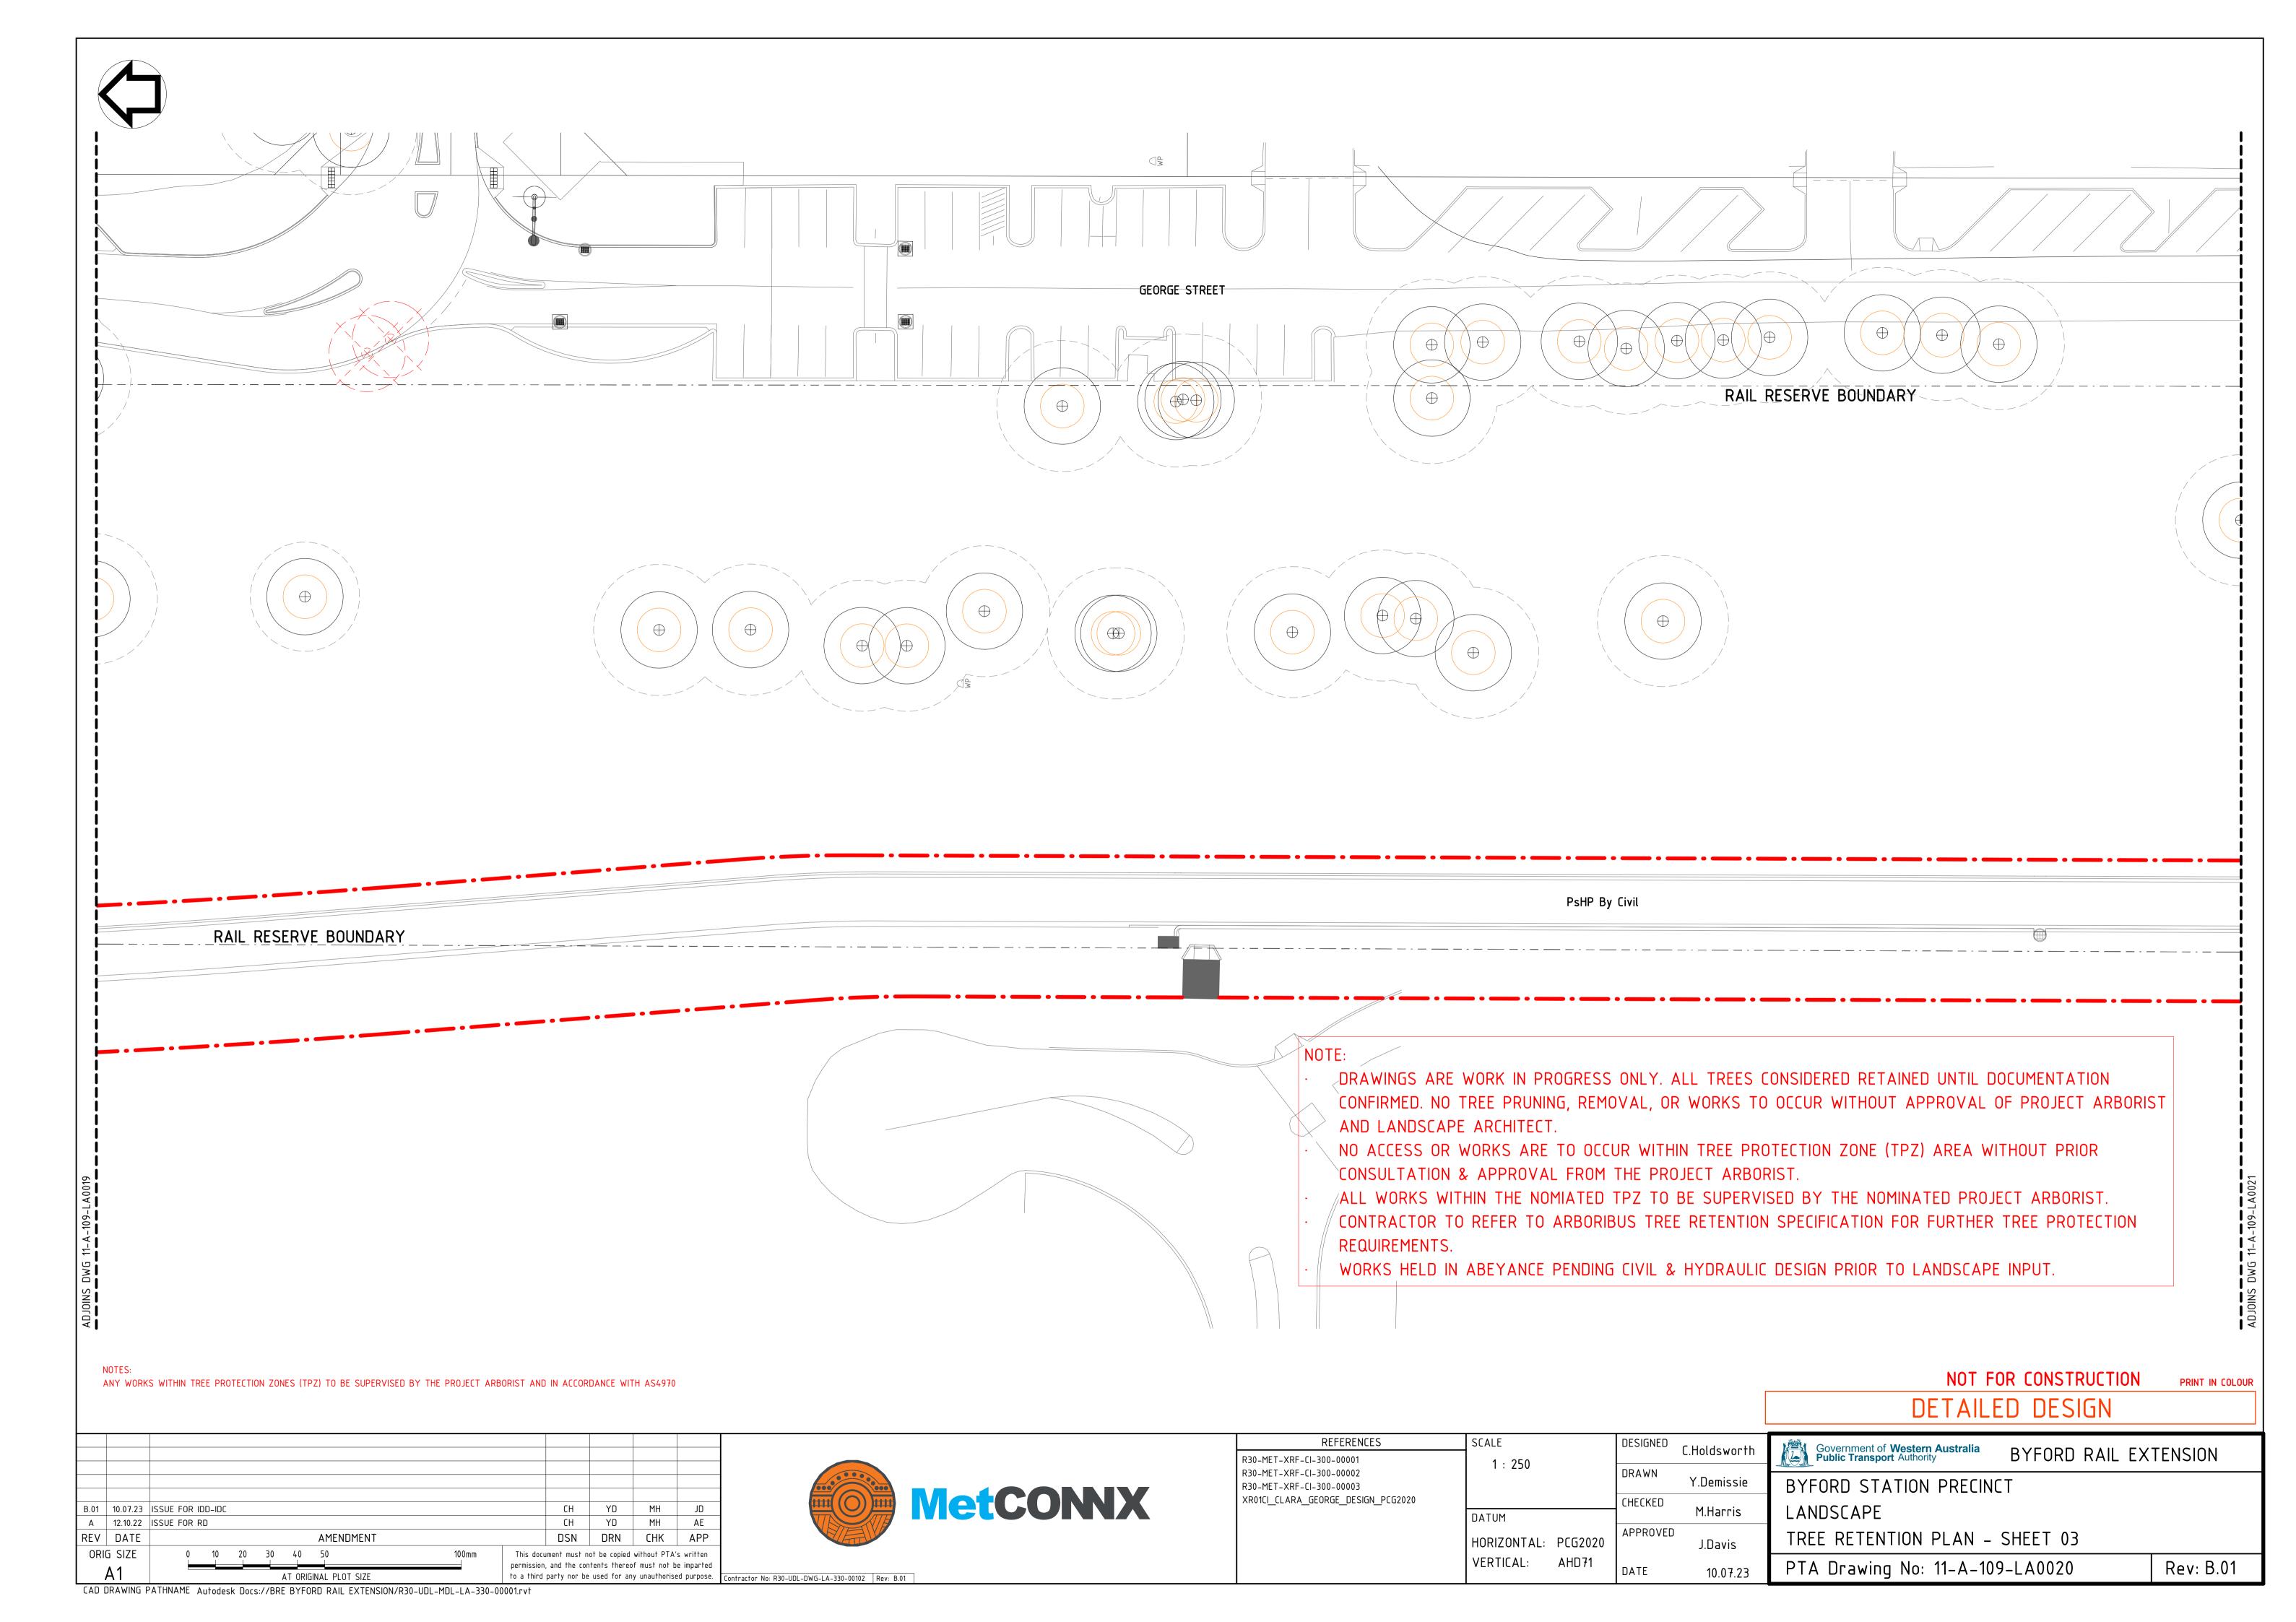


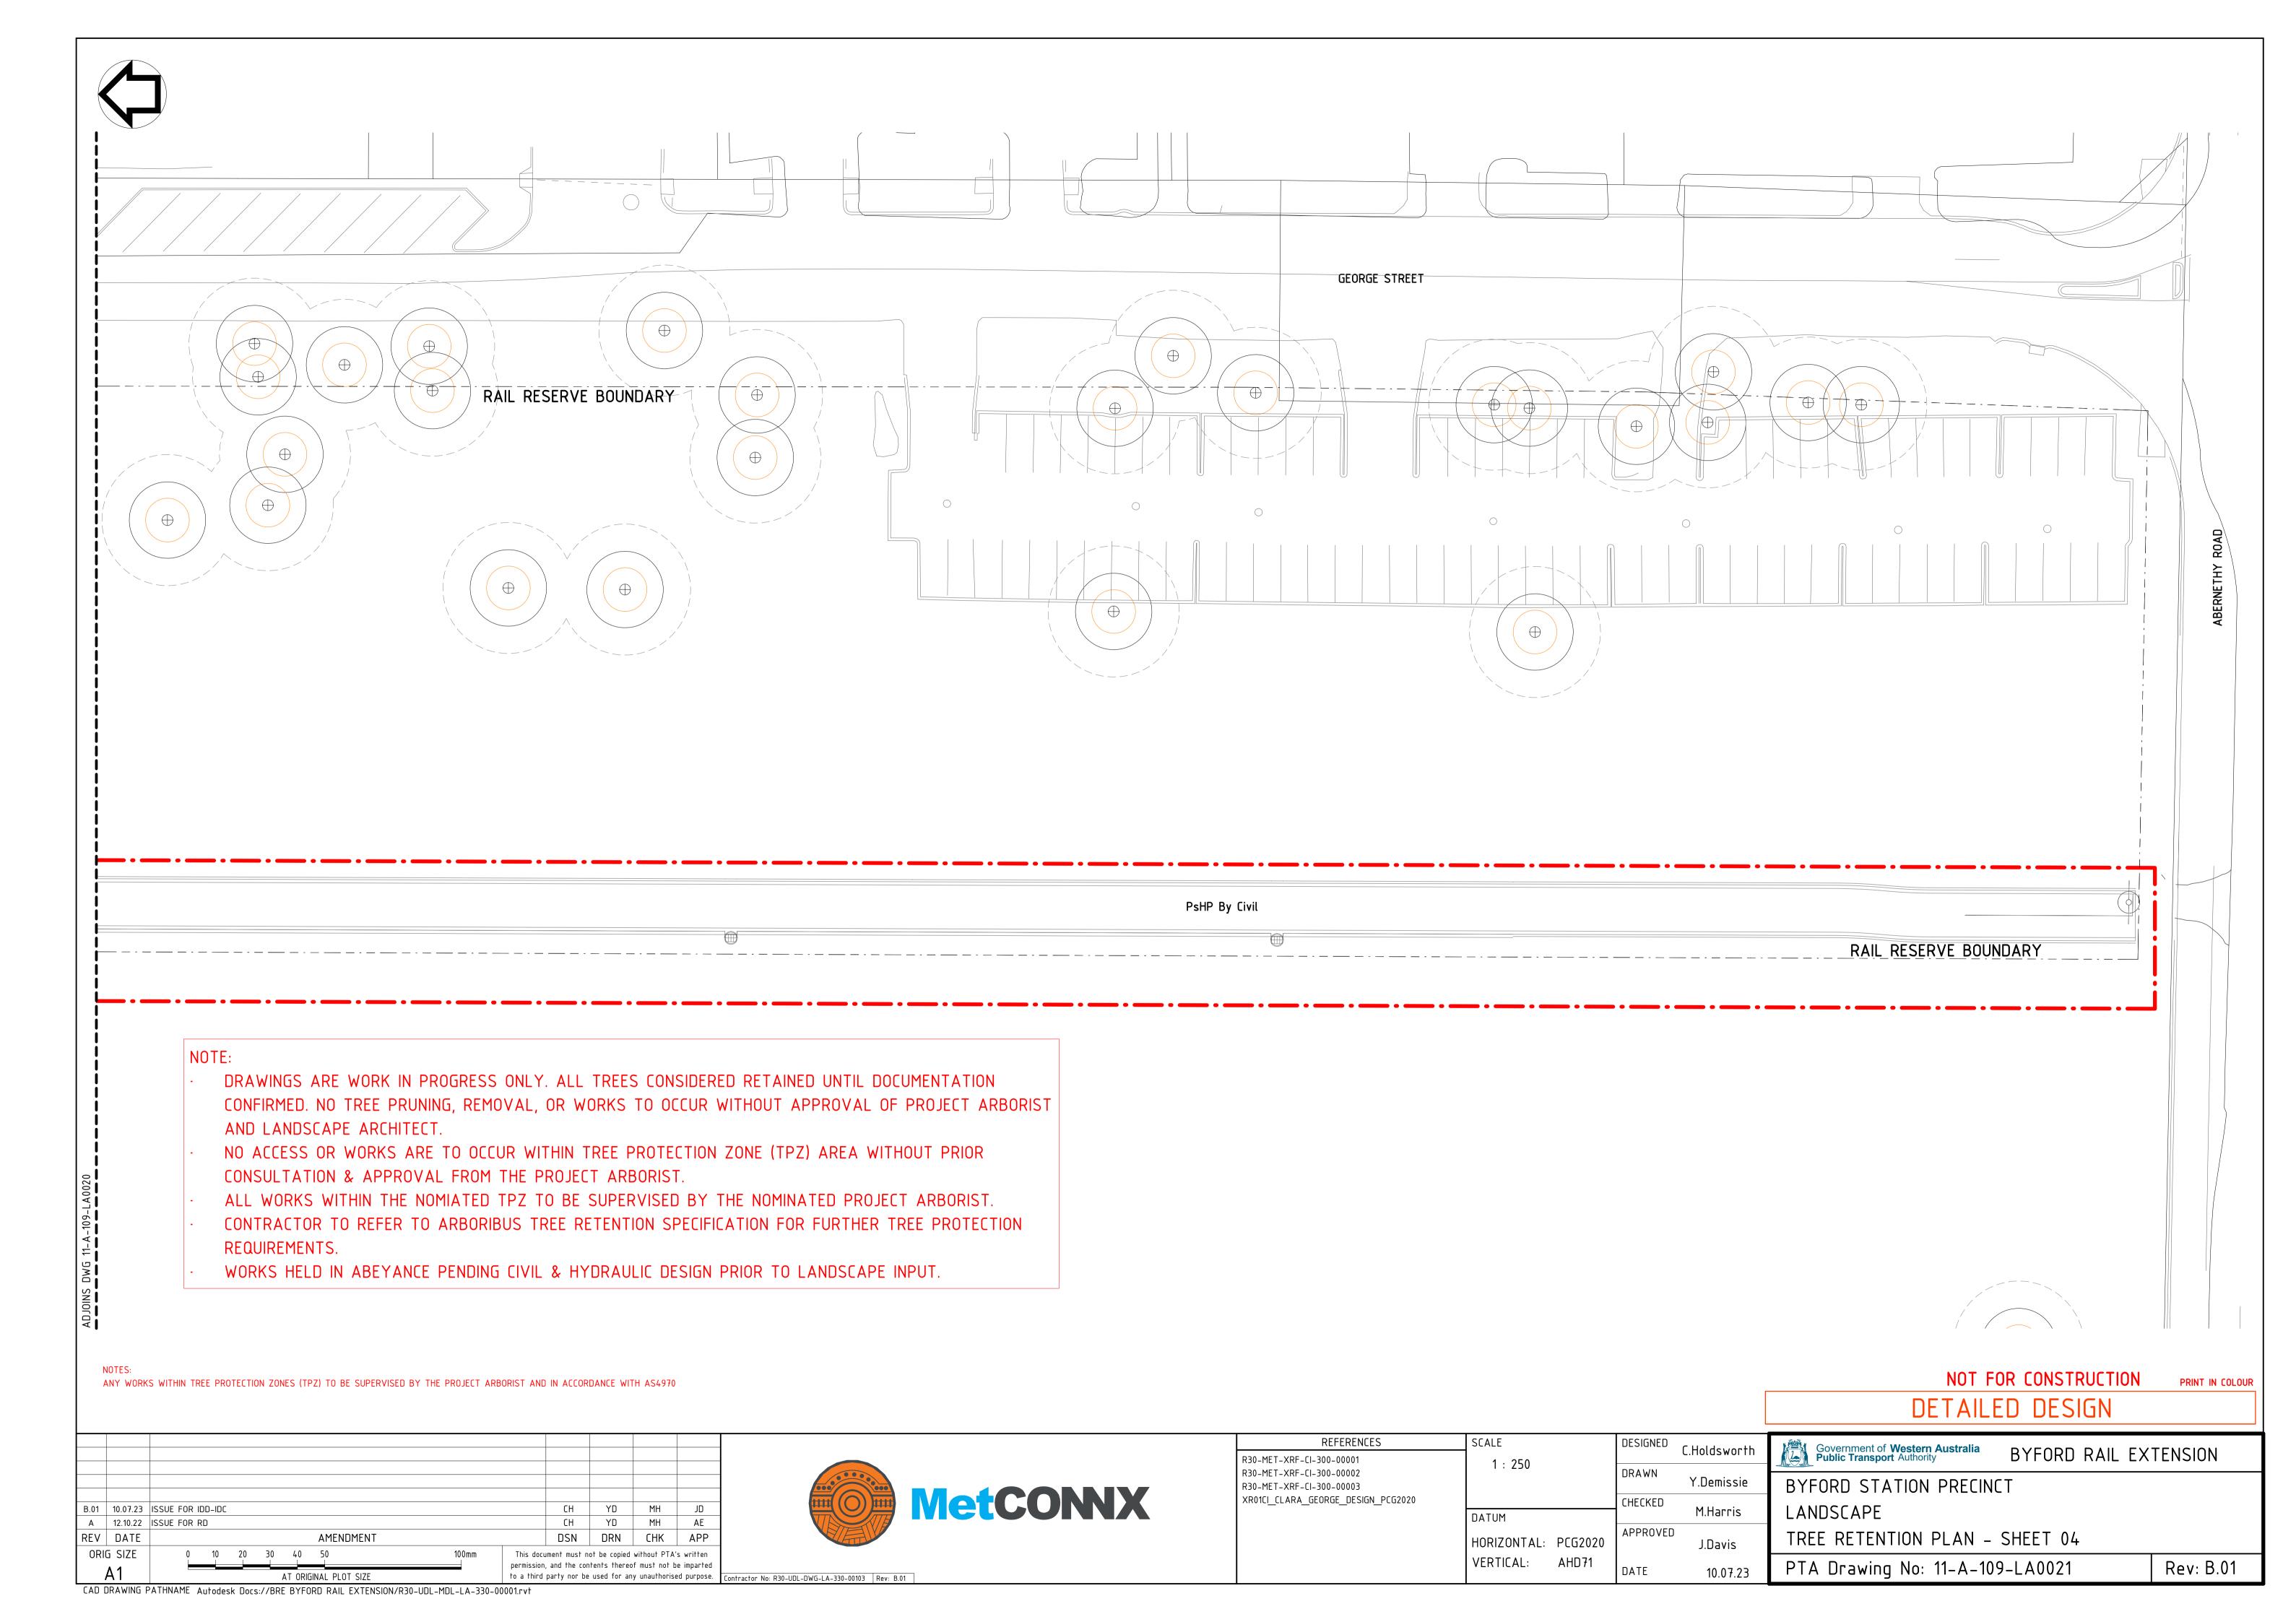

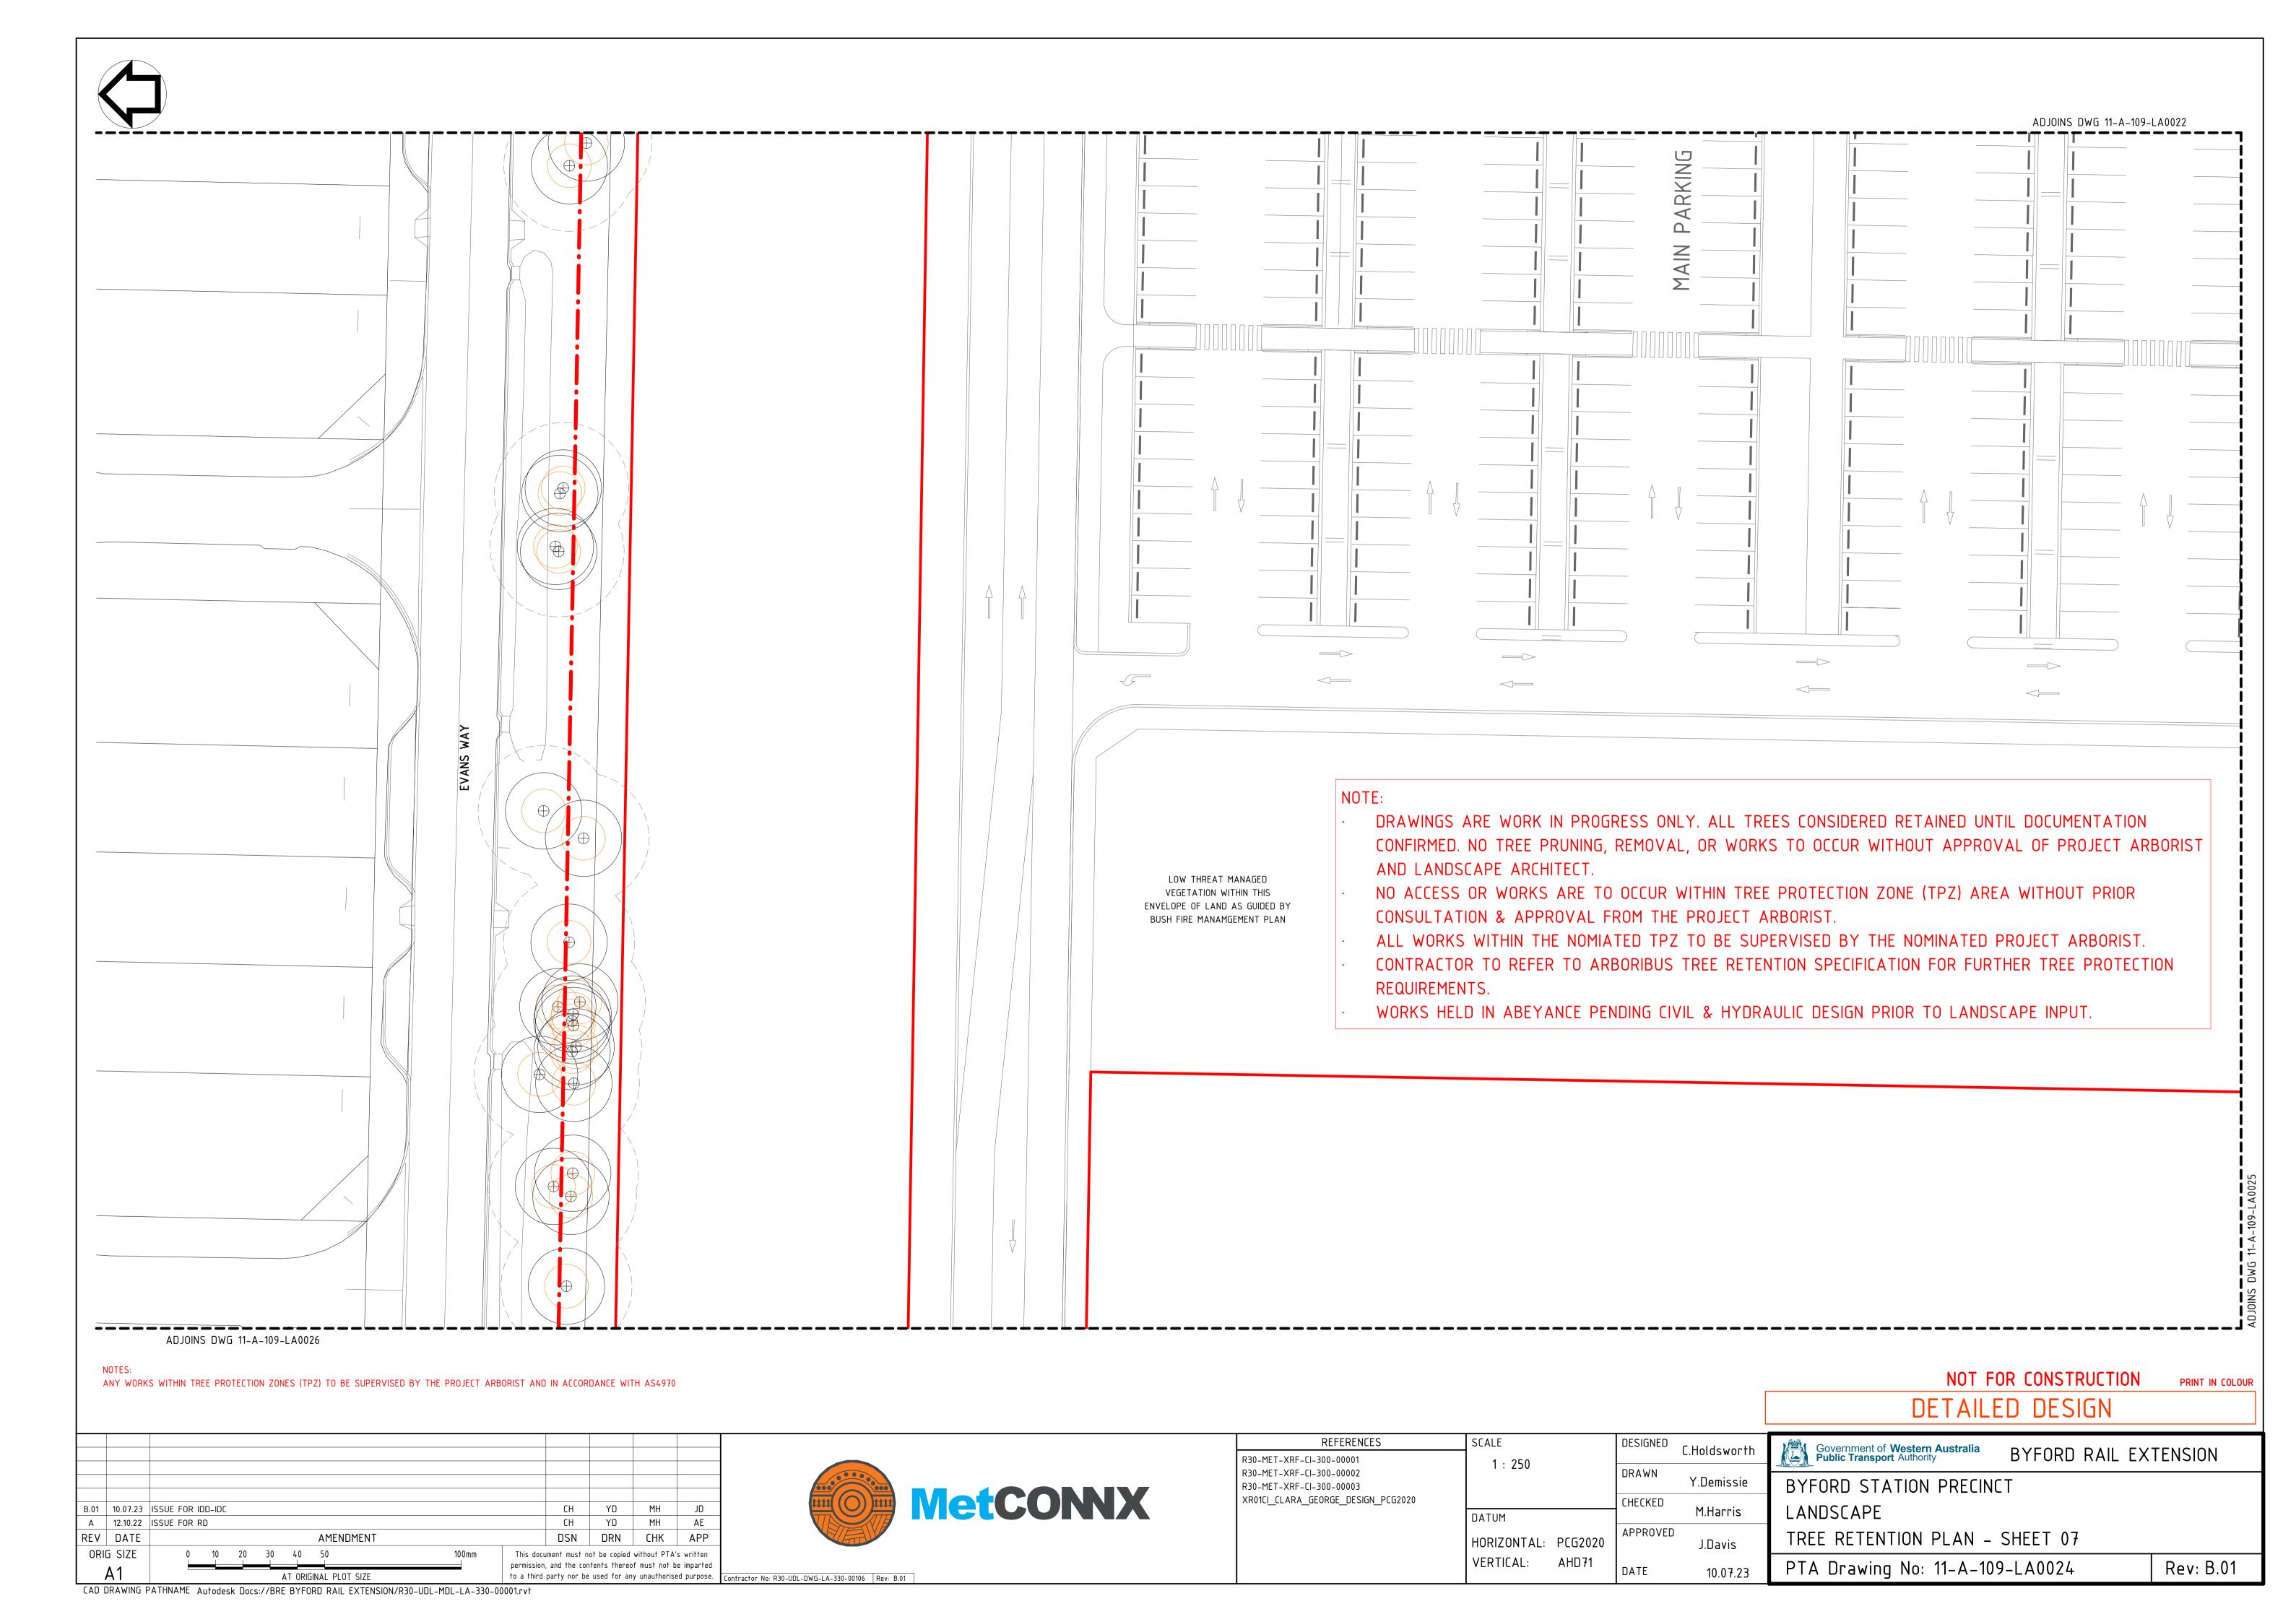

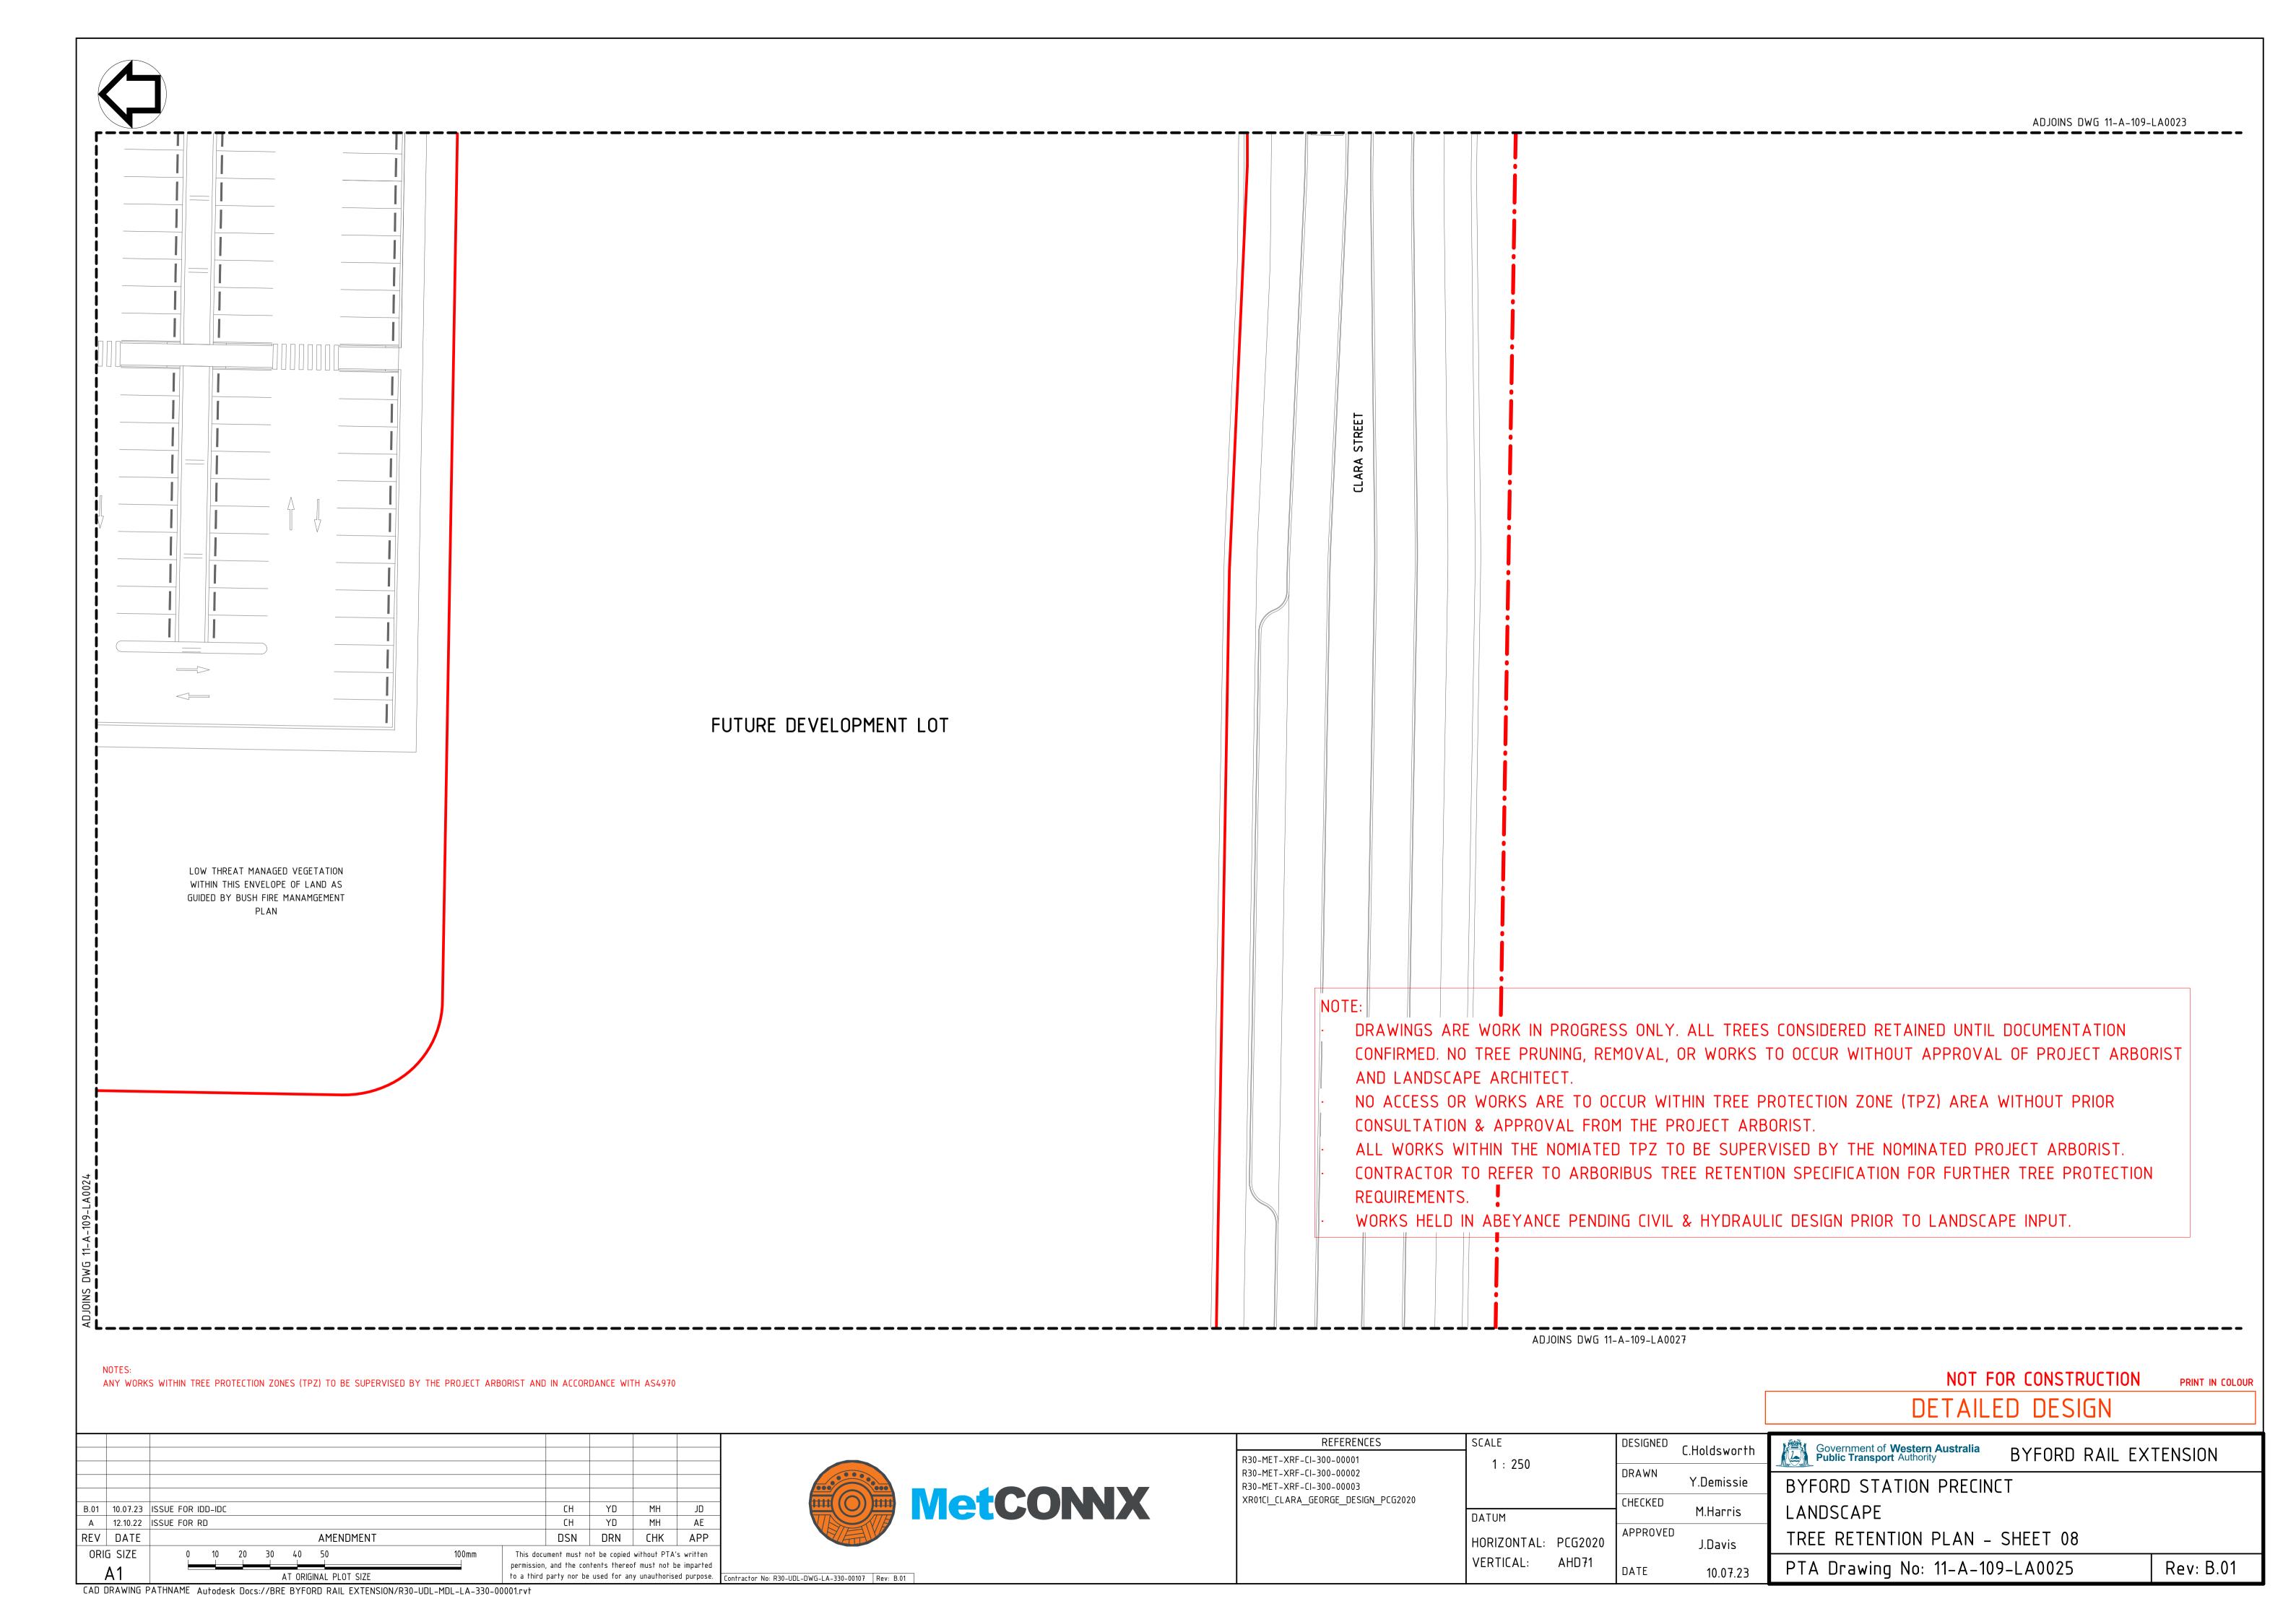

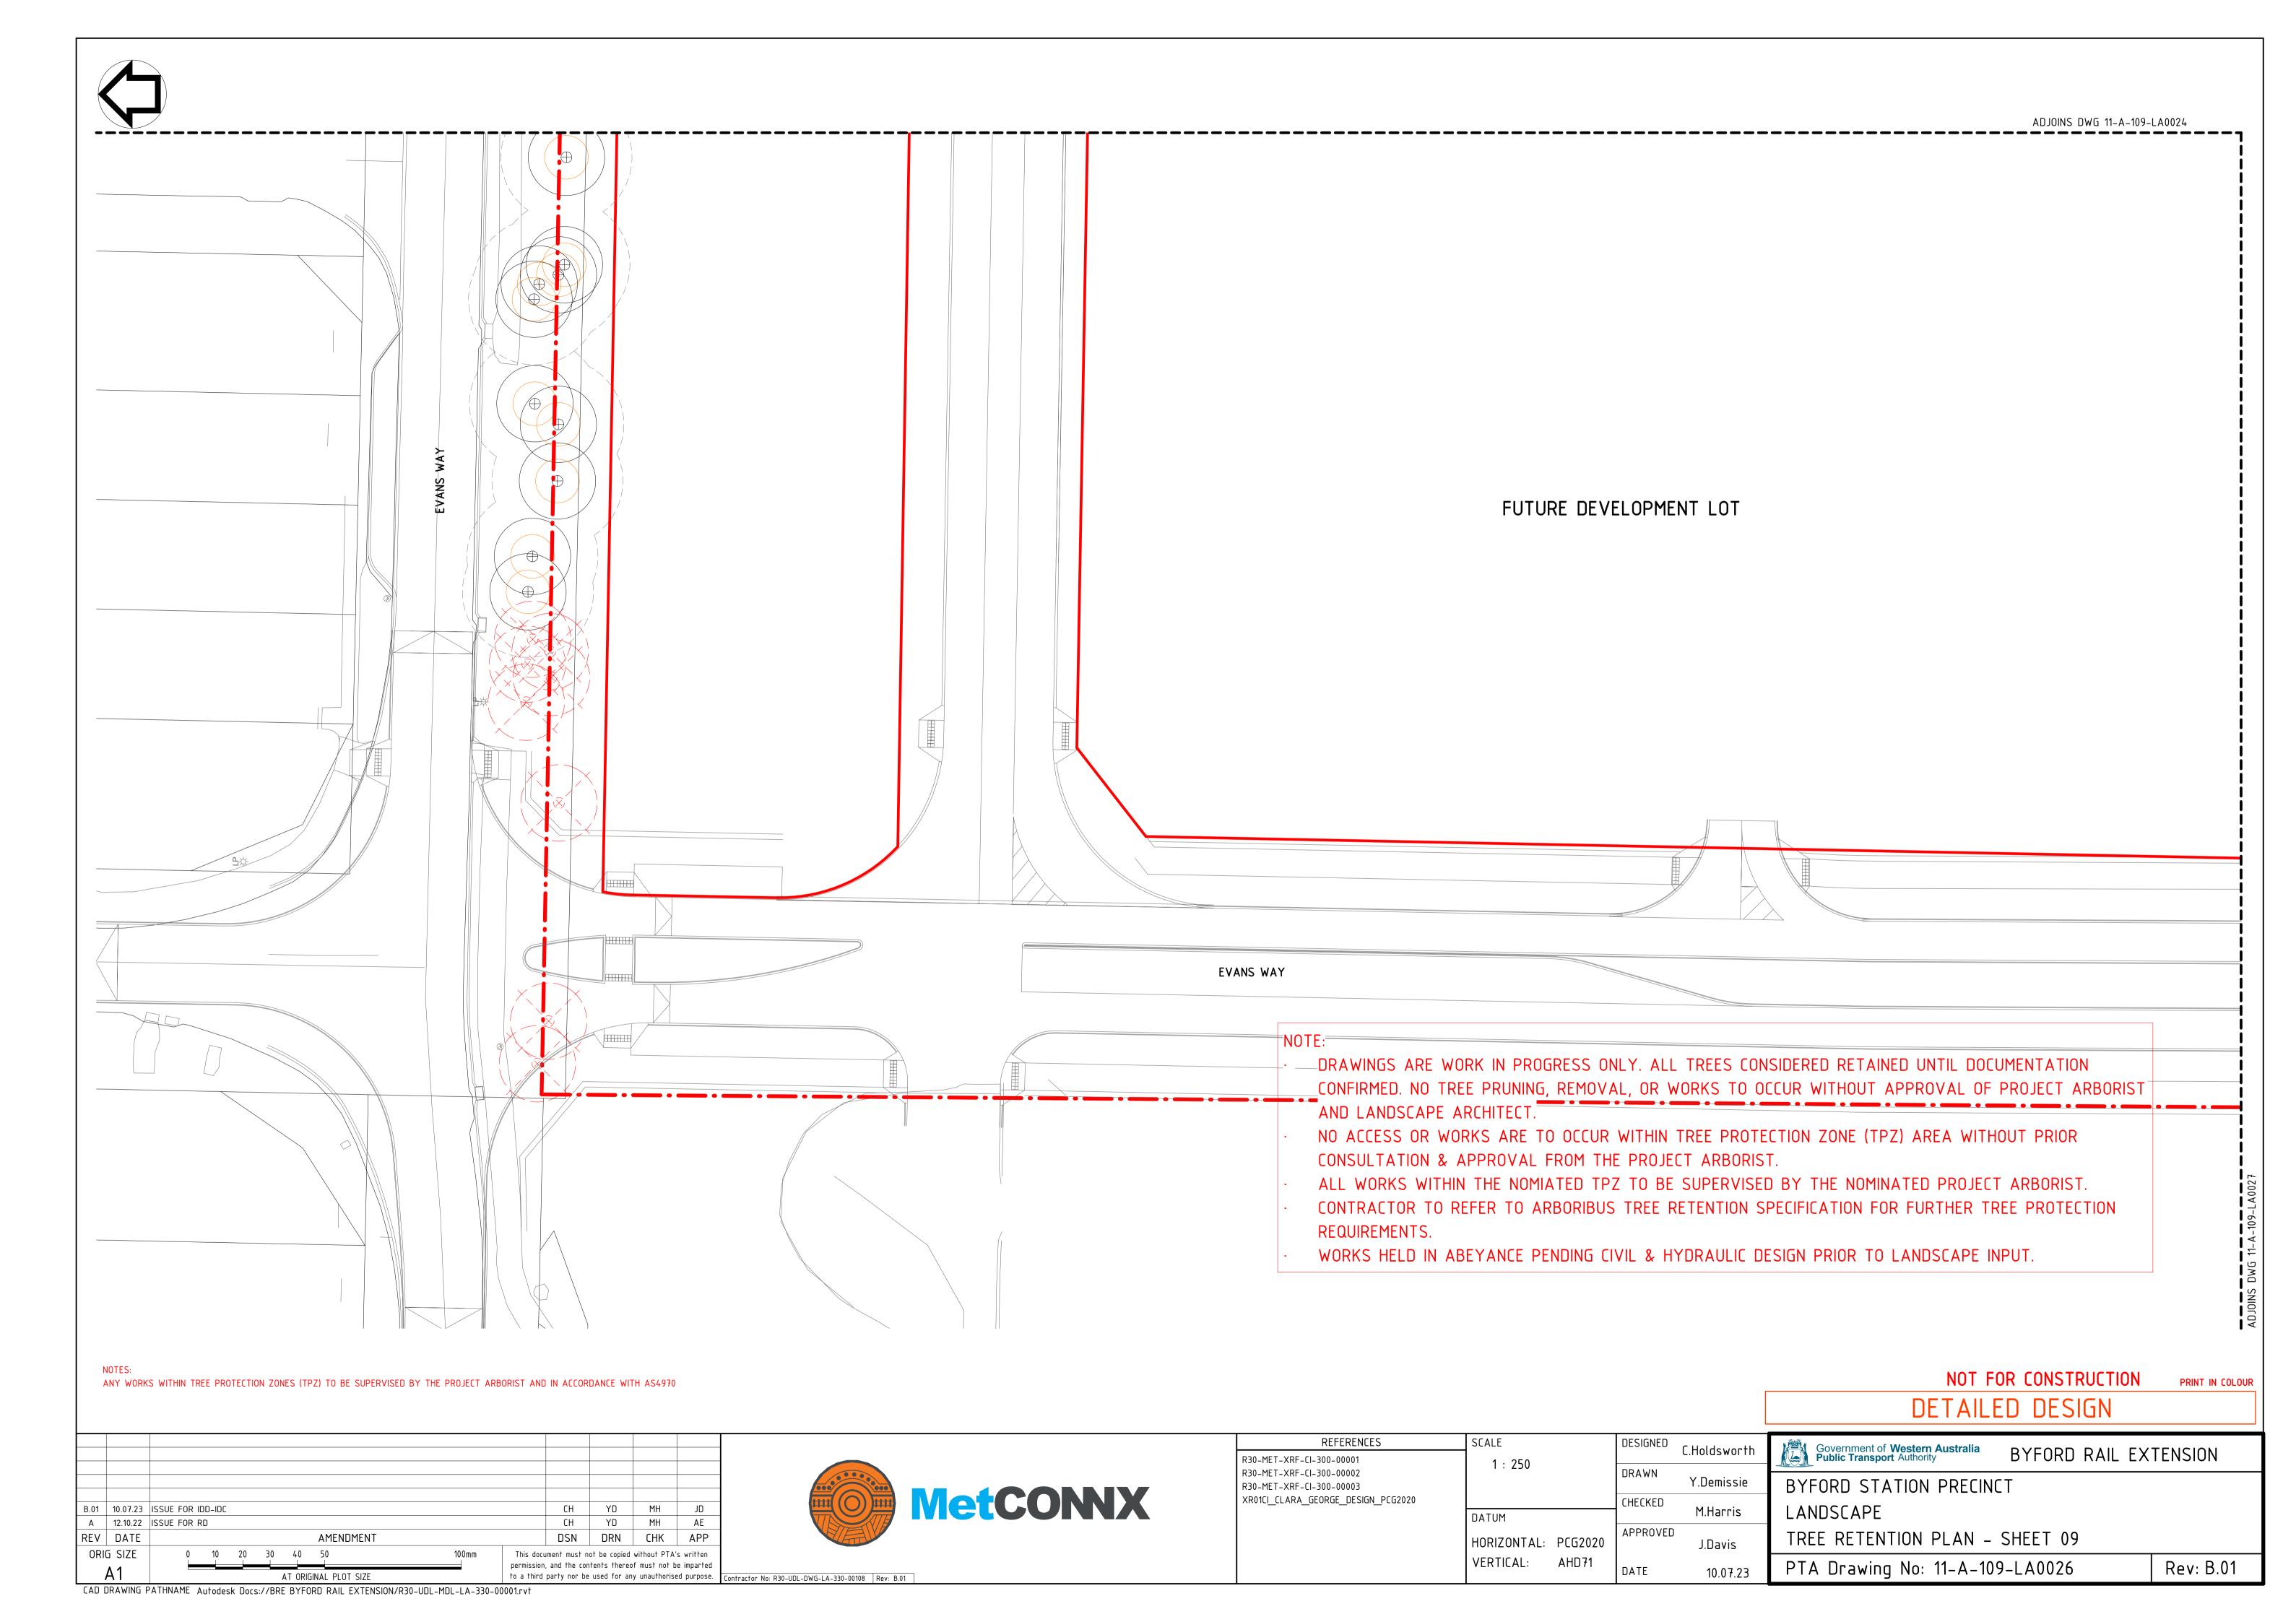

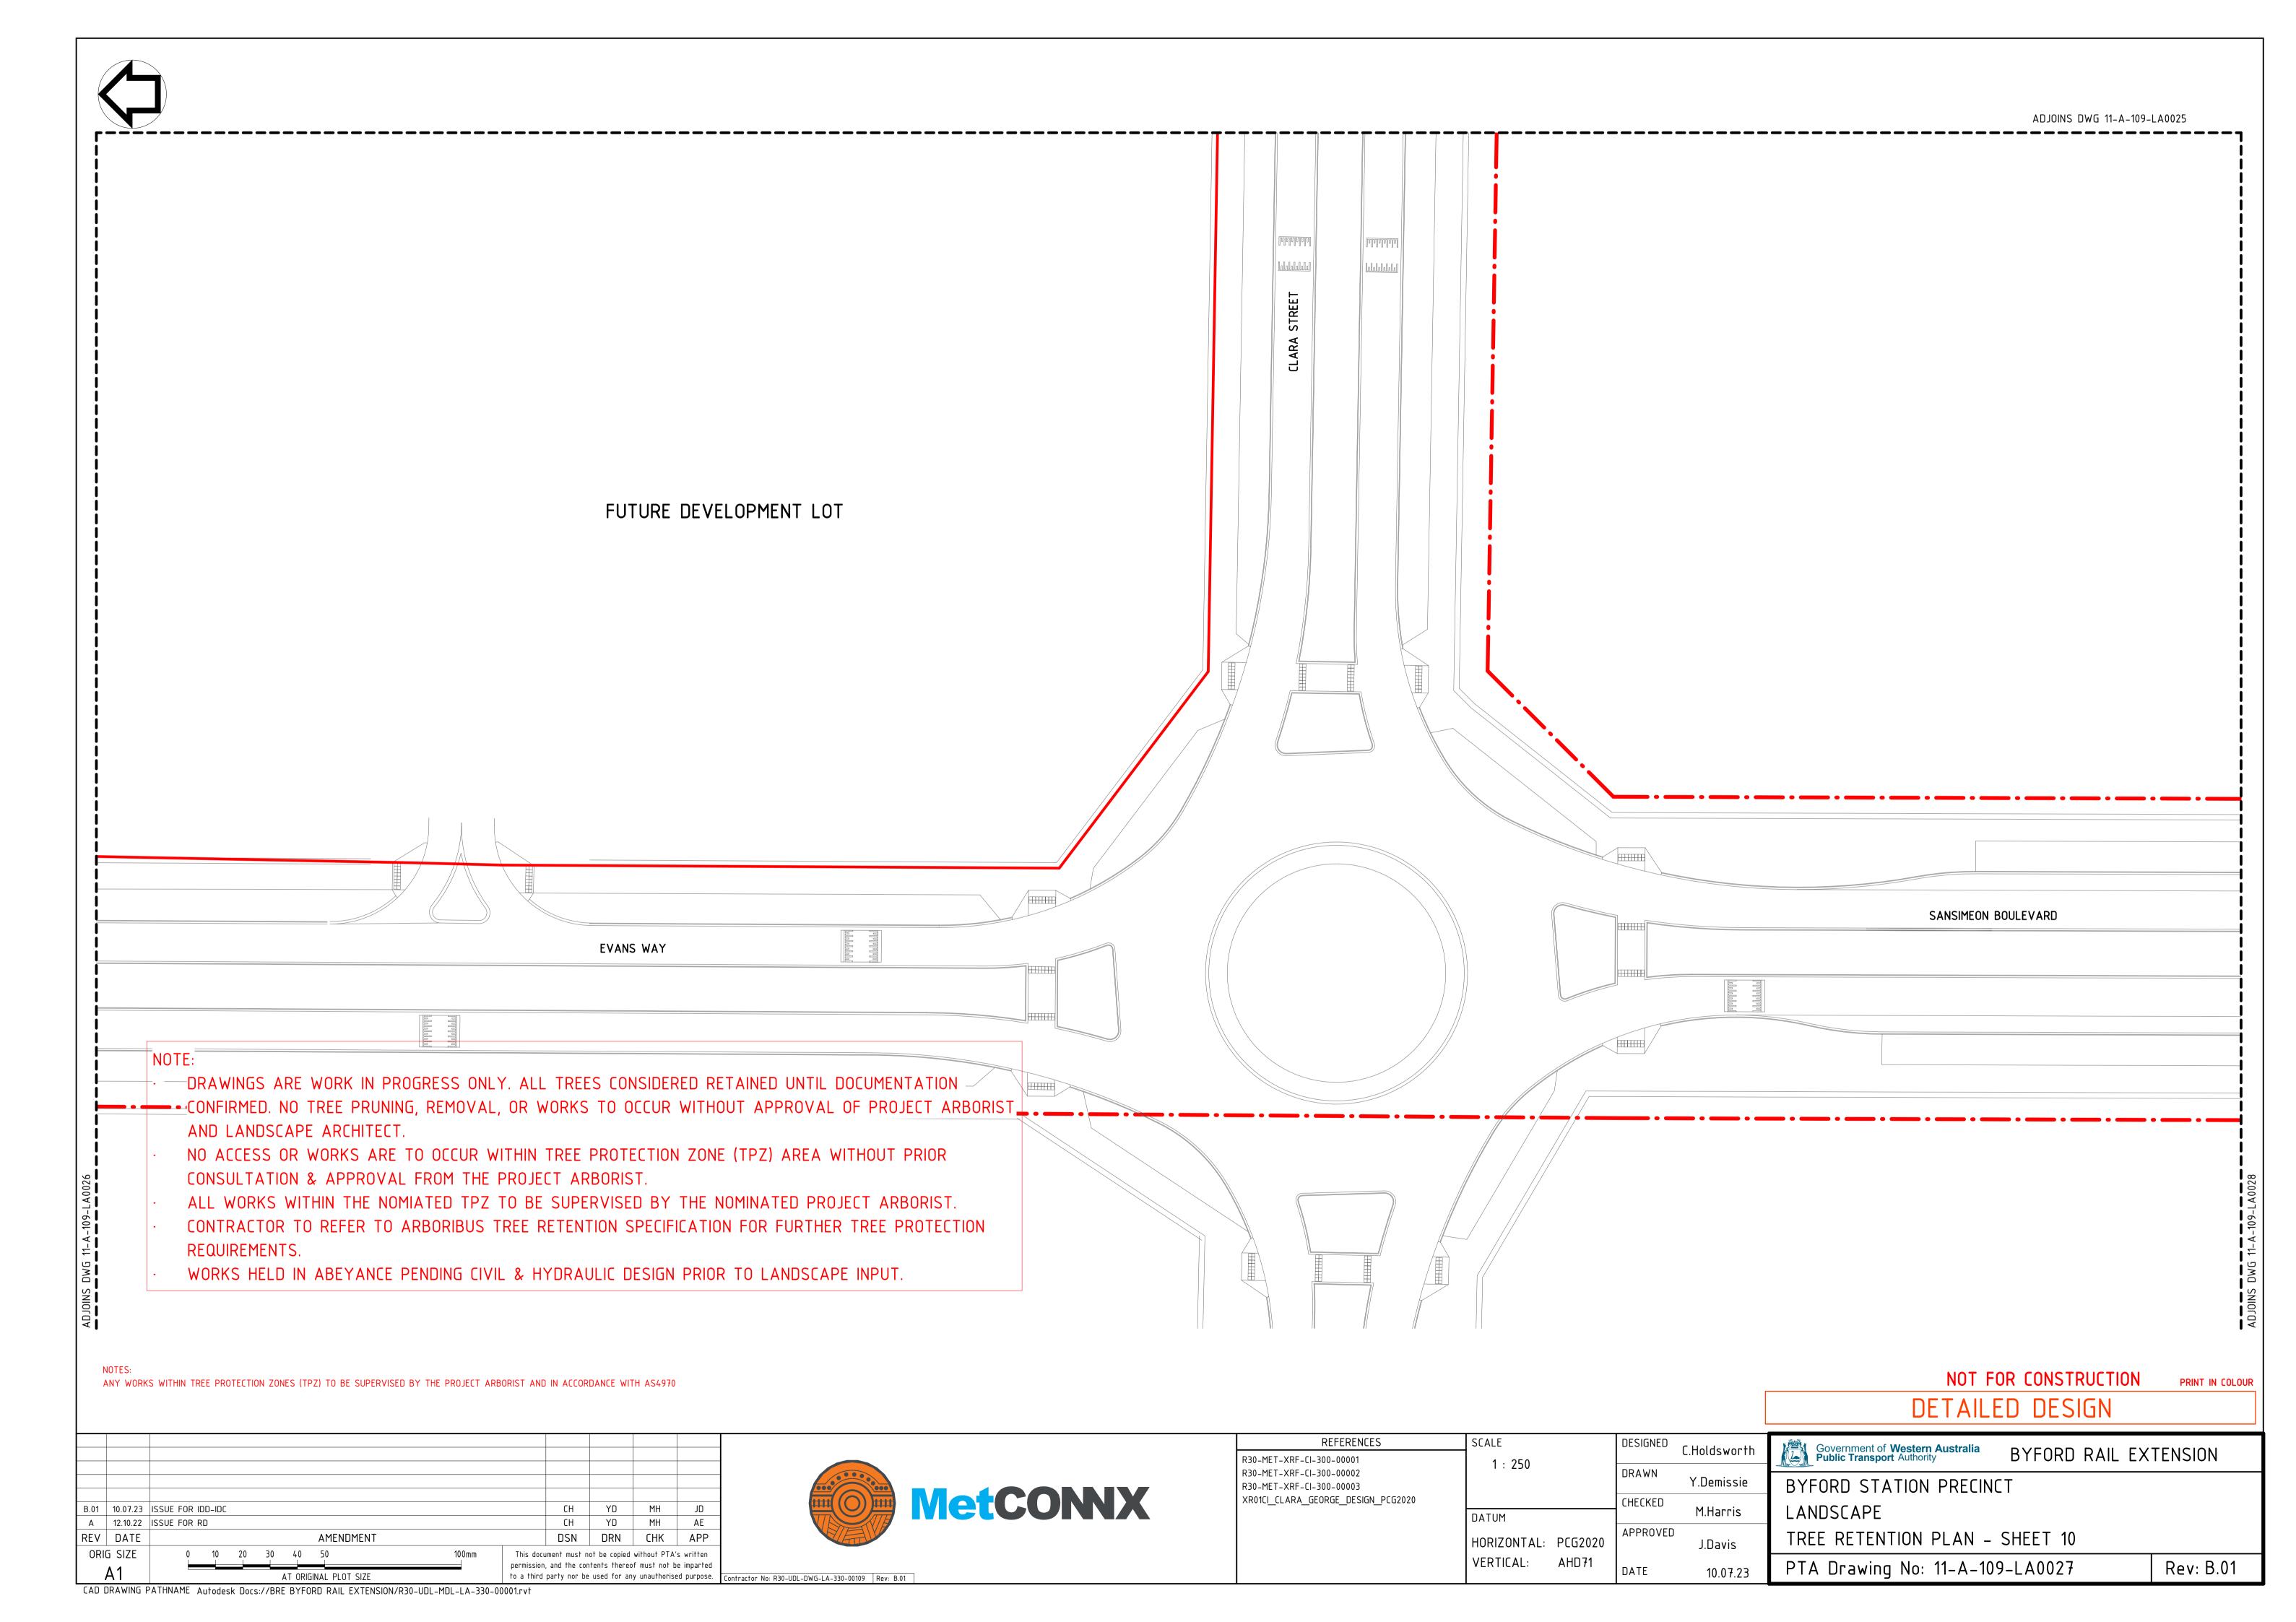



NOTE:

- DRAWINGS ARE WORK IN PROGRESS ONLY. ALL TREES CONSIDERED RETAINED UNTIL DOCUMENTATION CONFIRMED. NO TREE PRUNING, REMOVAL, OR WORKS TO OCCUR WITHOUT APPROVAL OF PROJECT ARBORIST AND LANDSCAPE ARCHITECT.
- NO ACCESS OR WORKS ARE TO OCCUR WITHIN TREE PROTECTION ZONE (TPZ) AREA WITHOUT PRIOR CONSULTATION & APPROVAL FROM THE PROJECT ARBORIST.
- ALL WORKS WITHIN THE NOMIATED TPZ TO BE SUPERVISED BY THE NOMINATED PROJECT ARBORIST.
- CONTRACTOR TO REFER TO ARBORIBUS TREE RETENTION SPECIFICATION FOR FURTHER TREE PROTECTION REQUIREMENTS.
- WORKS HELD IN ABEYANCE PENDING CIVIL & HYDRAULIC DESIGN PRIOR TO LANDSCAPE INPUT.

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NOTES:

ANY WORKS WITHIN TREE PROTECTION ZONES (TPZ) TO BE SUPERVISED BY THE PROJECT ARBORIST AND IN ACCORDANCE WITH AS4970

B.01 10.07.23 ISSUE FOR IDD-IDC

A 12.10.22 ISSUE FOR RD

CH YD MH JD

CH YD MH AE

REV DATE

ORIG SIZE

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R30-MET-XRF-CI-300-00002 R30-MET-XRF-CI-300-00003			DRAWN	Y.Demissie	
XR01CI_CLARA_GEORGE_DESIGN_PCG2020			CHECKED	M.Harris	
	DATUM			П.Паппъ	
	HORIZONTAL:	PCG2020	APPROVED	J.Davis	
	VERTICAL:	AHD71	ΠΔΤF	10 07 22	

10.07.23


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Government of Western Australia BYFORD RAIL EXTENSION BYFORD RAIL EXTENSION						
	BYFORD STATION PRECINCT					
	LANDSCAPE					
	TREE RETENTION PLAN - SHEET 11					
	PTA Drawing No: 11-A-109-LA0028 Rev: B.01					


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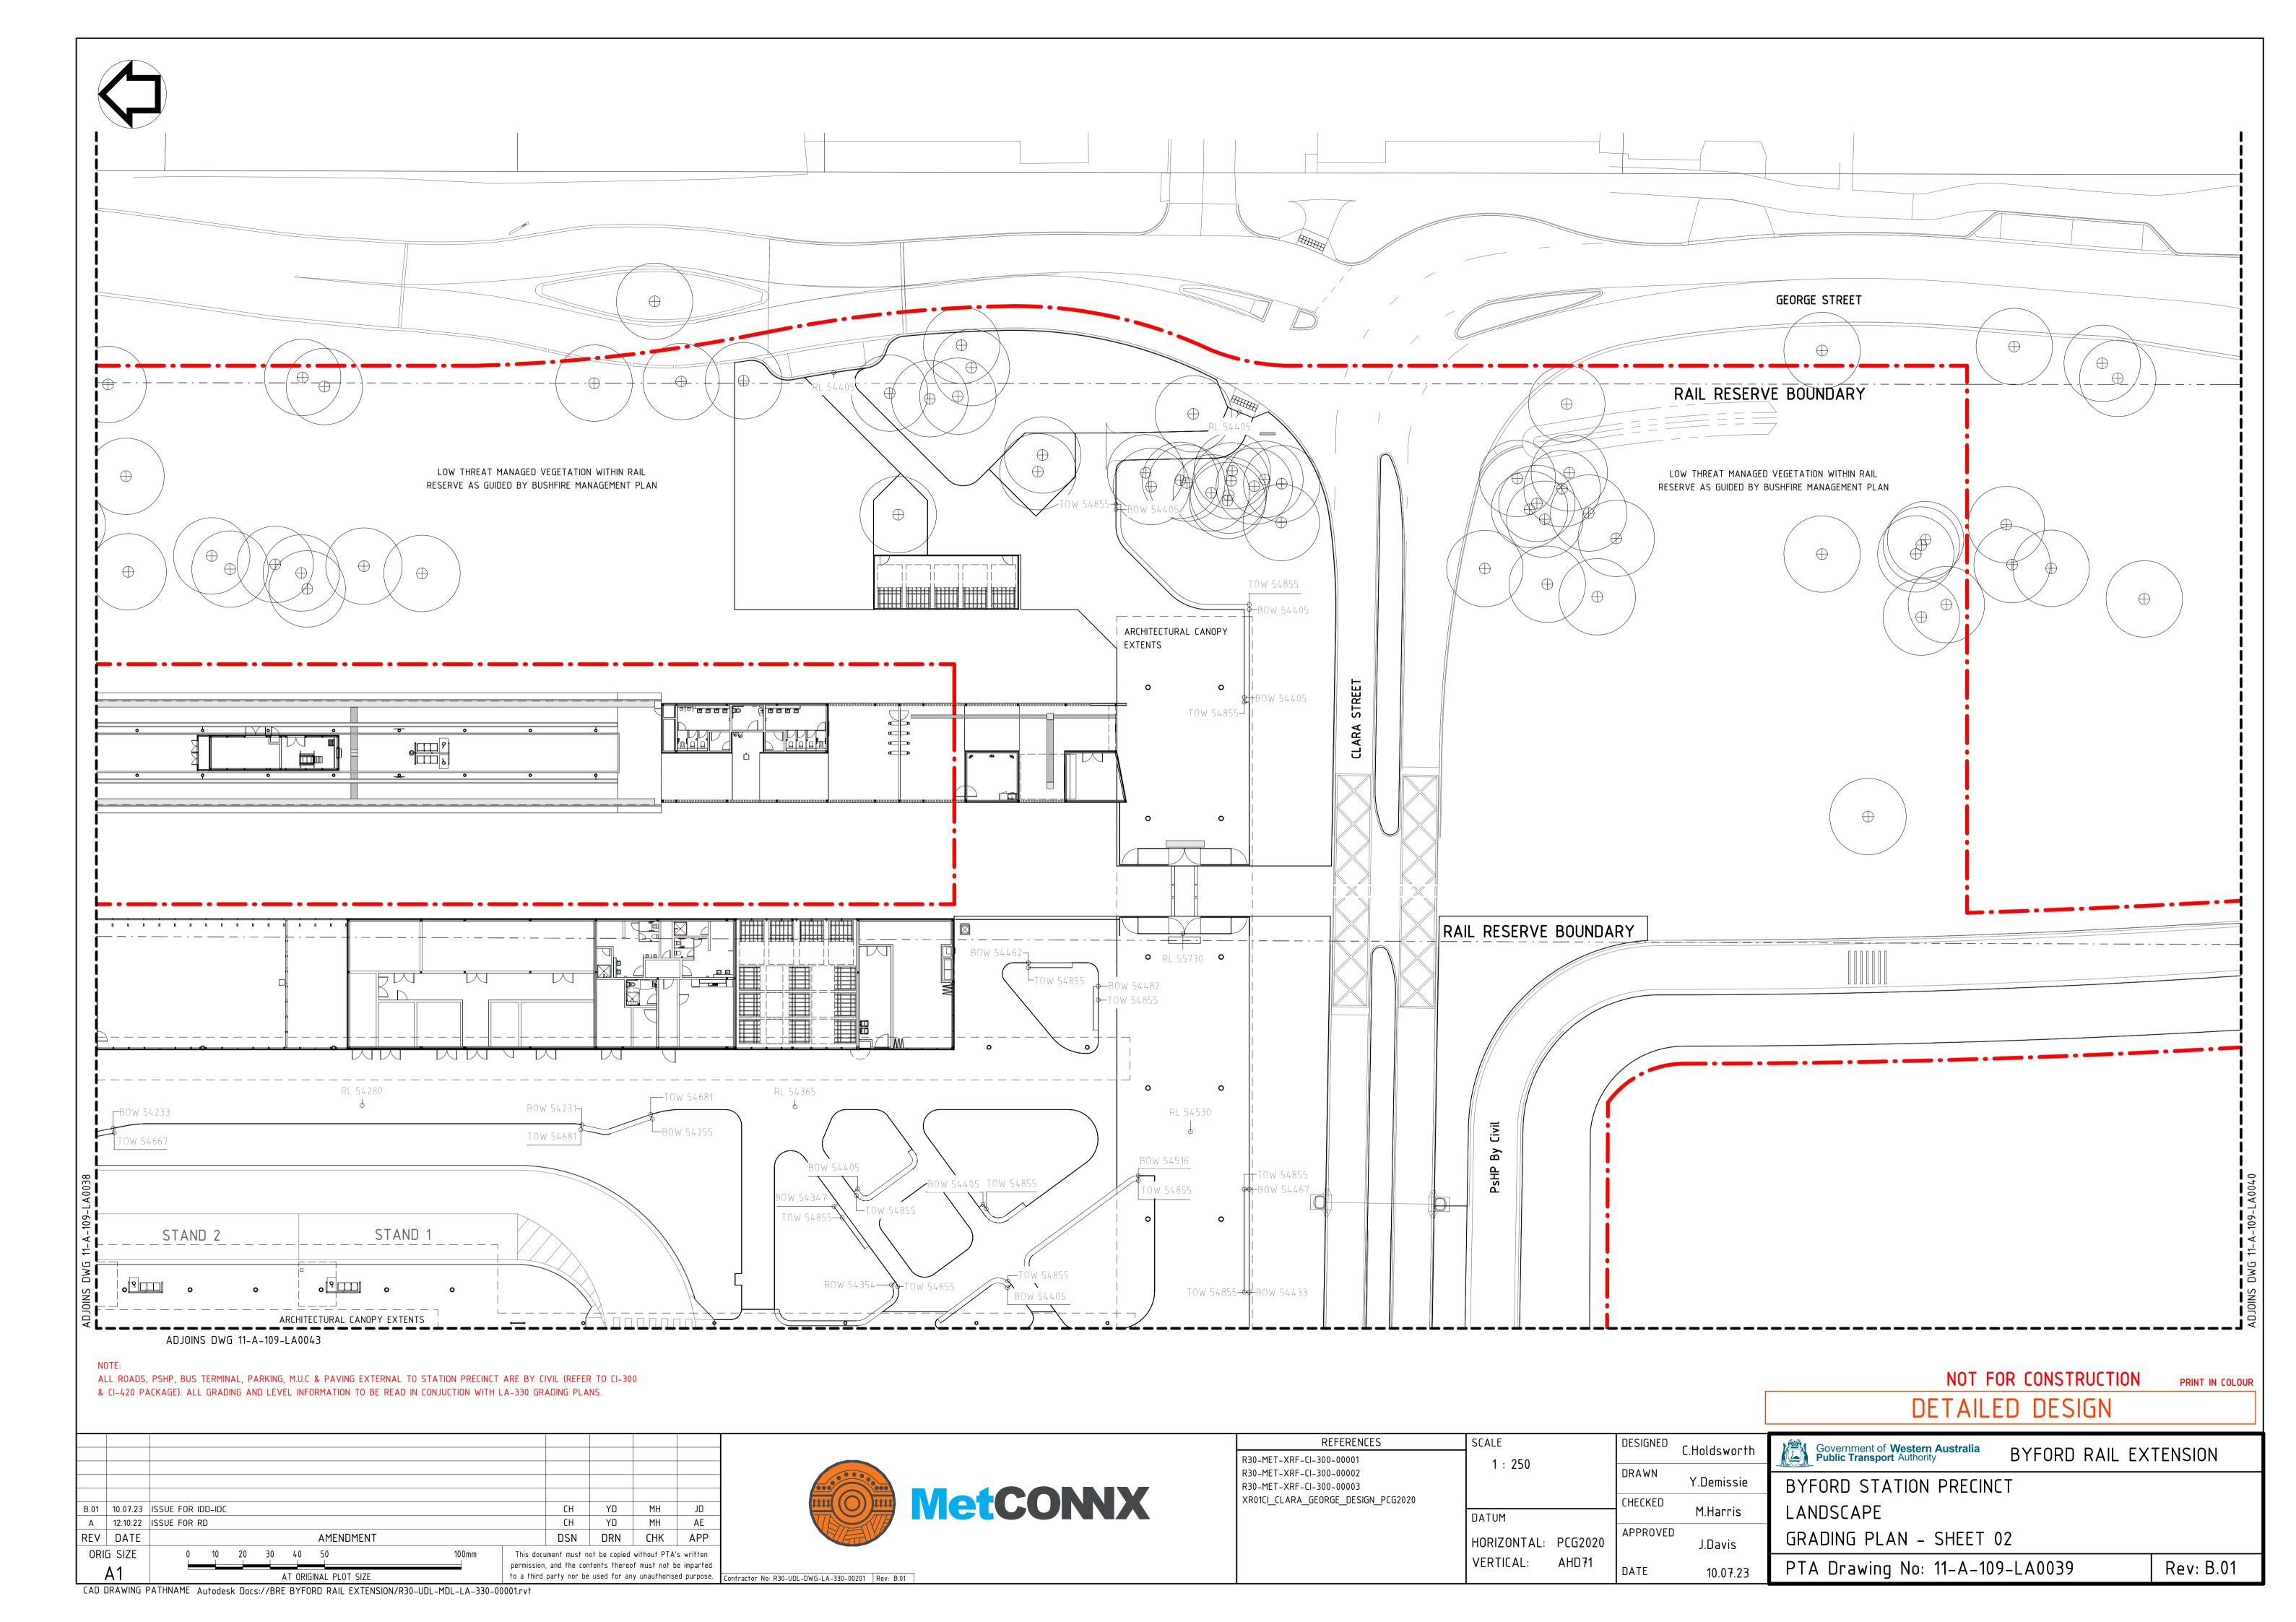
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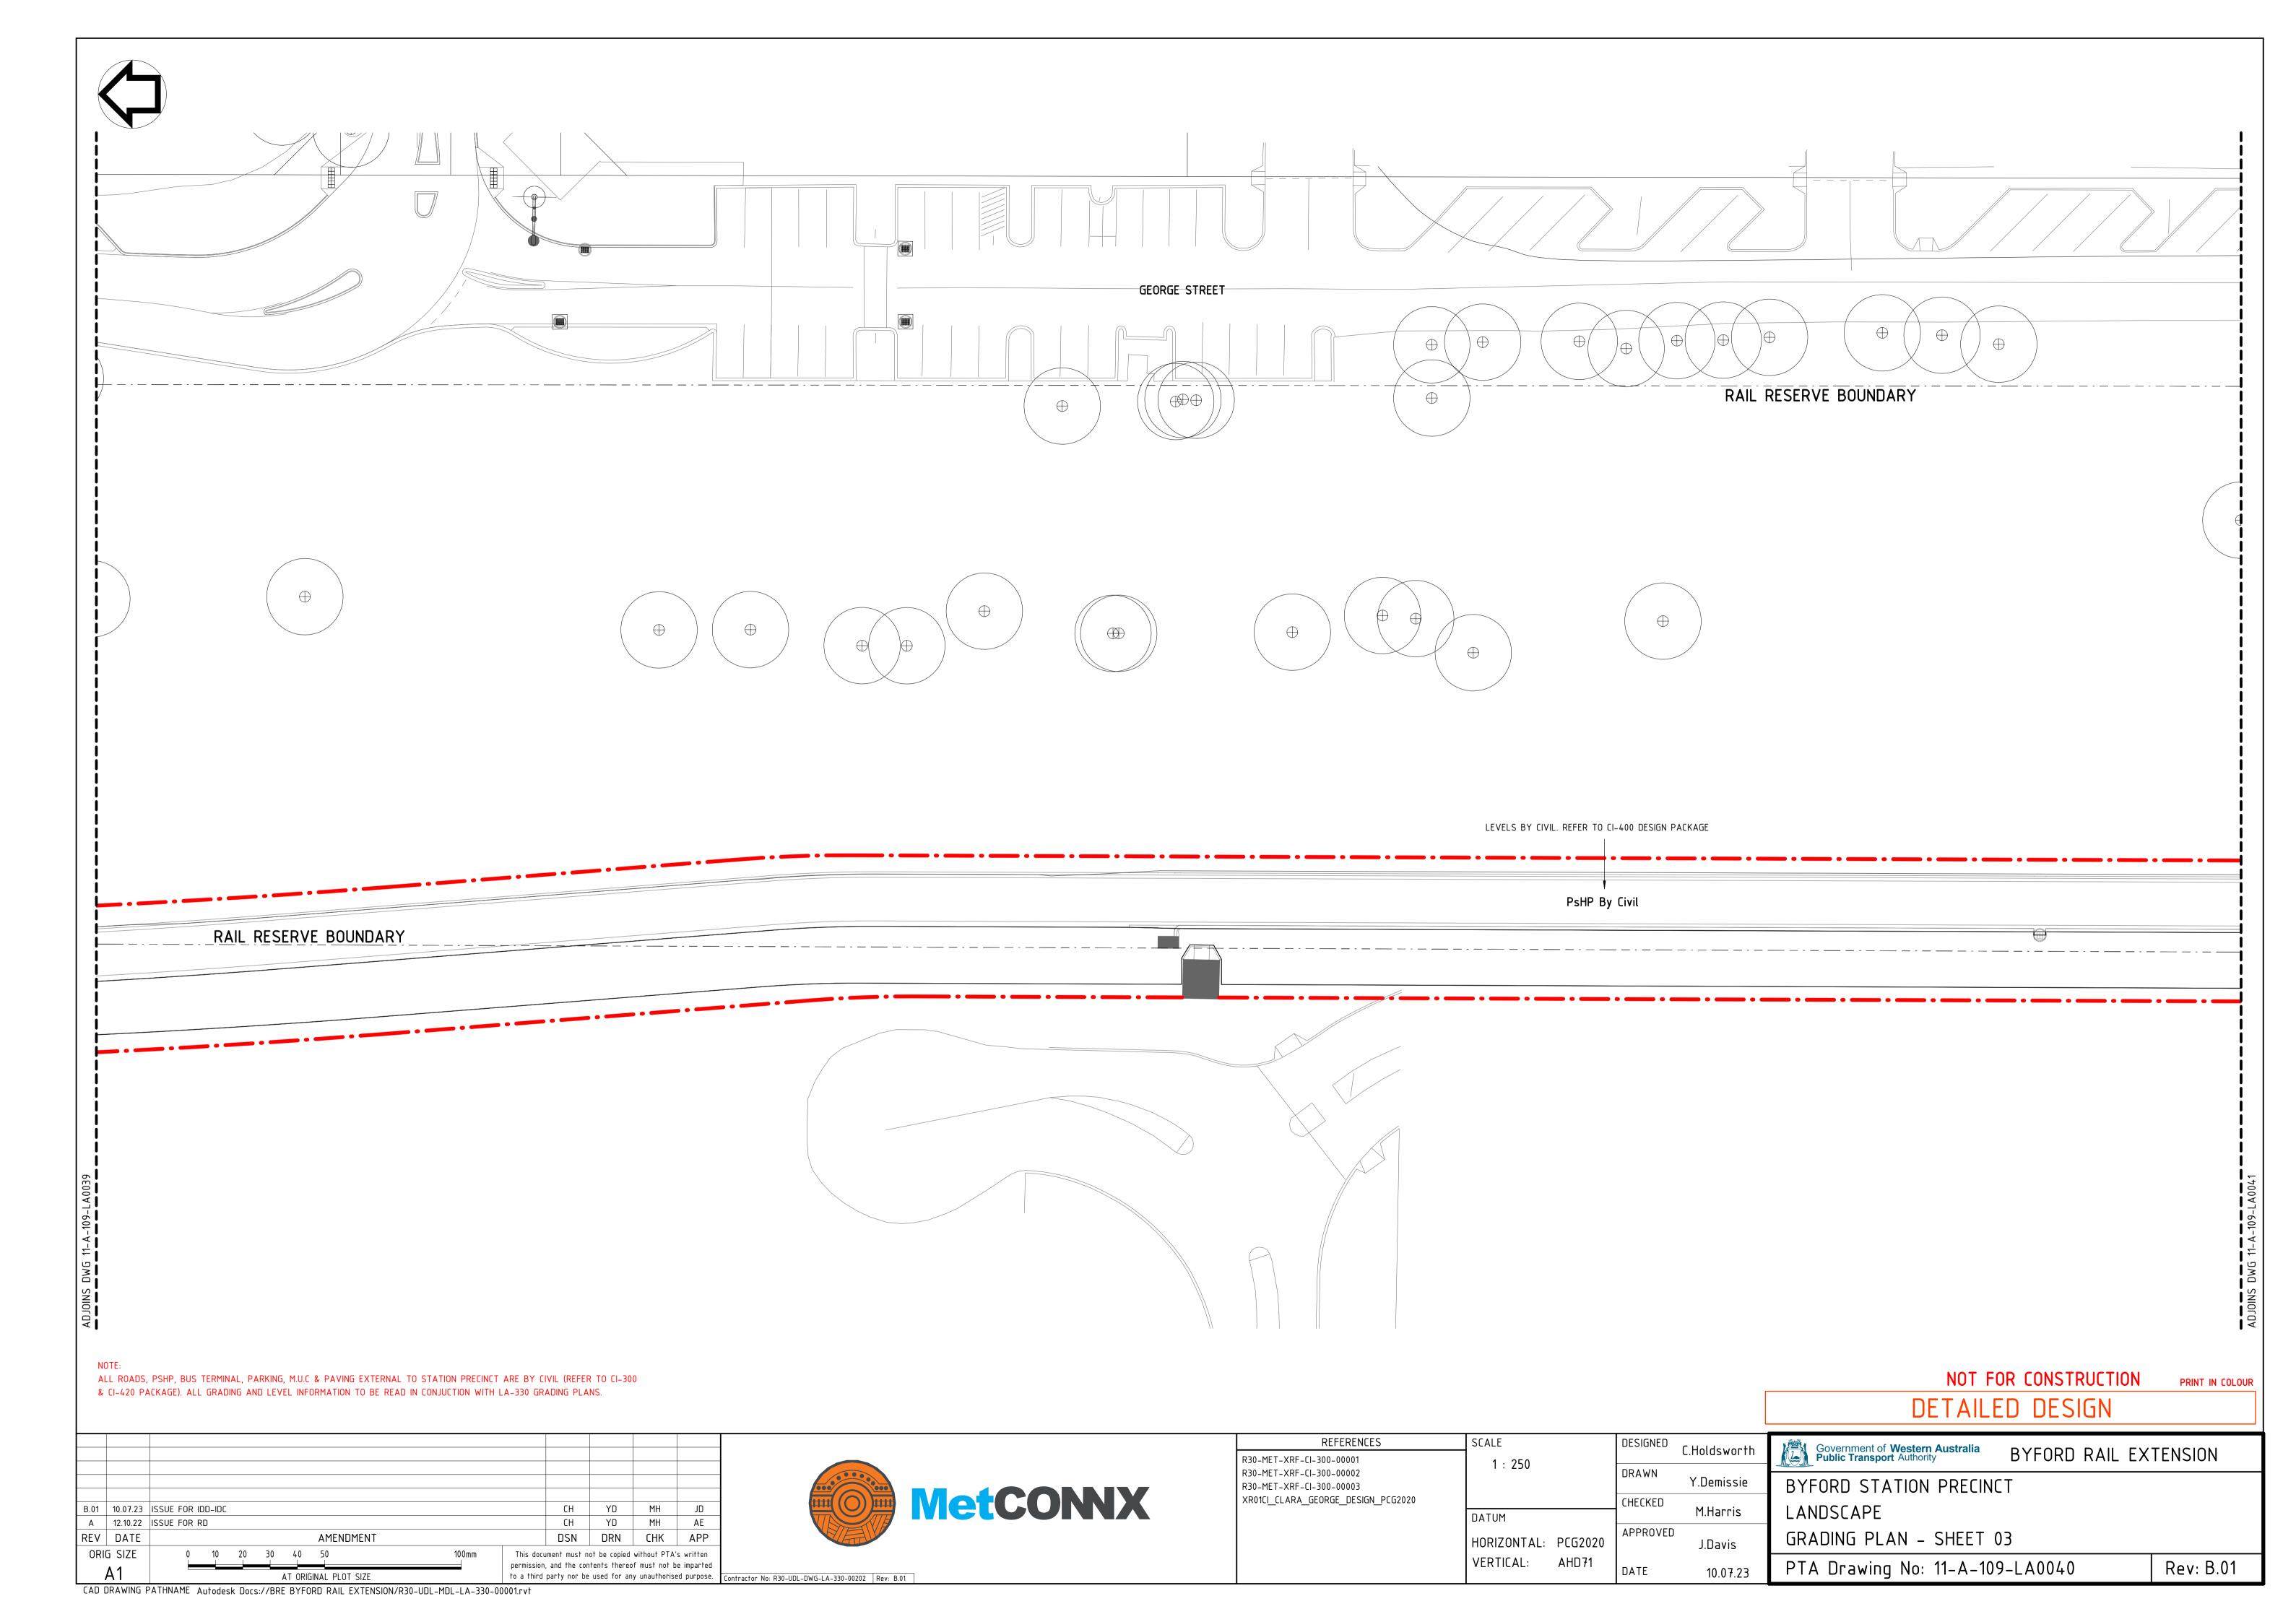
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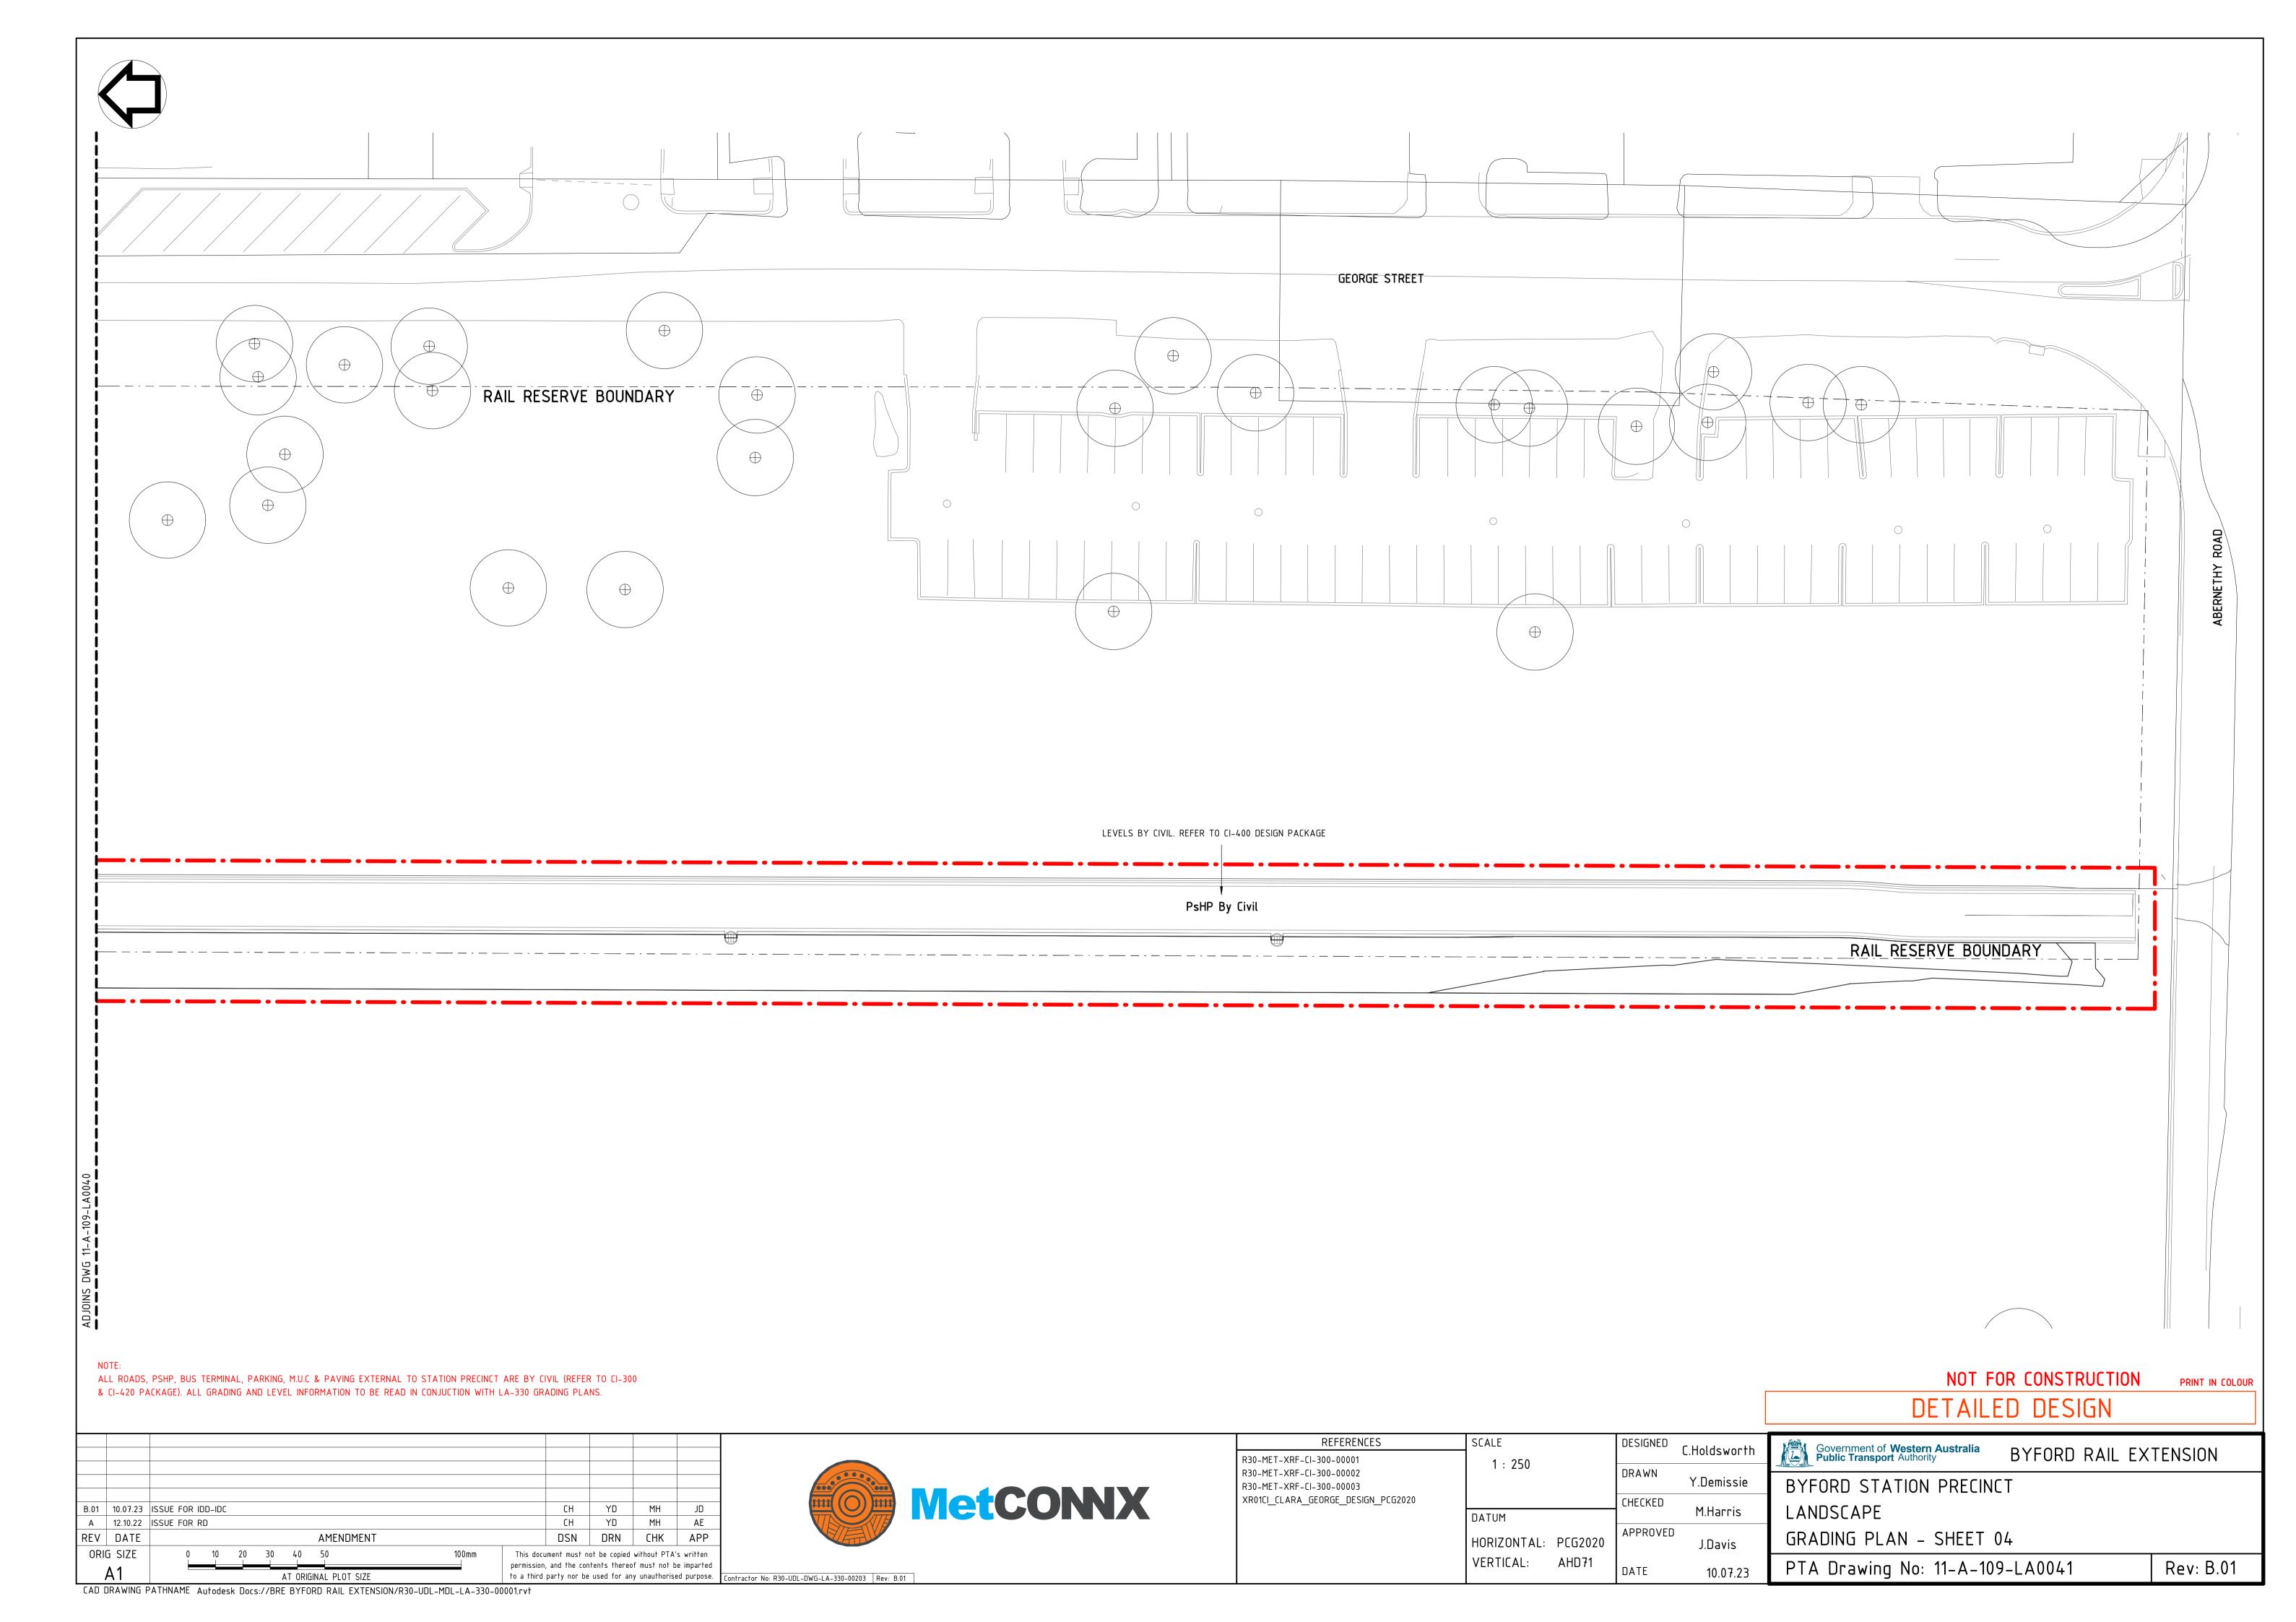
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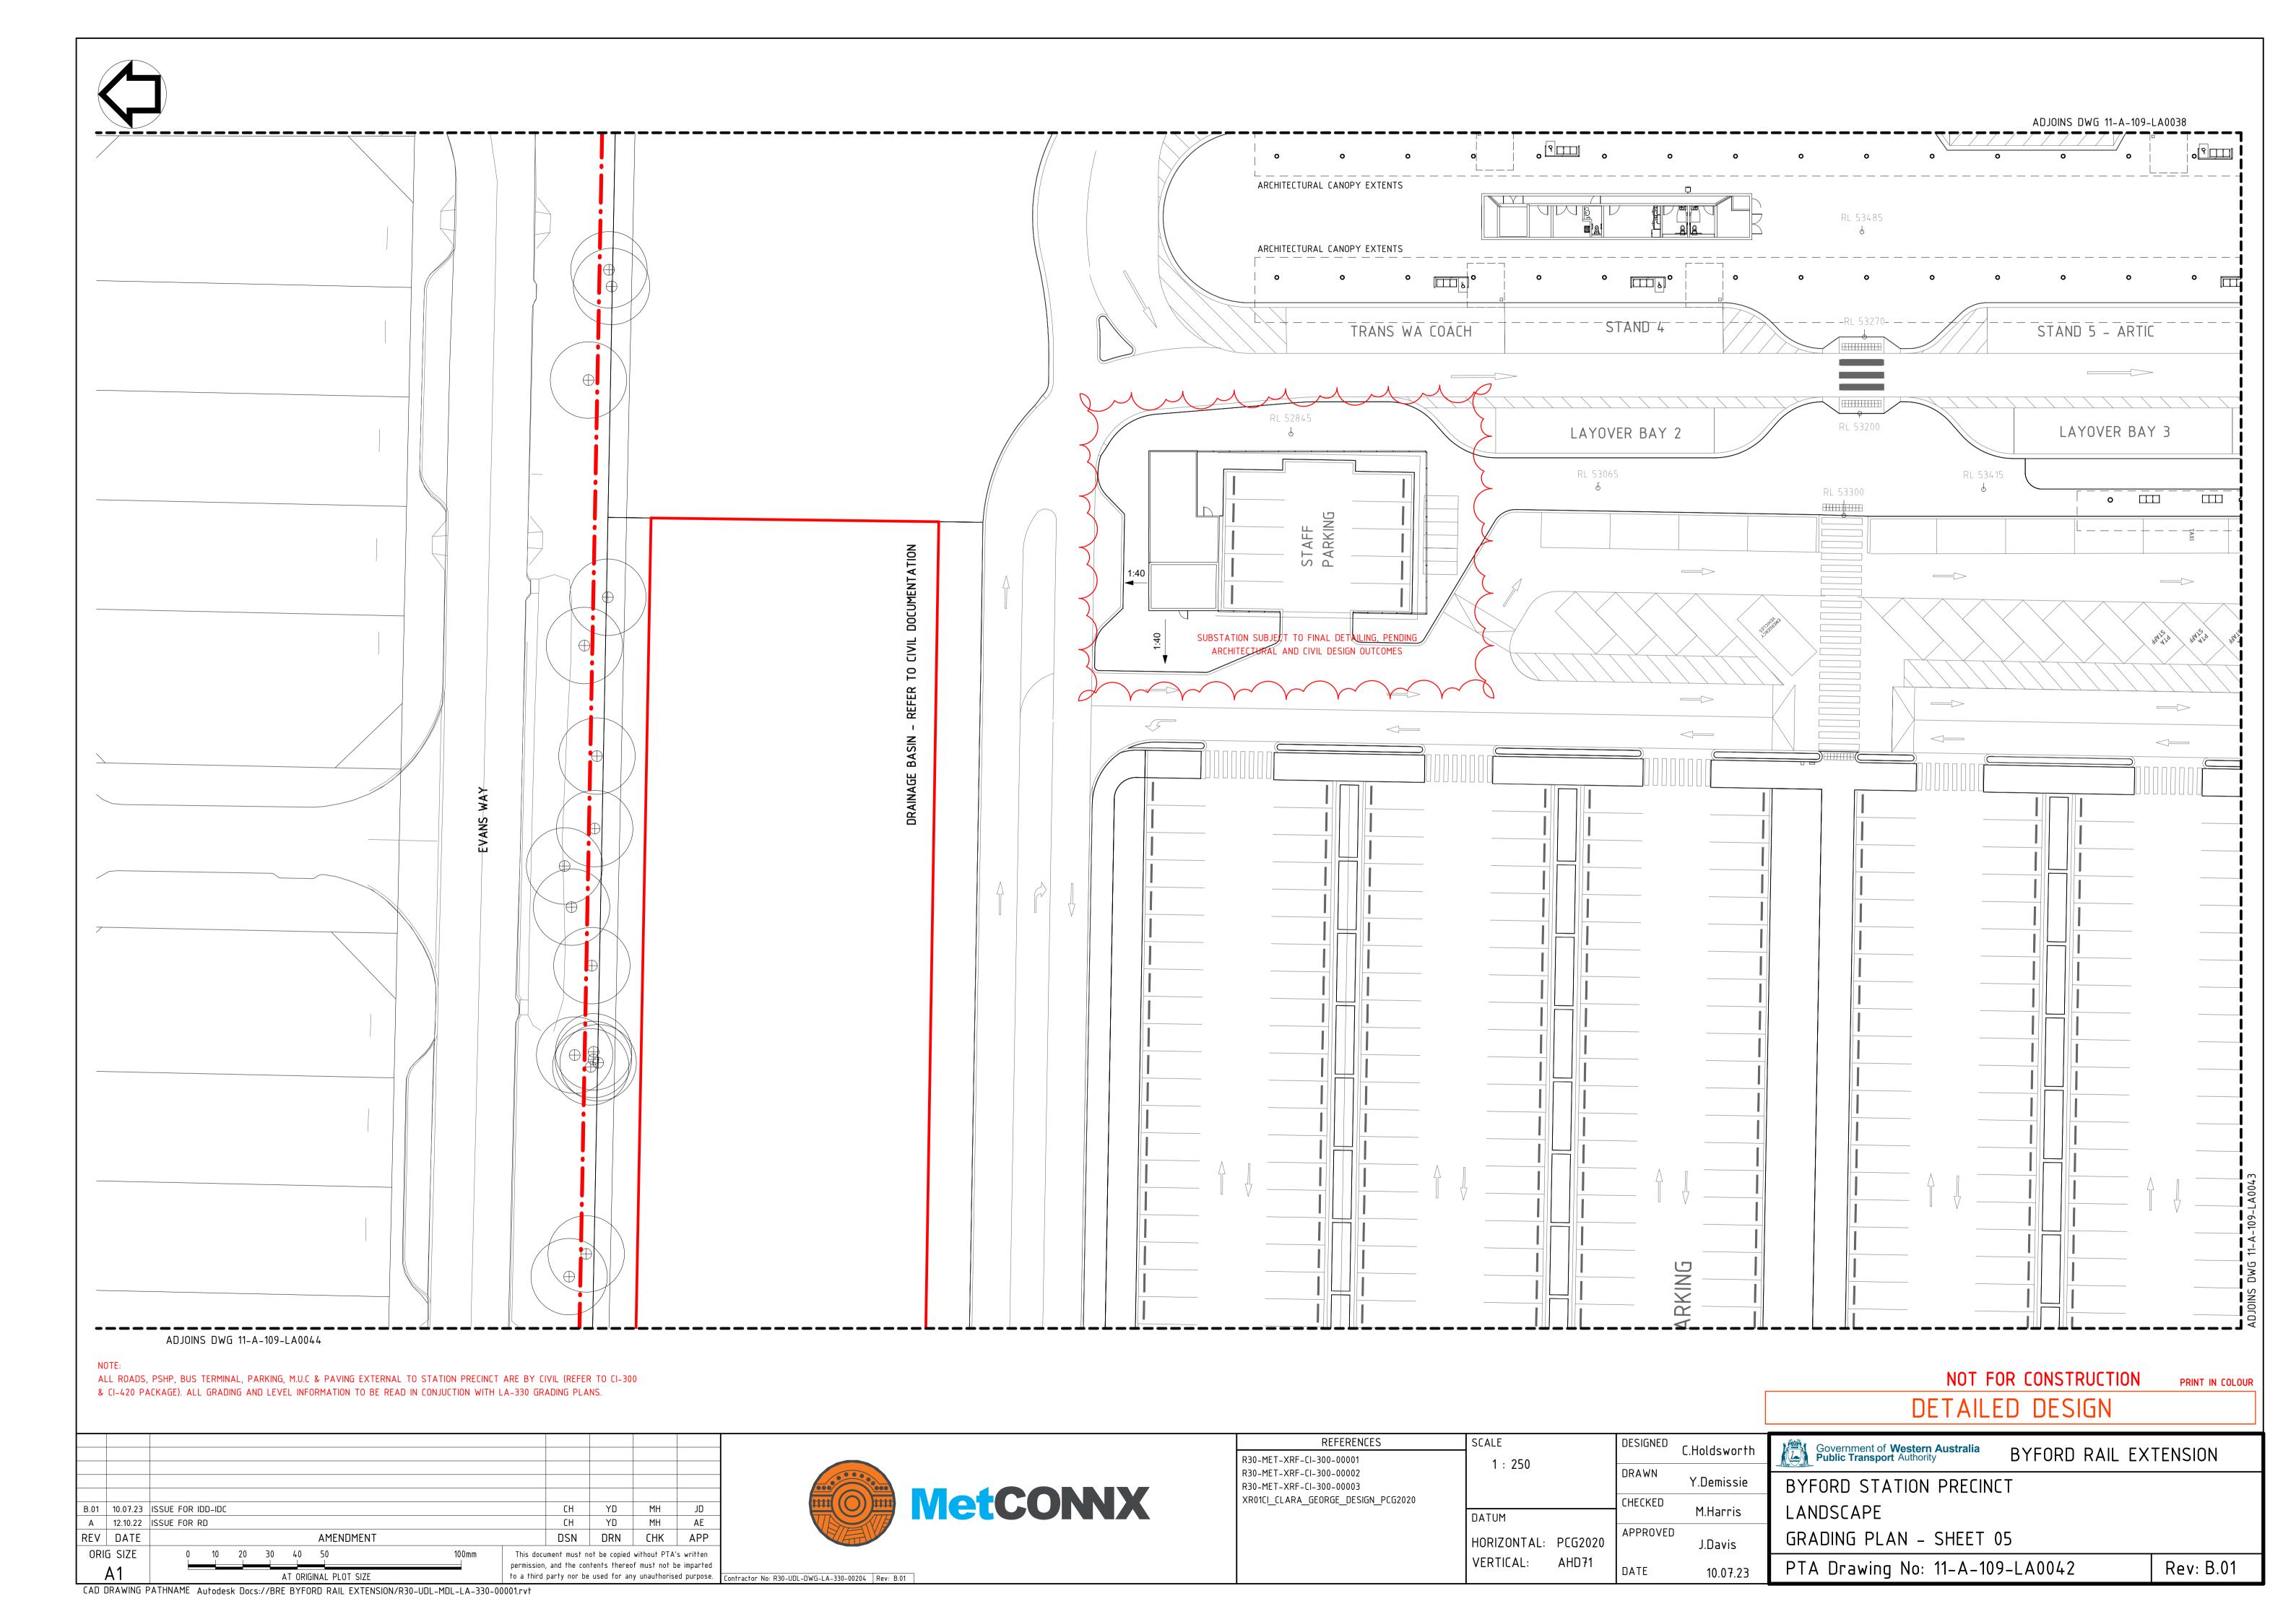











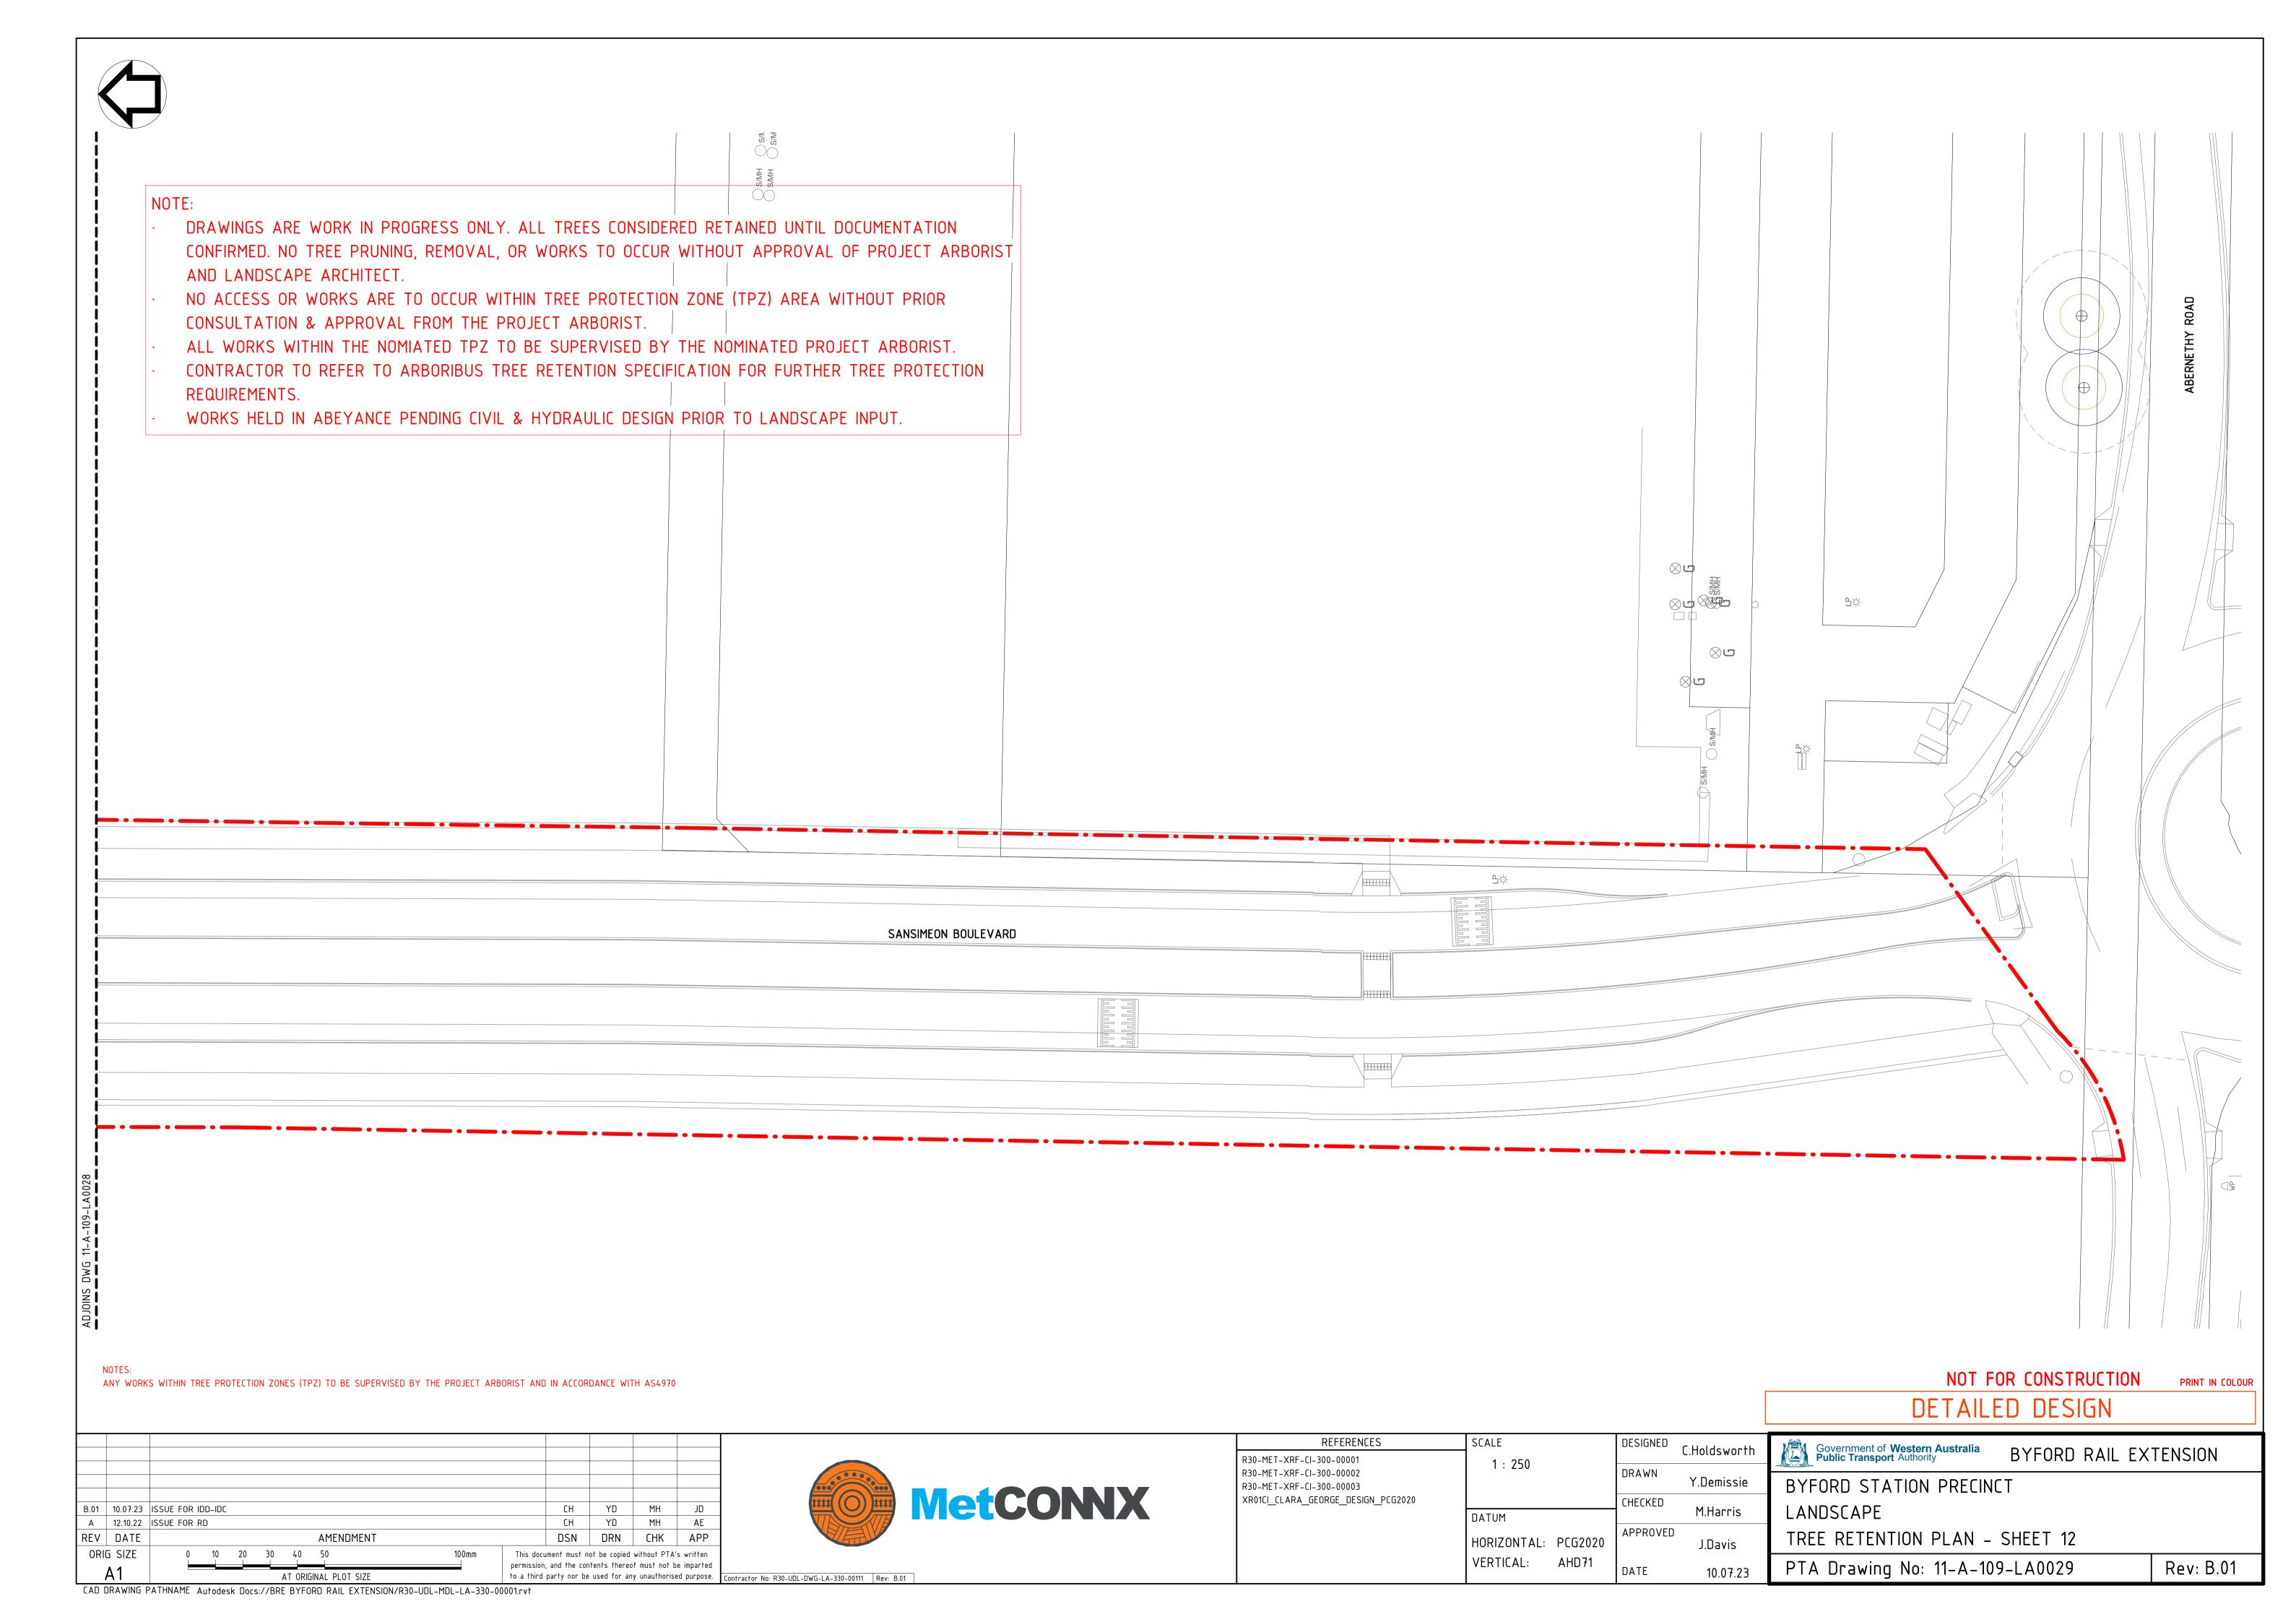


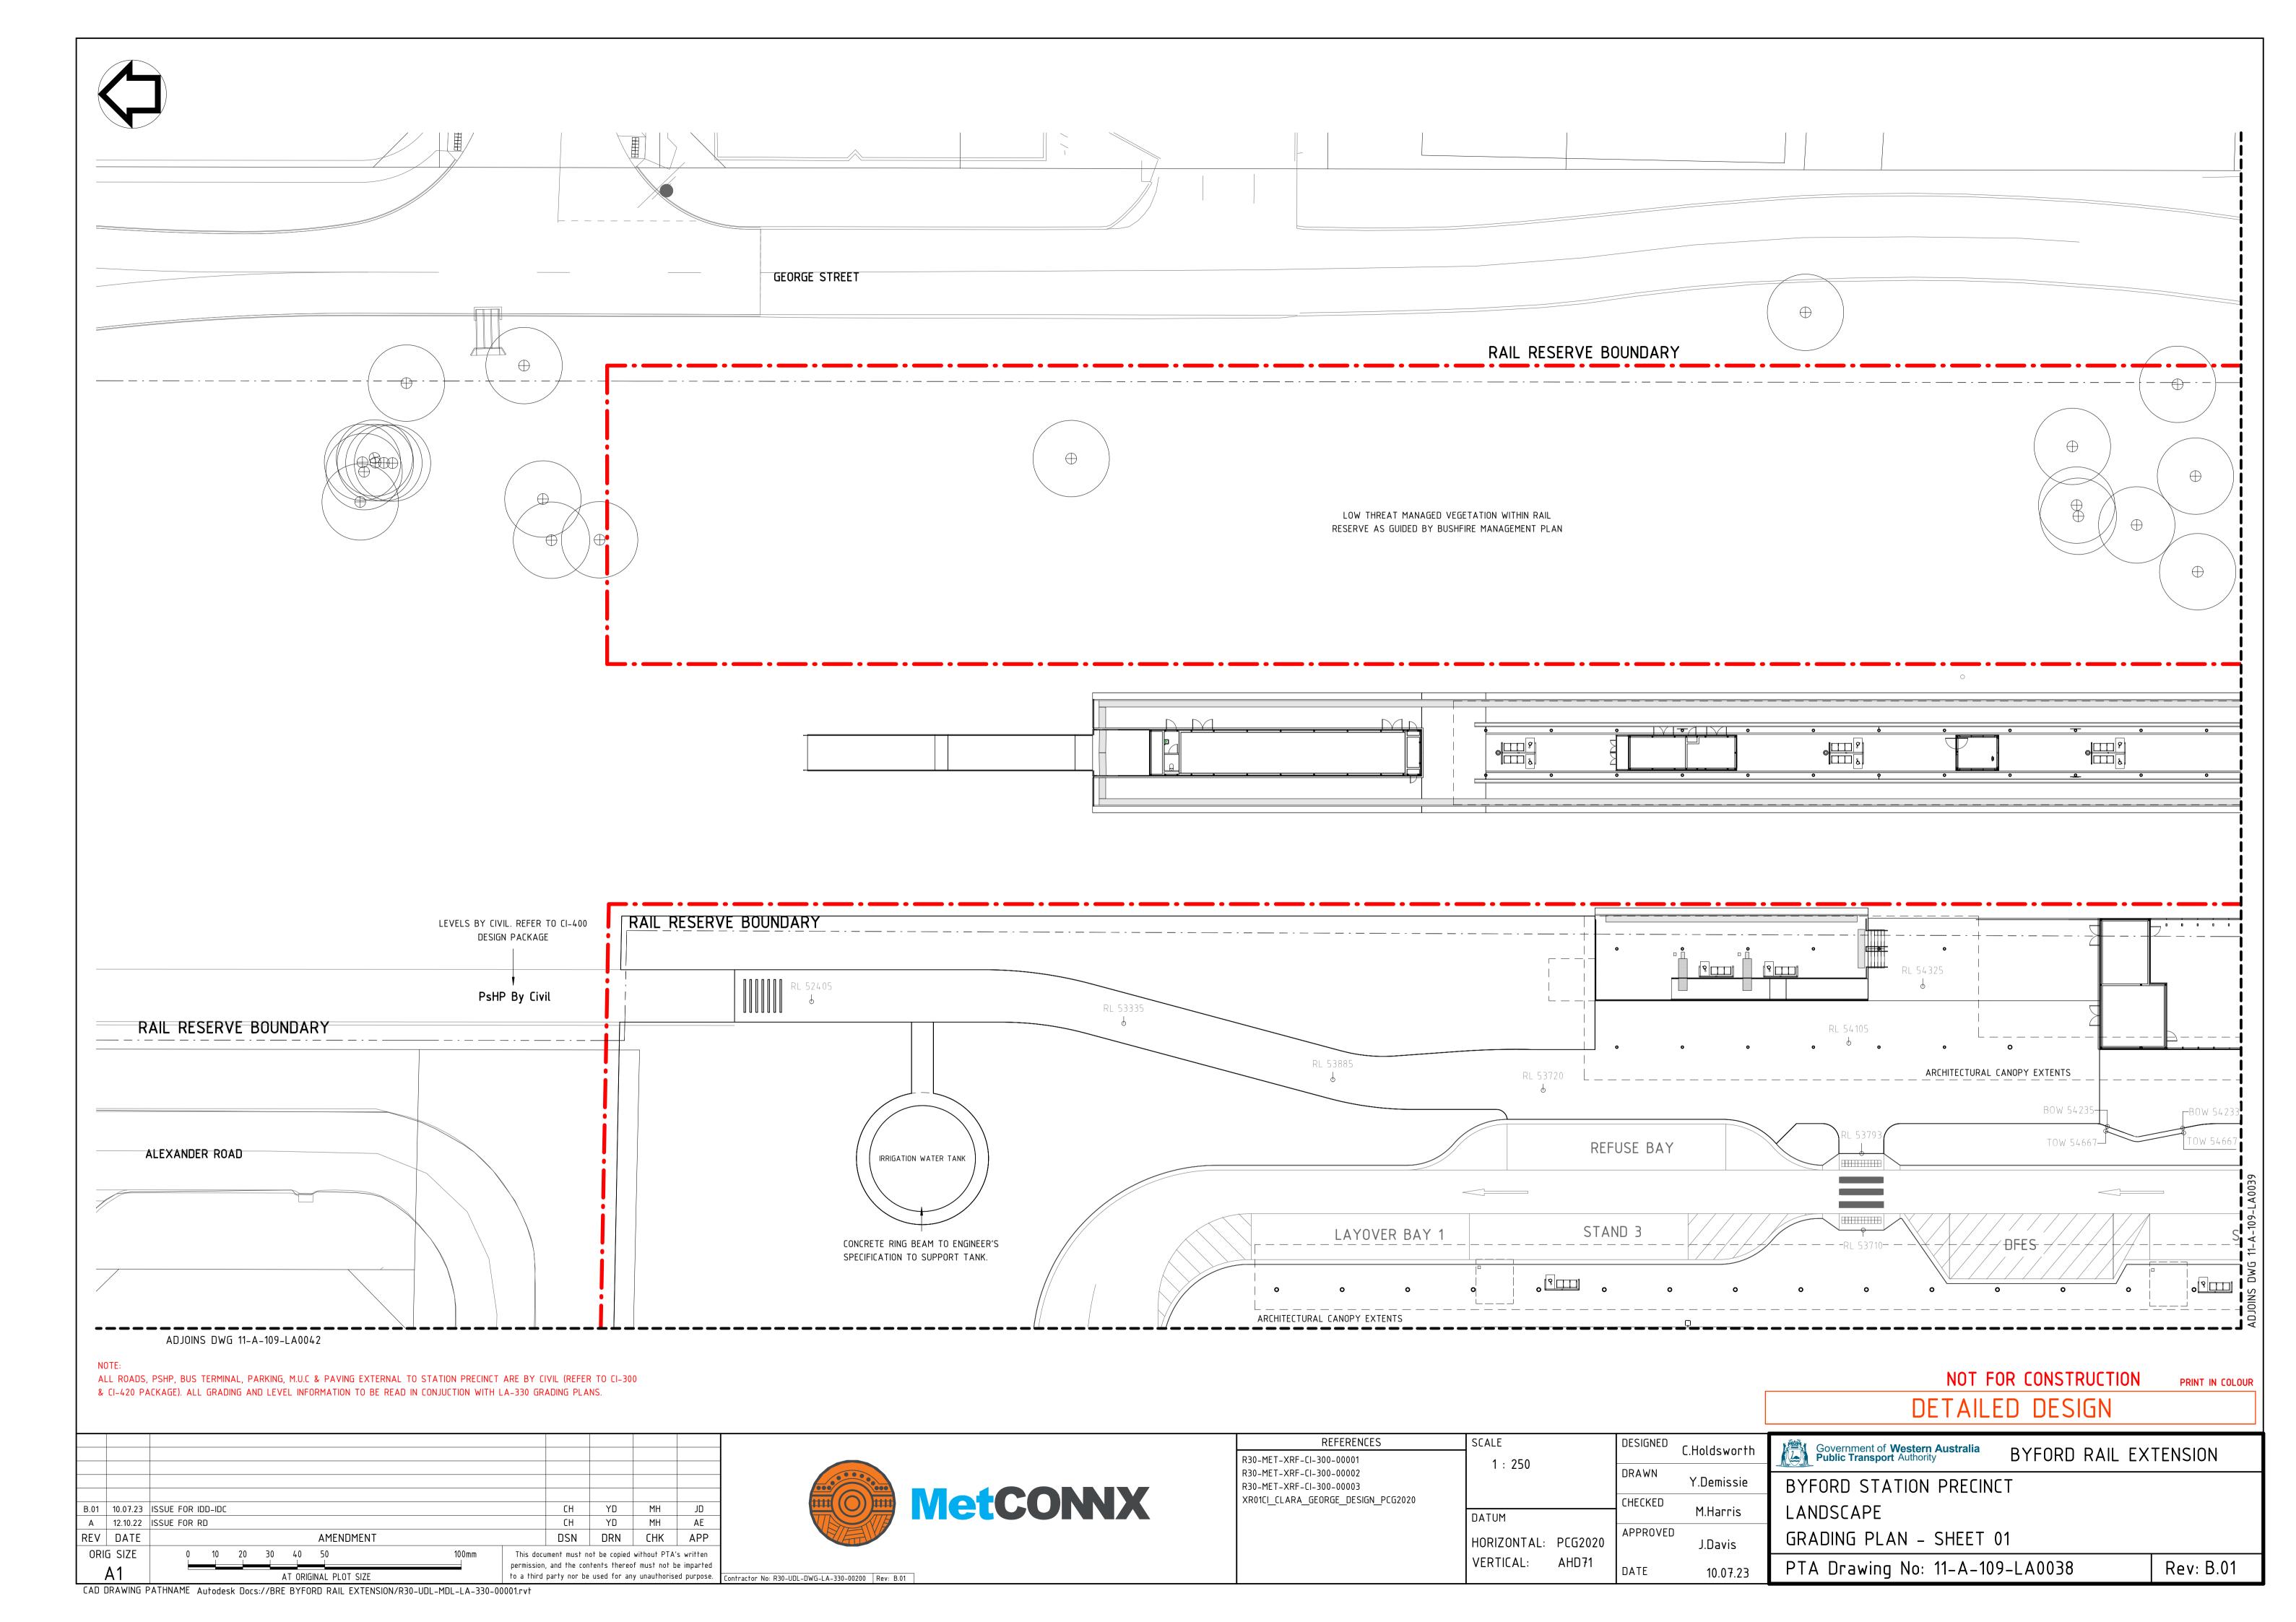


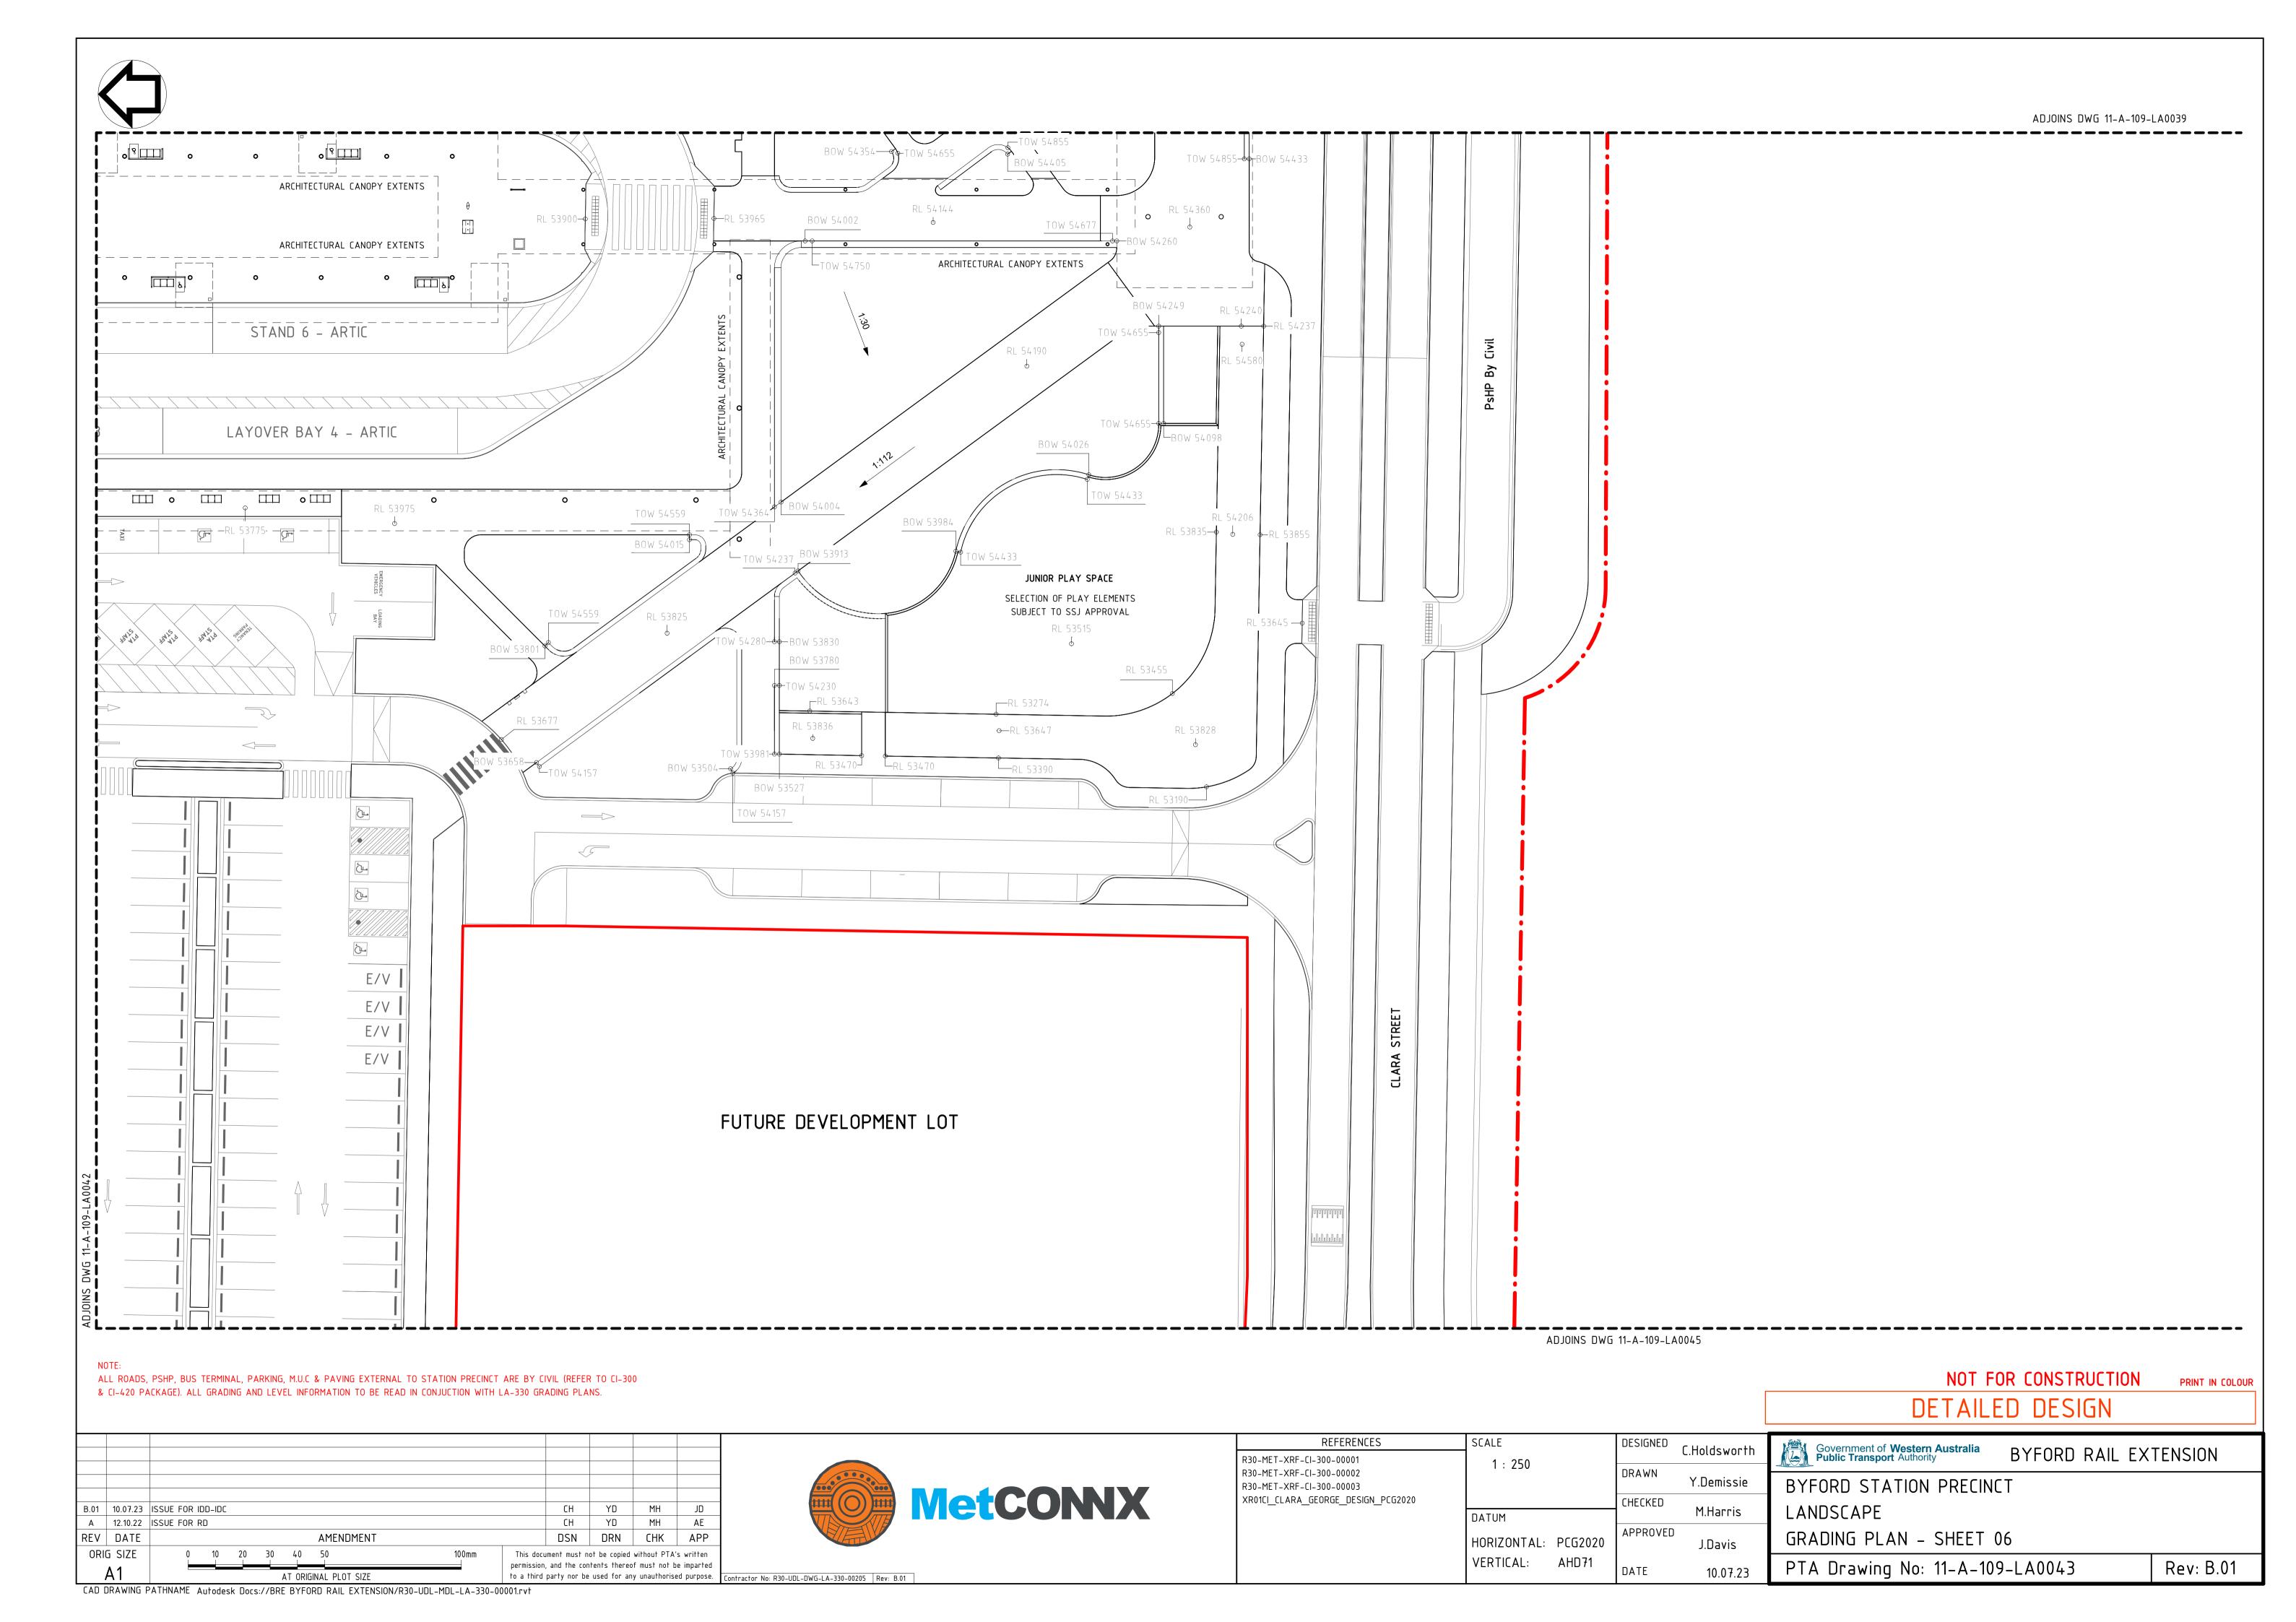

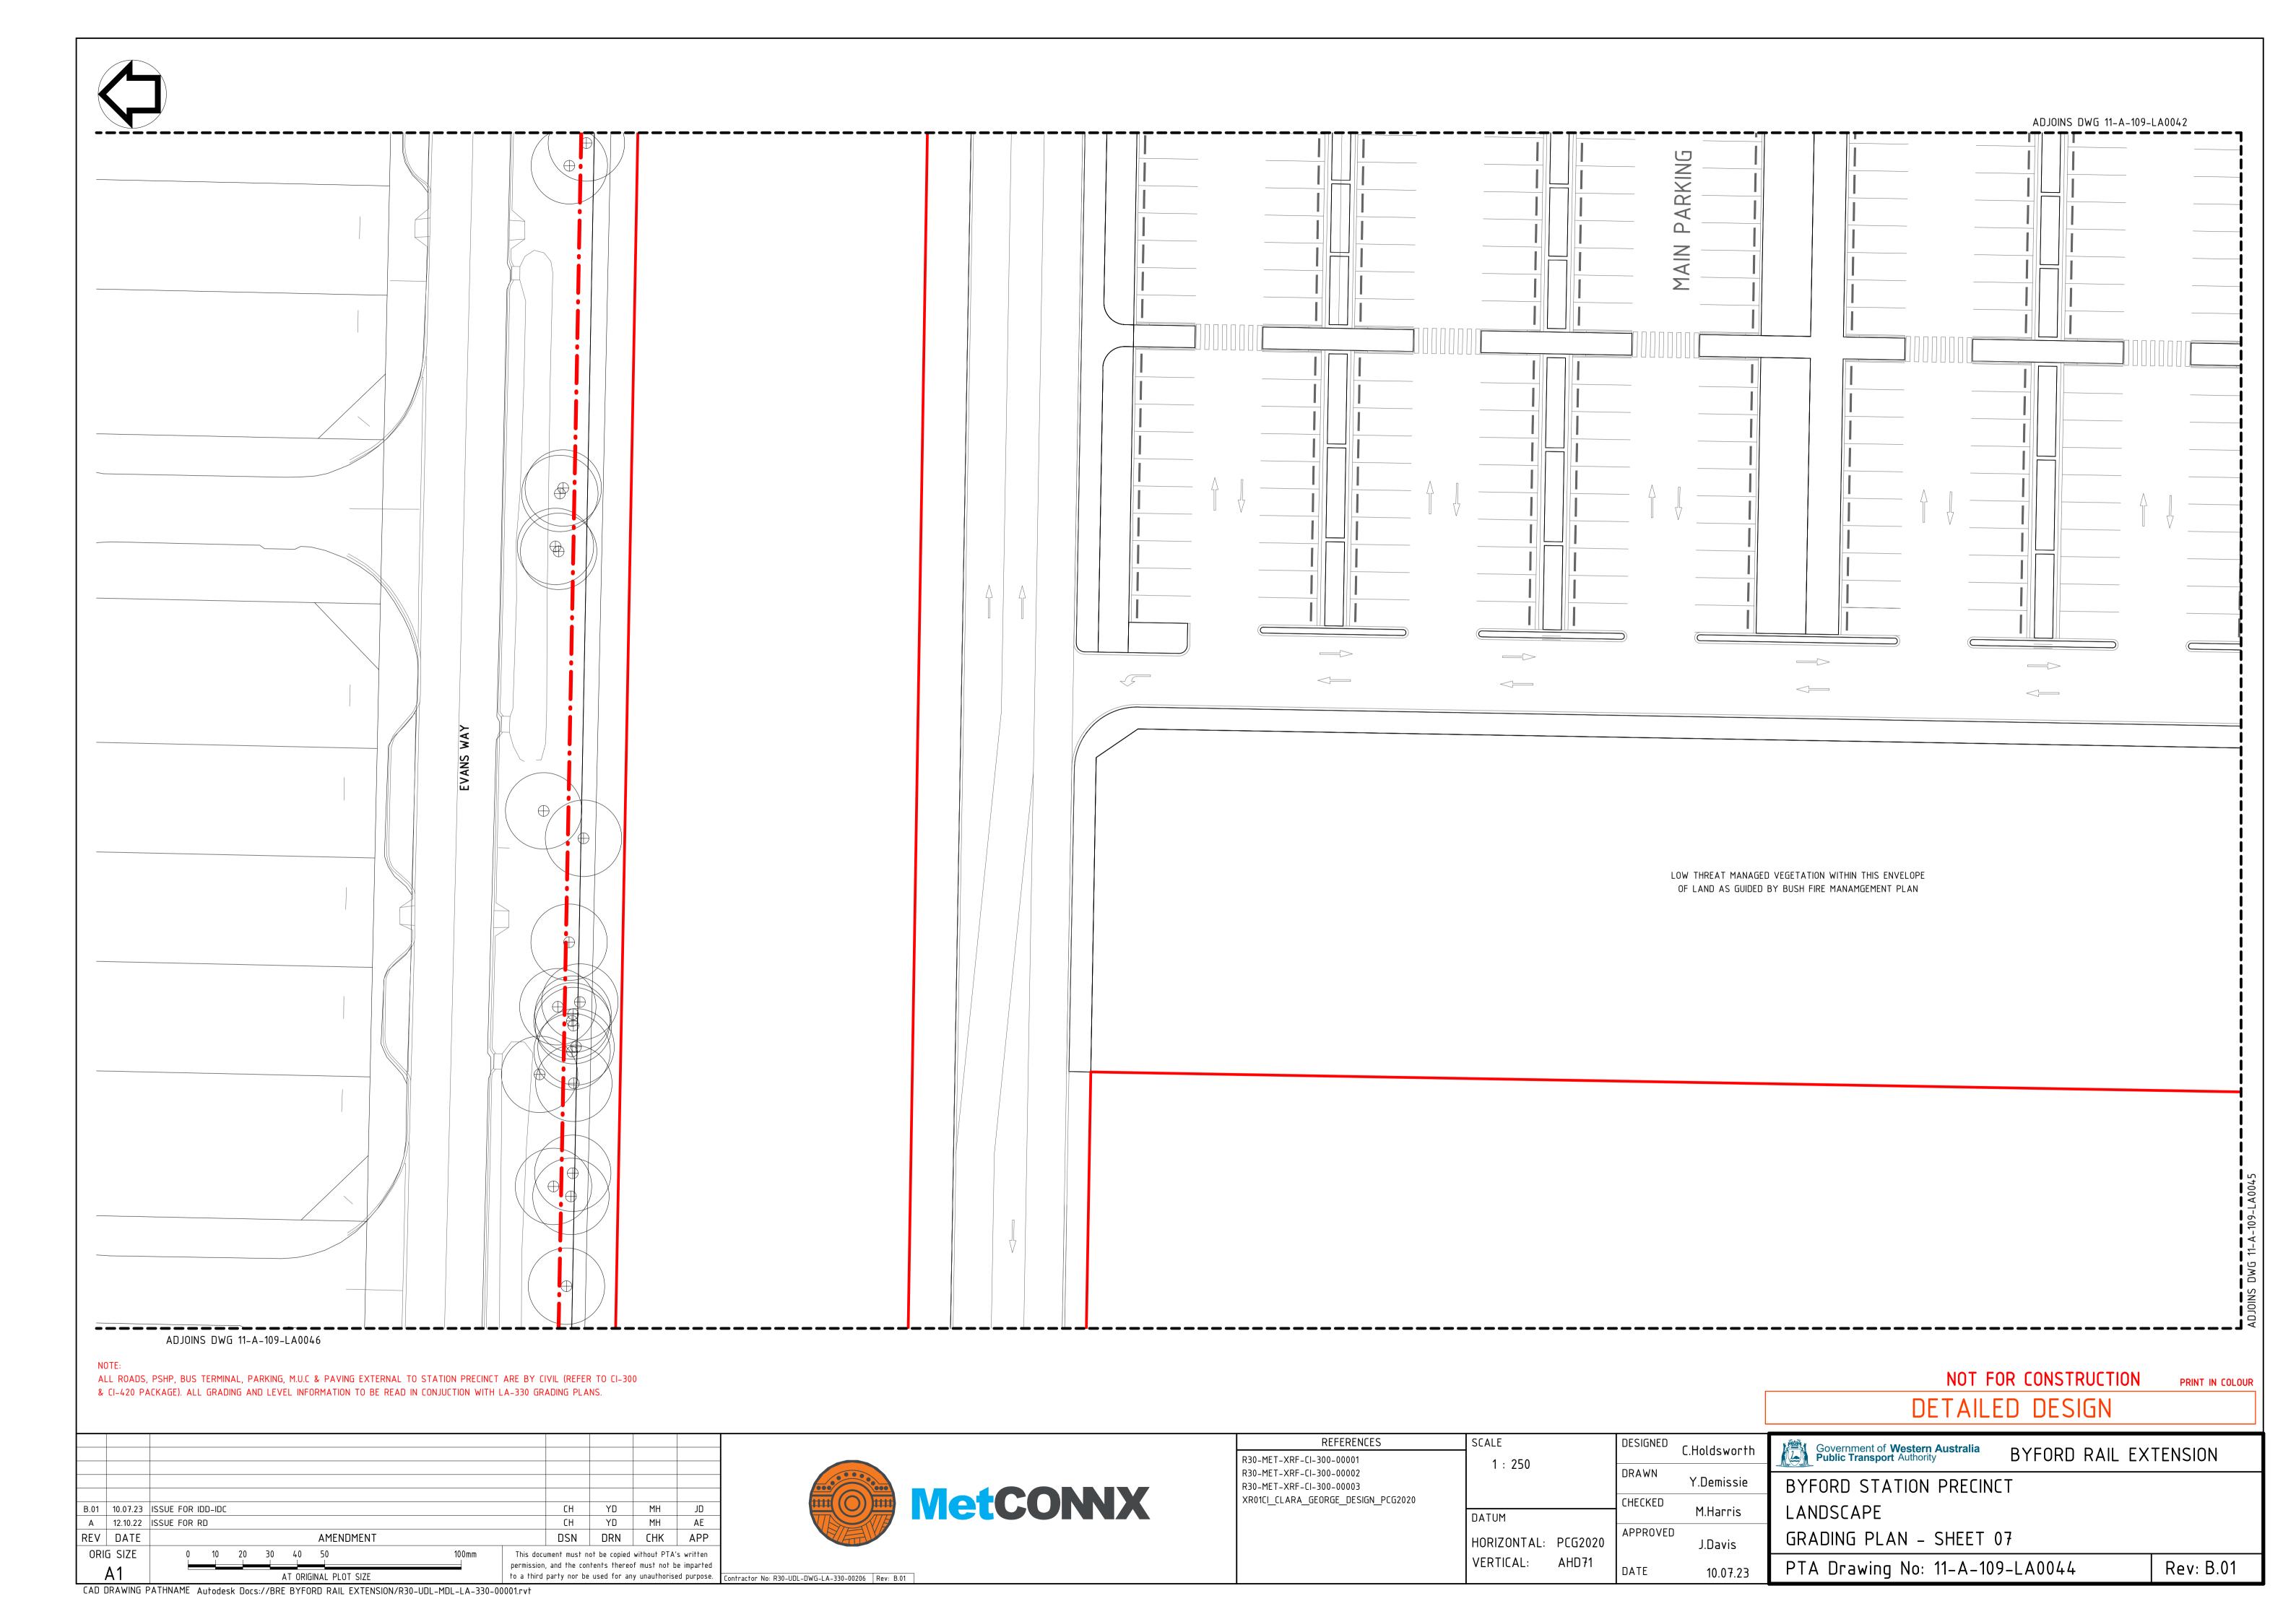


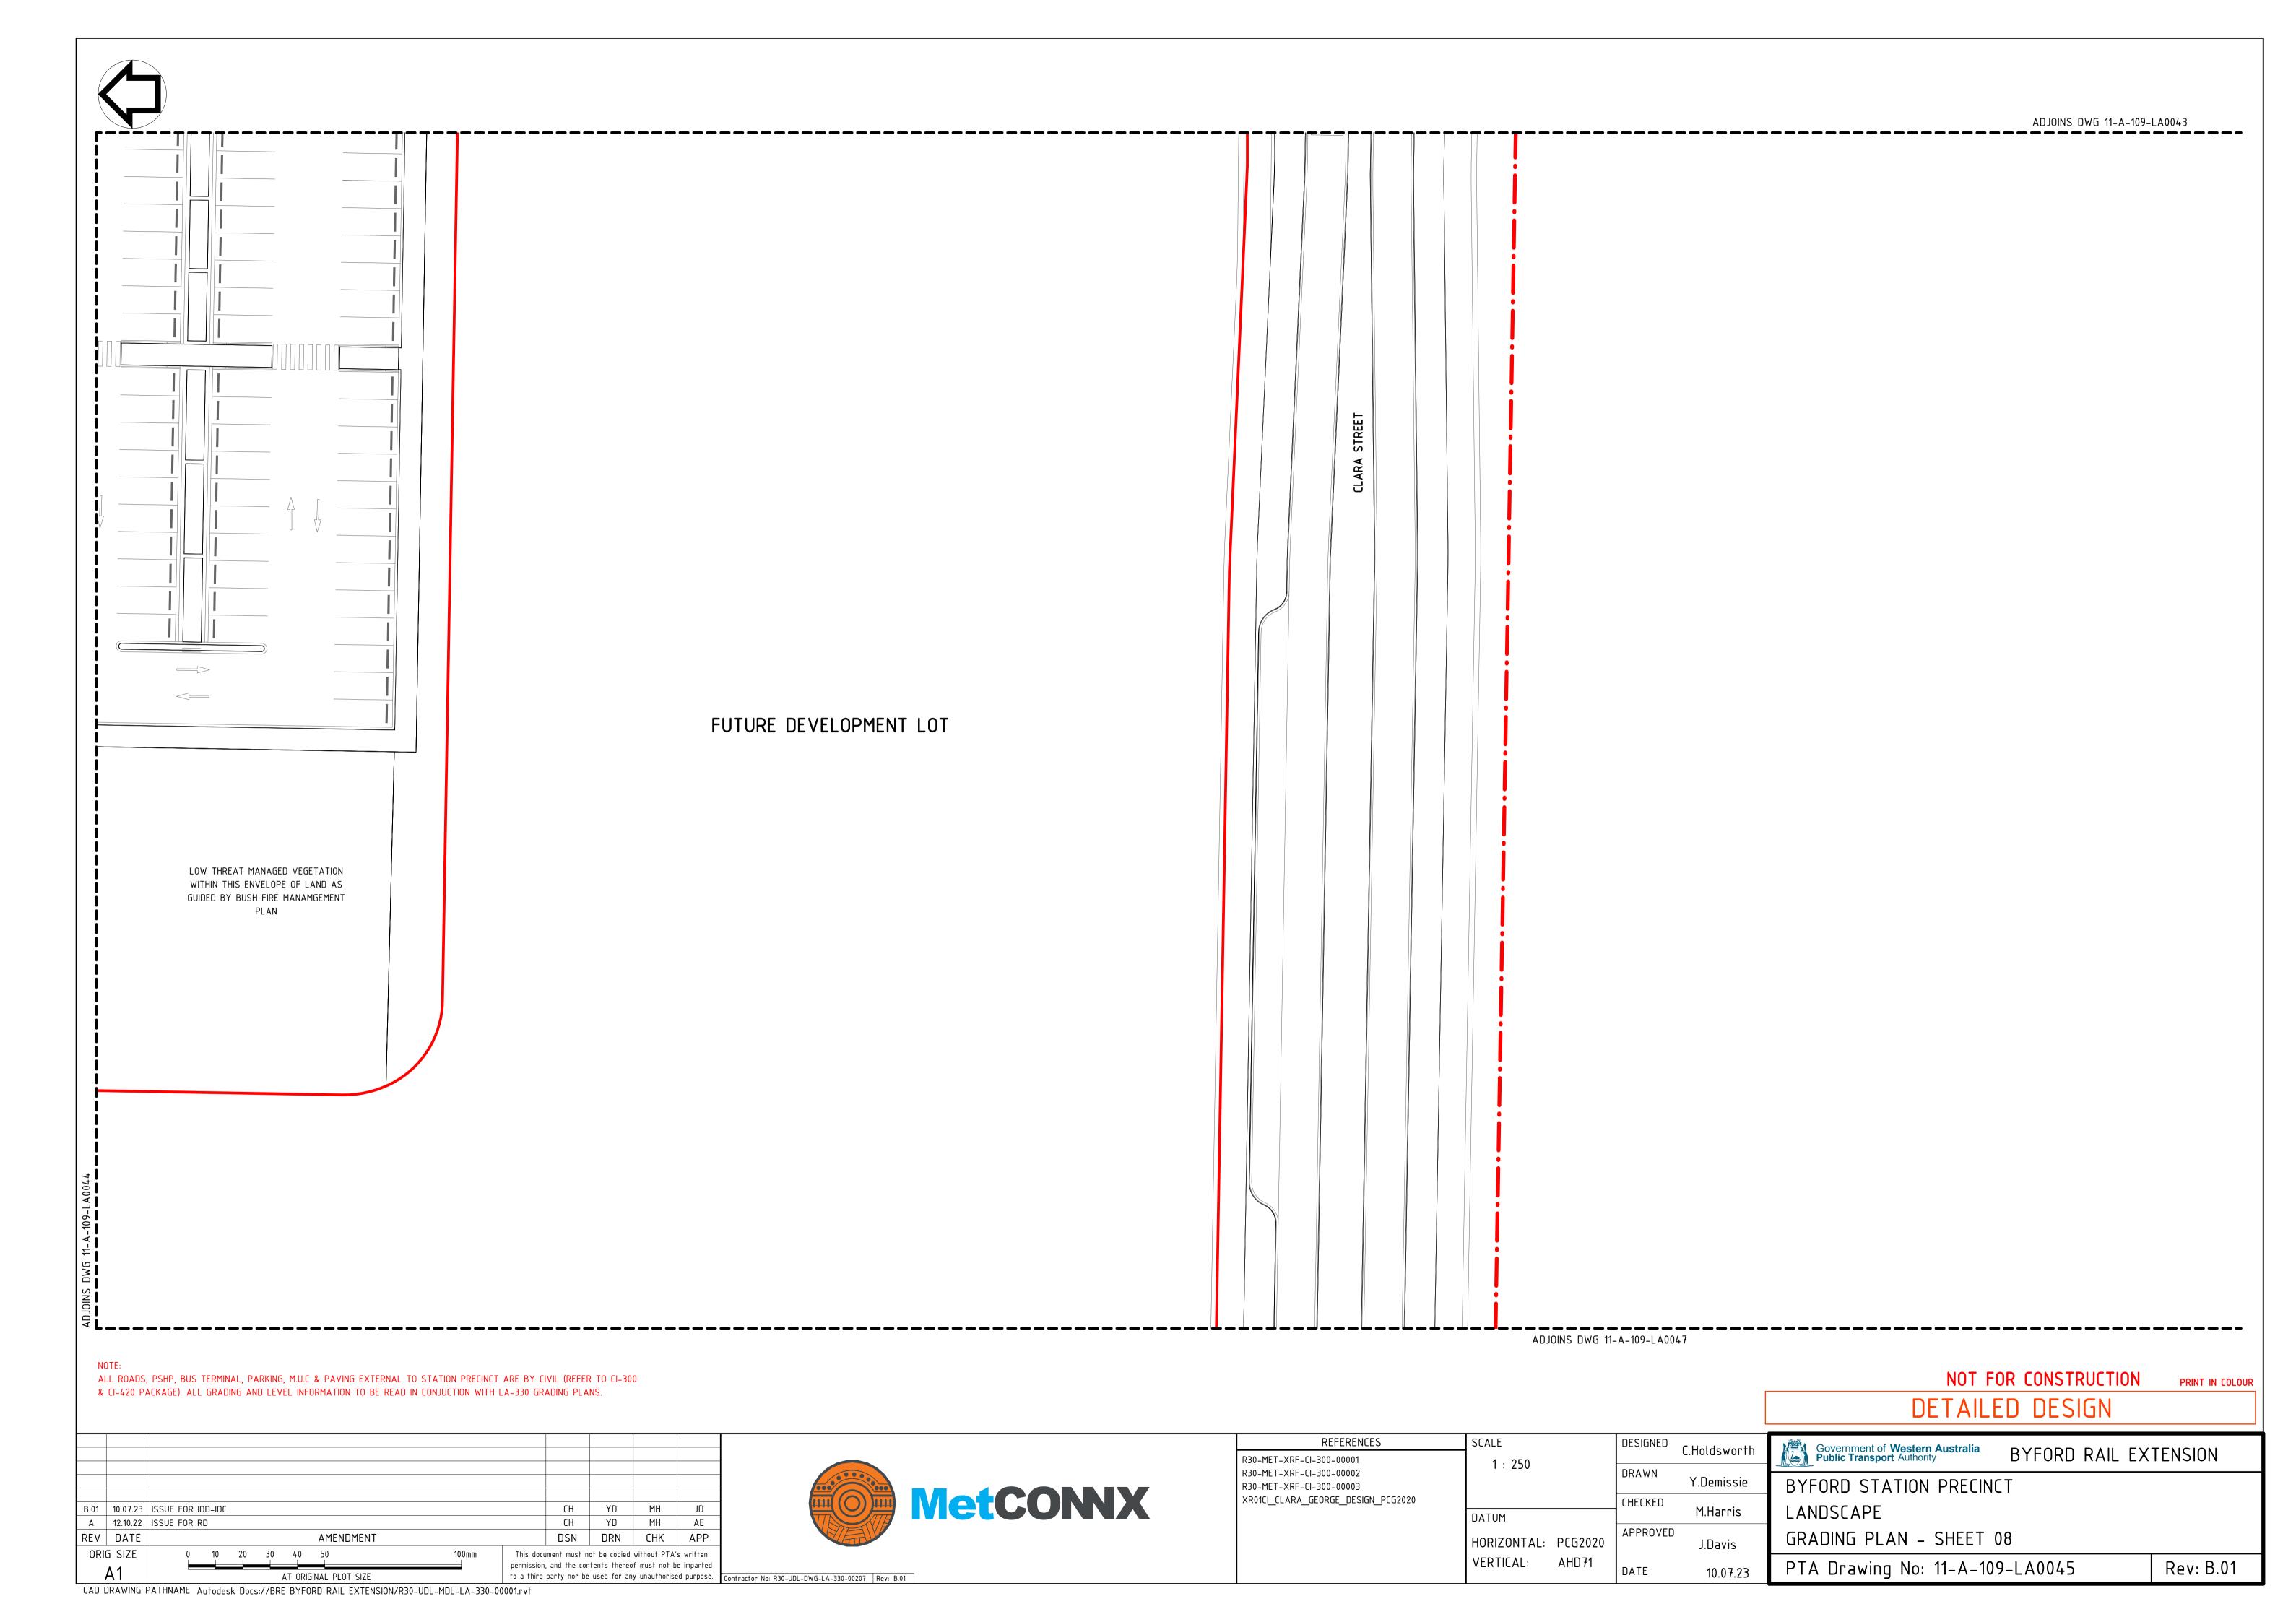


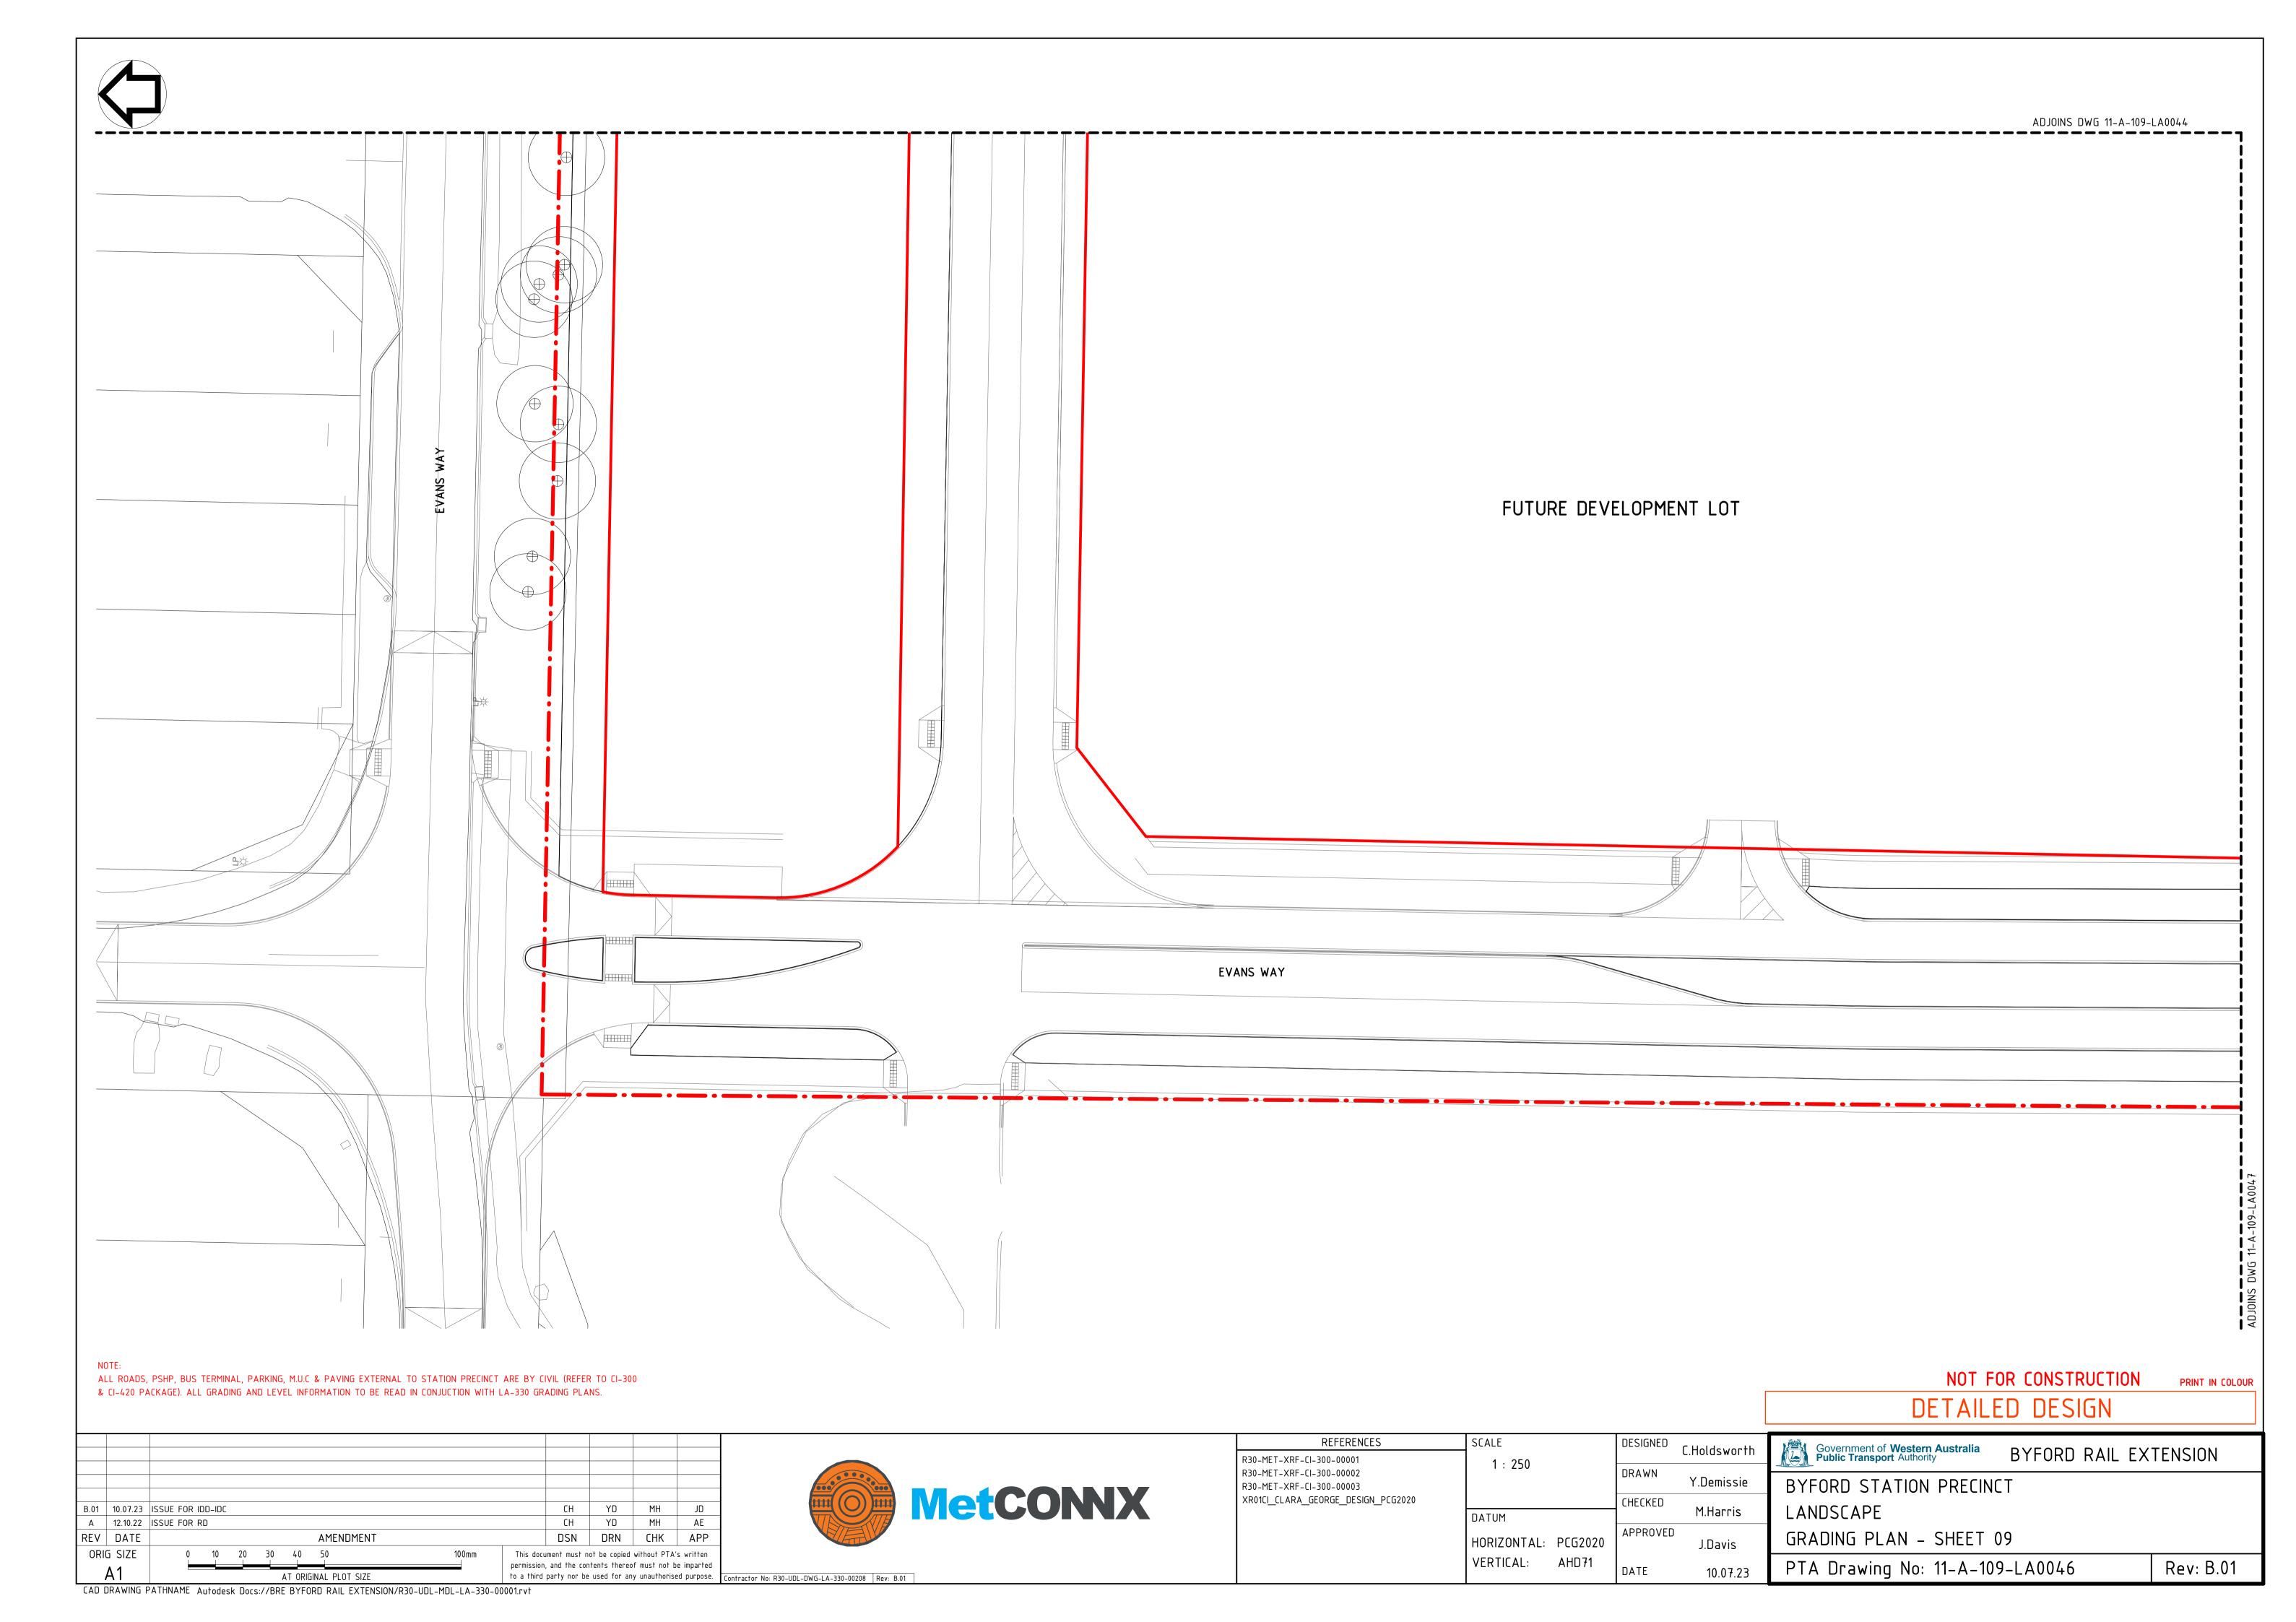


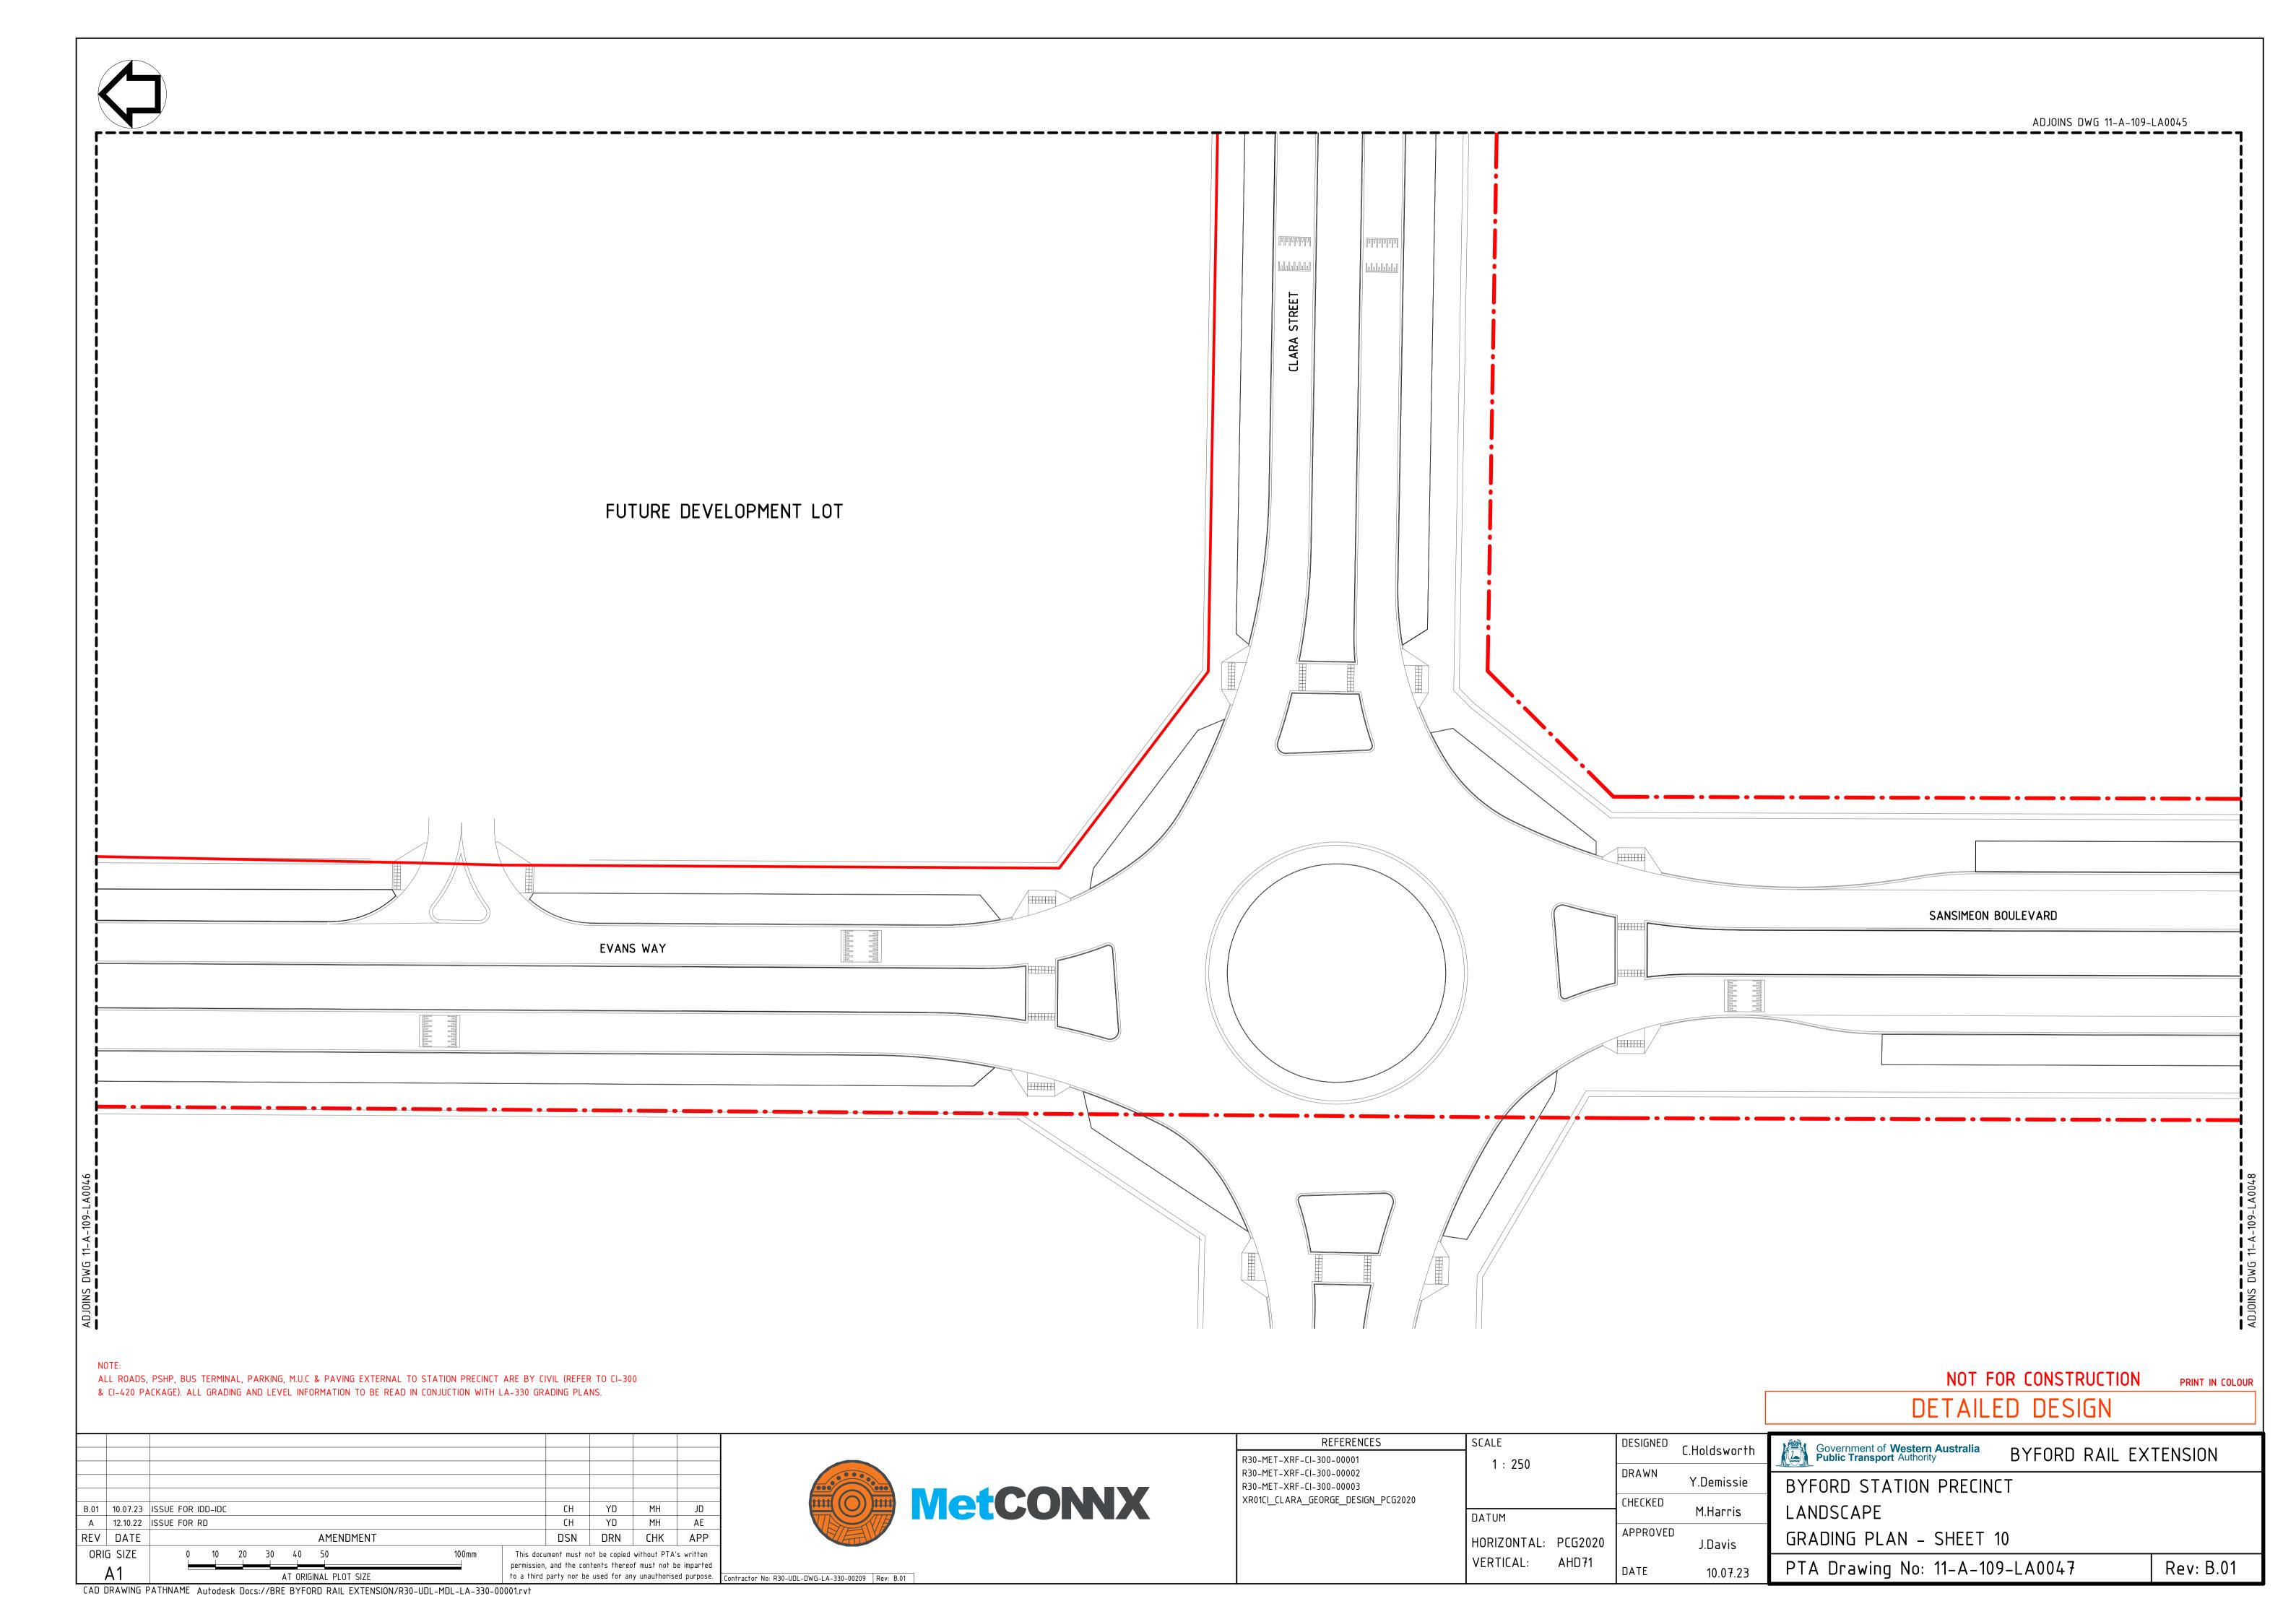



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27000			
ADJOINS DWG 11-A-109-LA			
NOTE: ALL ROADS, PSHP, BUS TERMINAL, PARKING, M.U.C & PAVING EXTERNAL TO STATION PRECINCT ARE BY CIVIL (REFER TO CI-300 & CI-420 PACKAGE). ALL GRADING AND LEVEL INFORMATION TO BE READ IN CONJUCTION WITH LA-330 GRADING PLANS.	REFERENCES	SCALE DESIGNED C.Holdswo	NOT FOR CONSTRUCTION PRINT IN COLOUR DETAILED DESIGN
B.01 10.07.23 ISSUE FOR IDD-IDC A 12.10.22 ISSUE FOR RD CH YD MH JD AT DRIG SIZE A1 ORIG SIZE A1 ORIG SIZE A1 ORIGINAL PLOT SIZE Contractor No: R30-UDL-DWG-LA-330-00210 Rev: B.01	R30-MET-XRF-CI-300-00001 R30-MET-XRF-CI-300-00002 R30-MET-XRF-CI-300-00003 XR01CI_CLARA_GEORGE_DESIGN_PCG2020	1: 250 DRAWN Y.Demis CHECKED M.Harr HORIZONTAL: PCG2020 VERTICAL: AHD31	Sie BYFORD STATION PRECINCT is LANDSCAPE CDADING DUAN GUEET 44

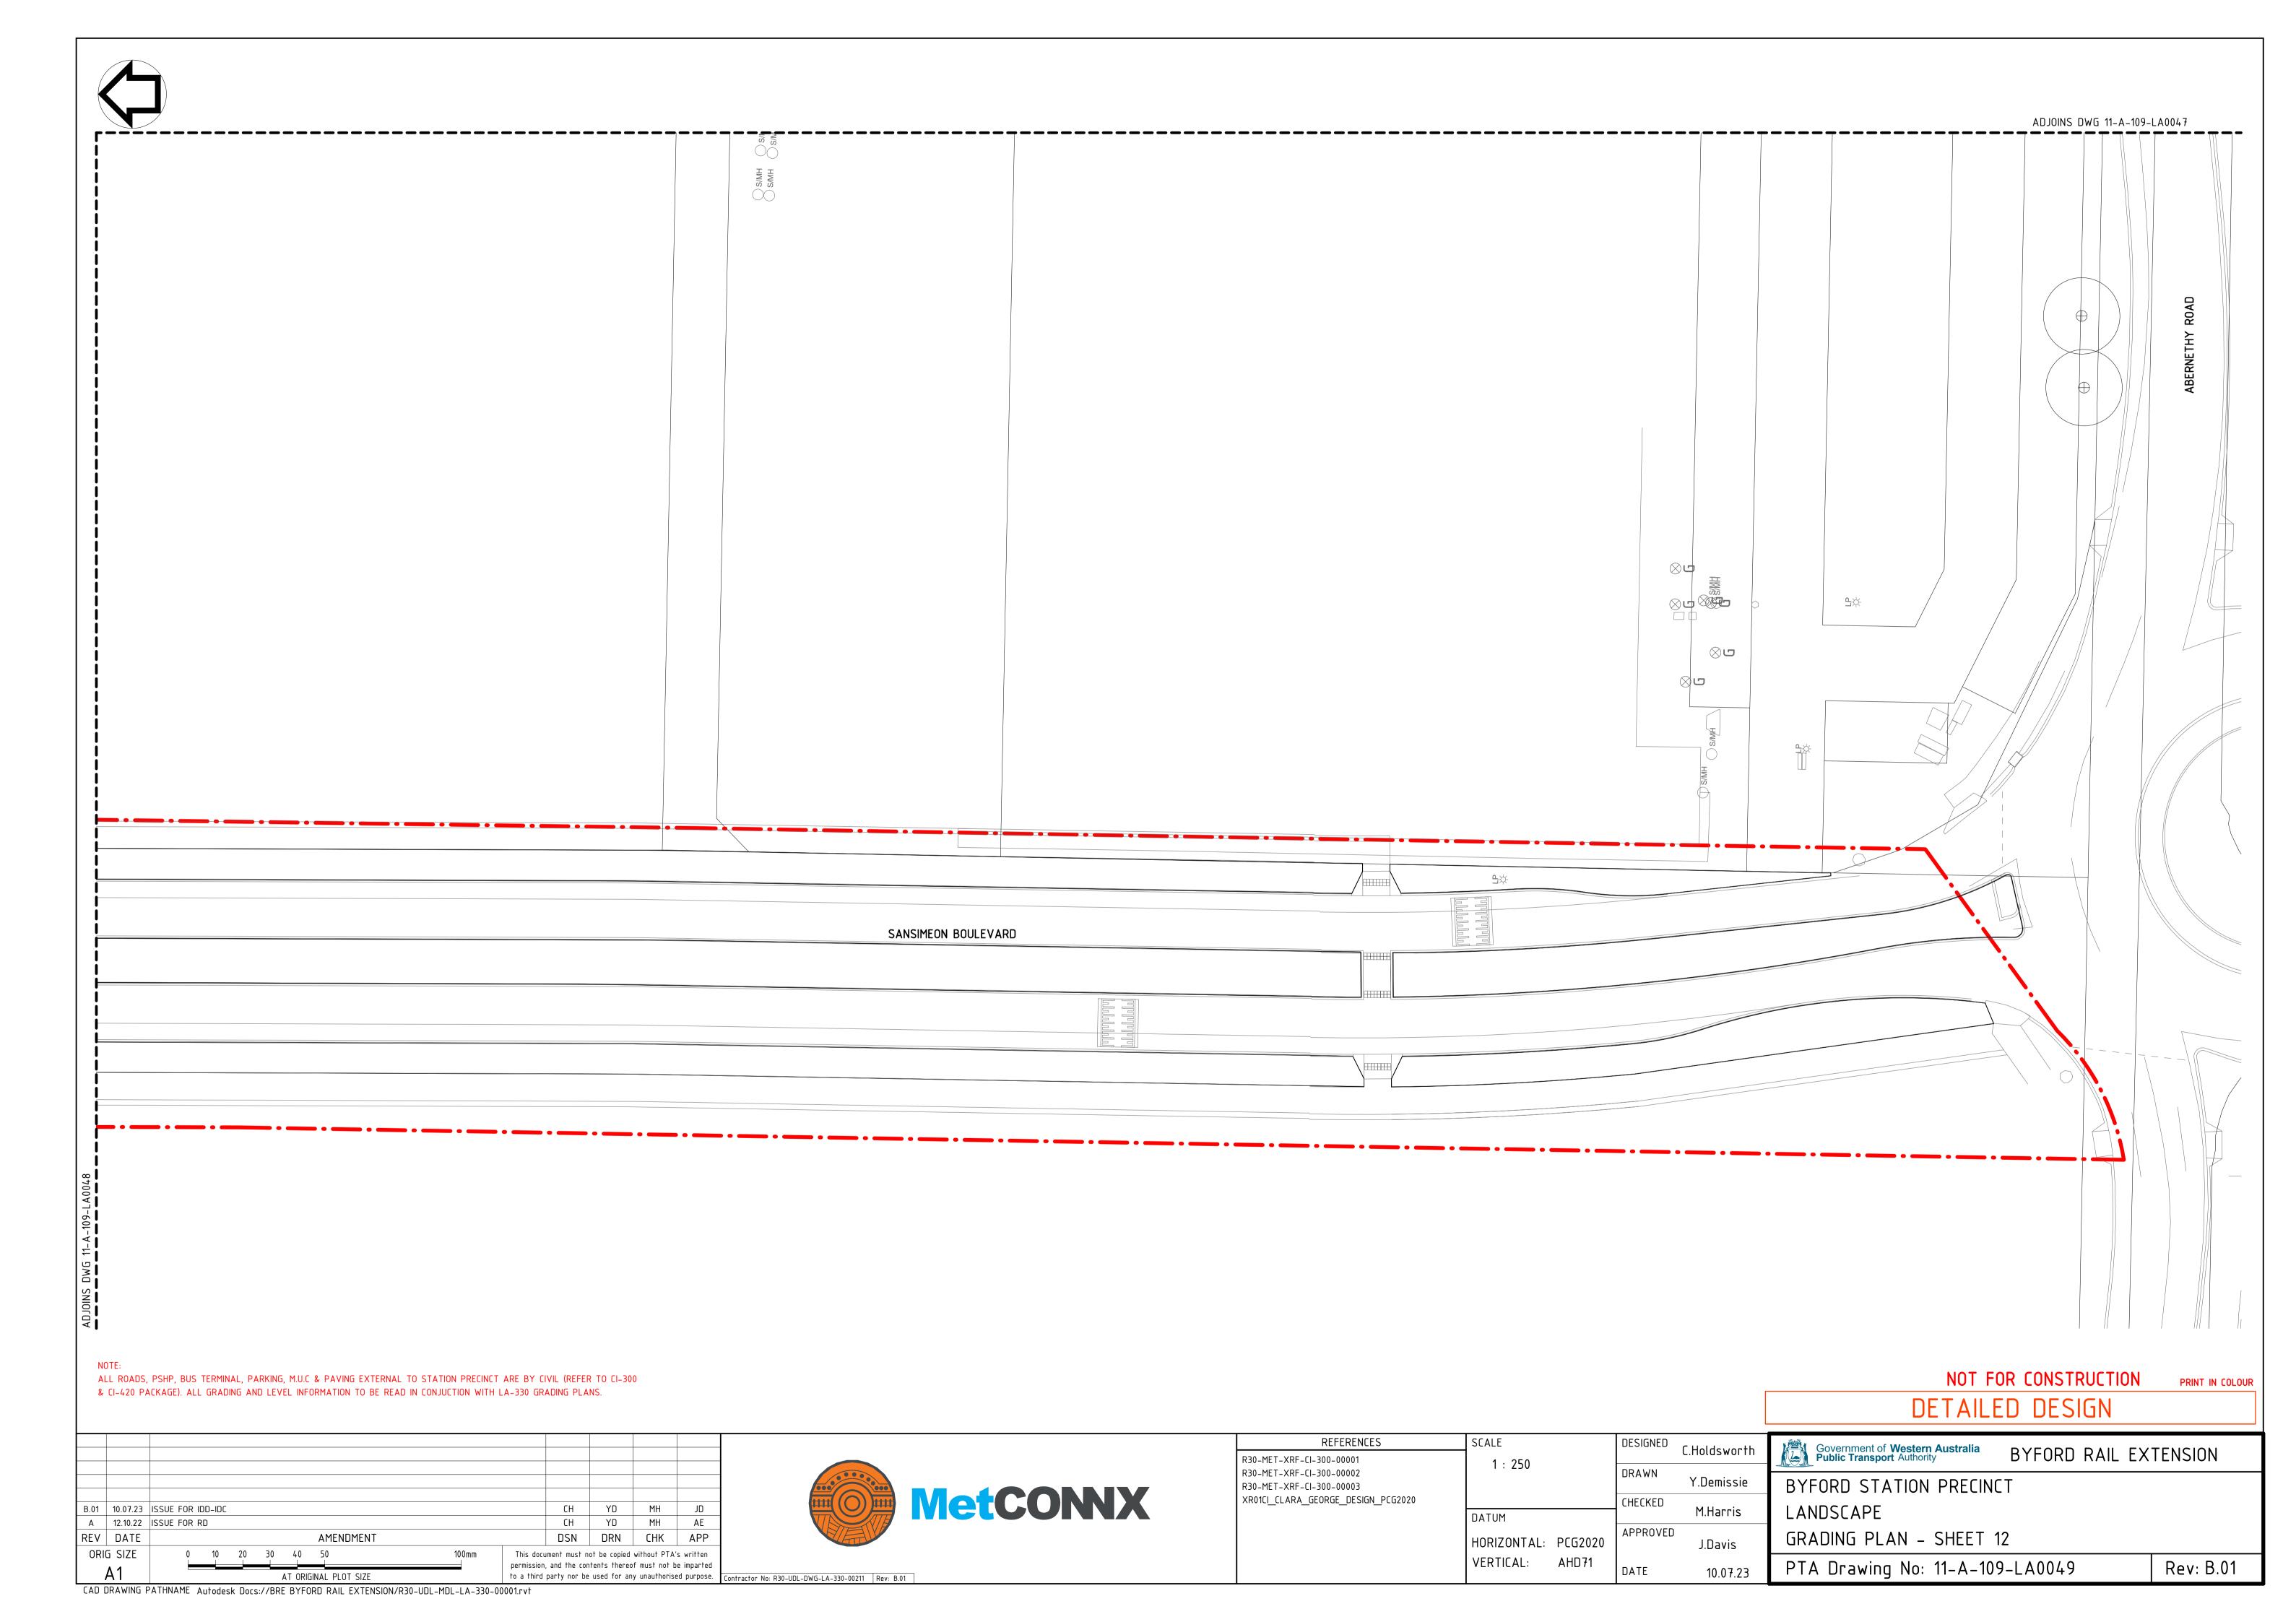


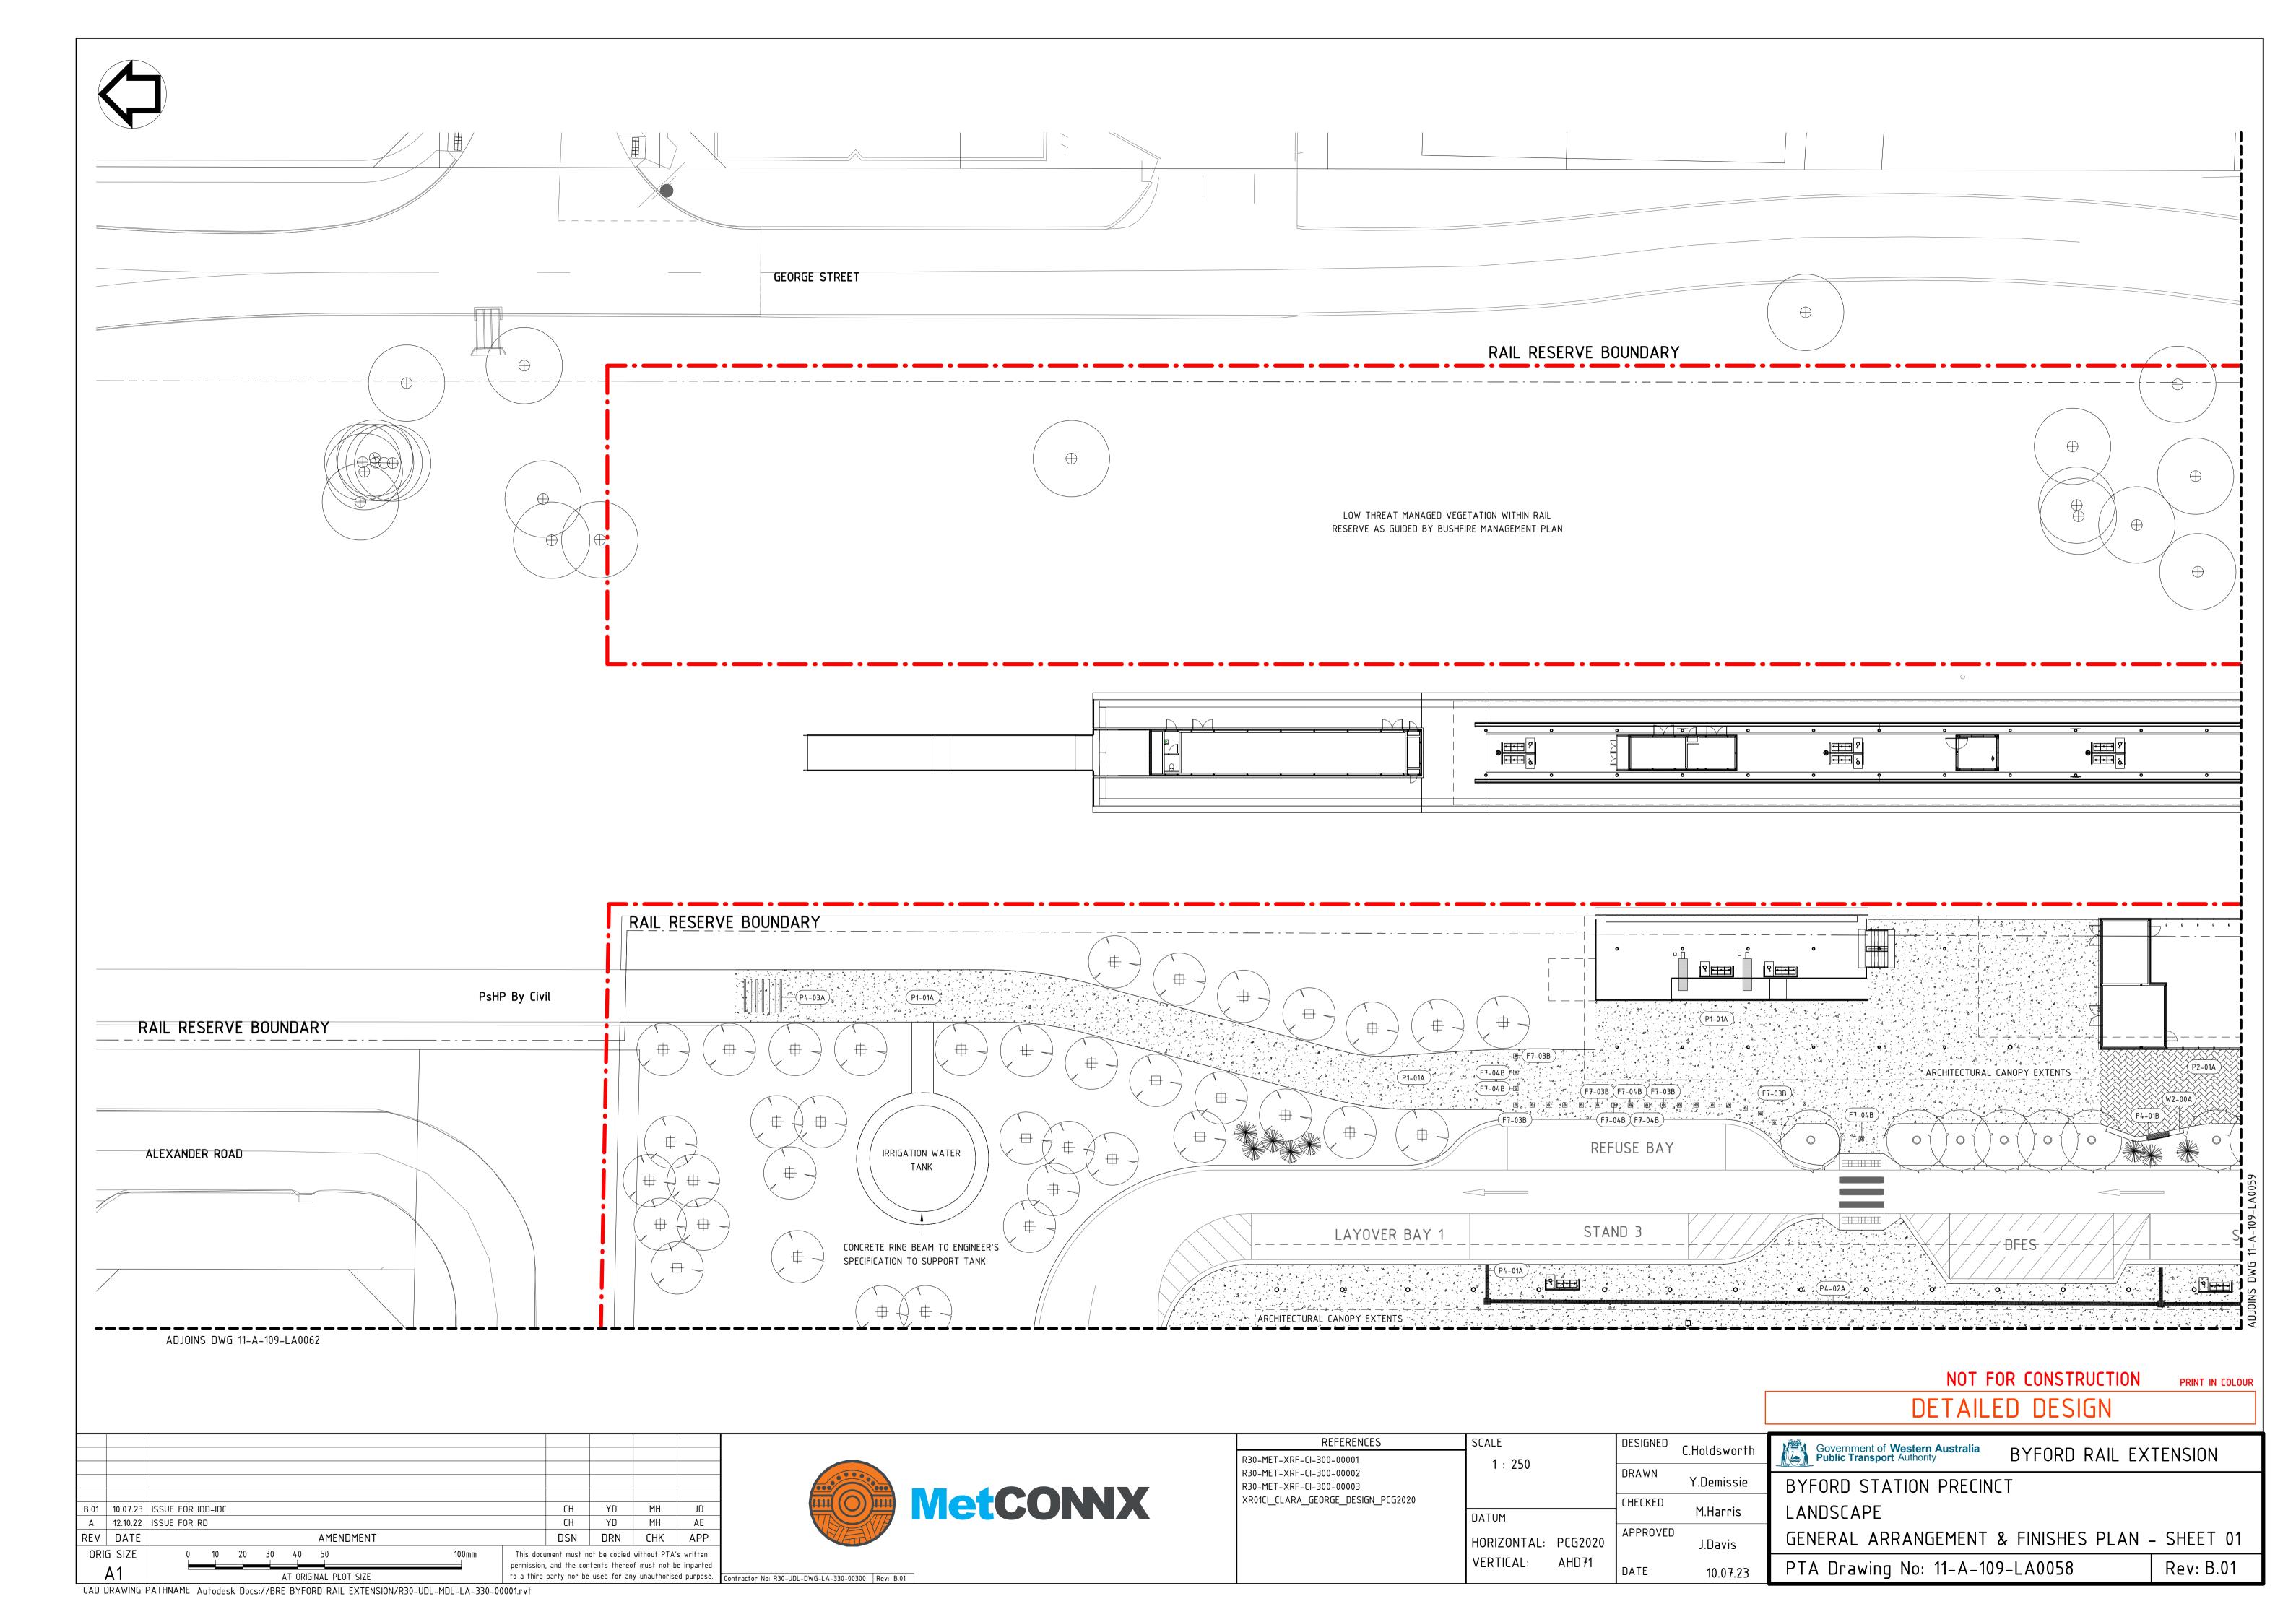


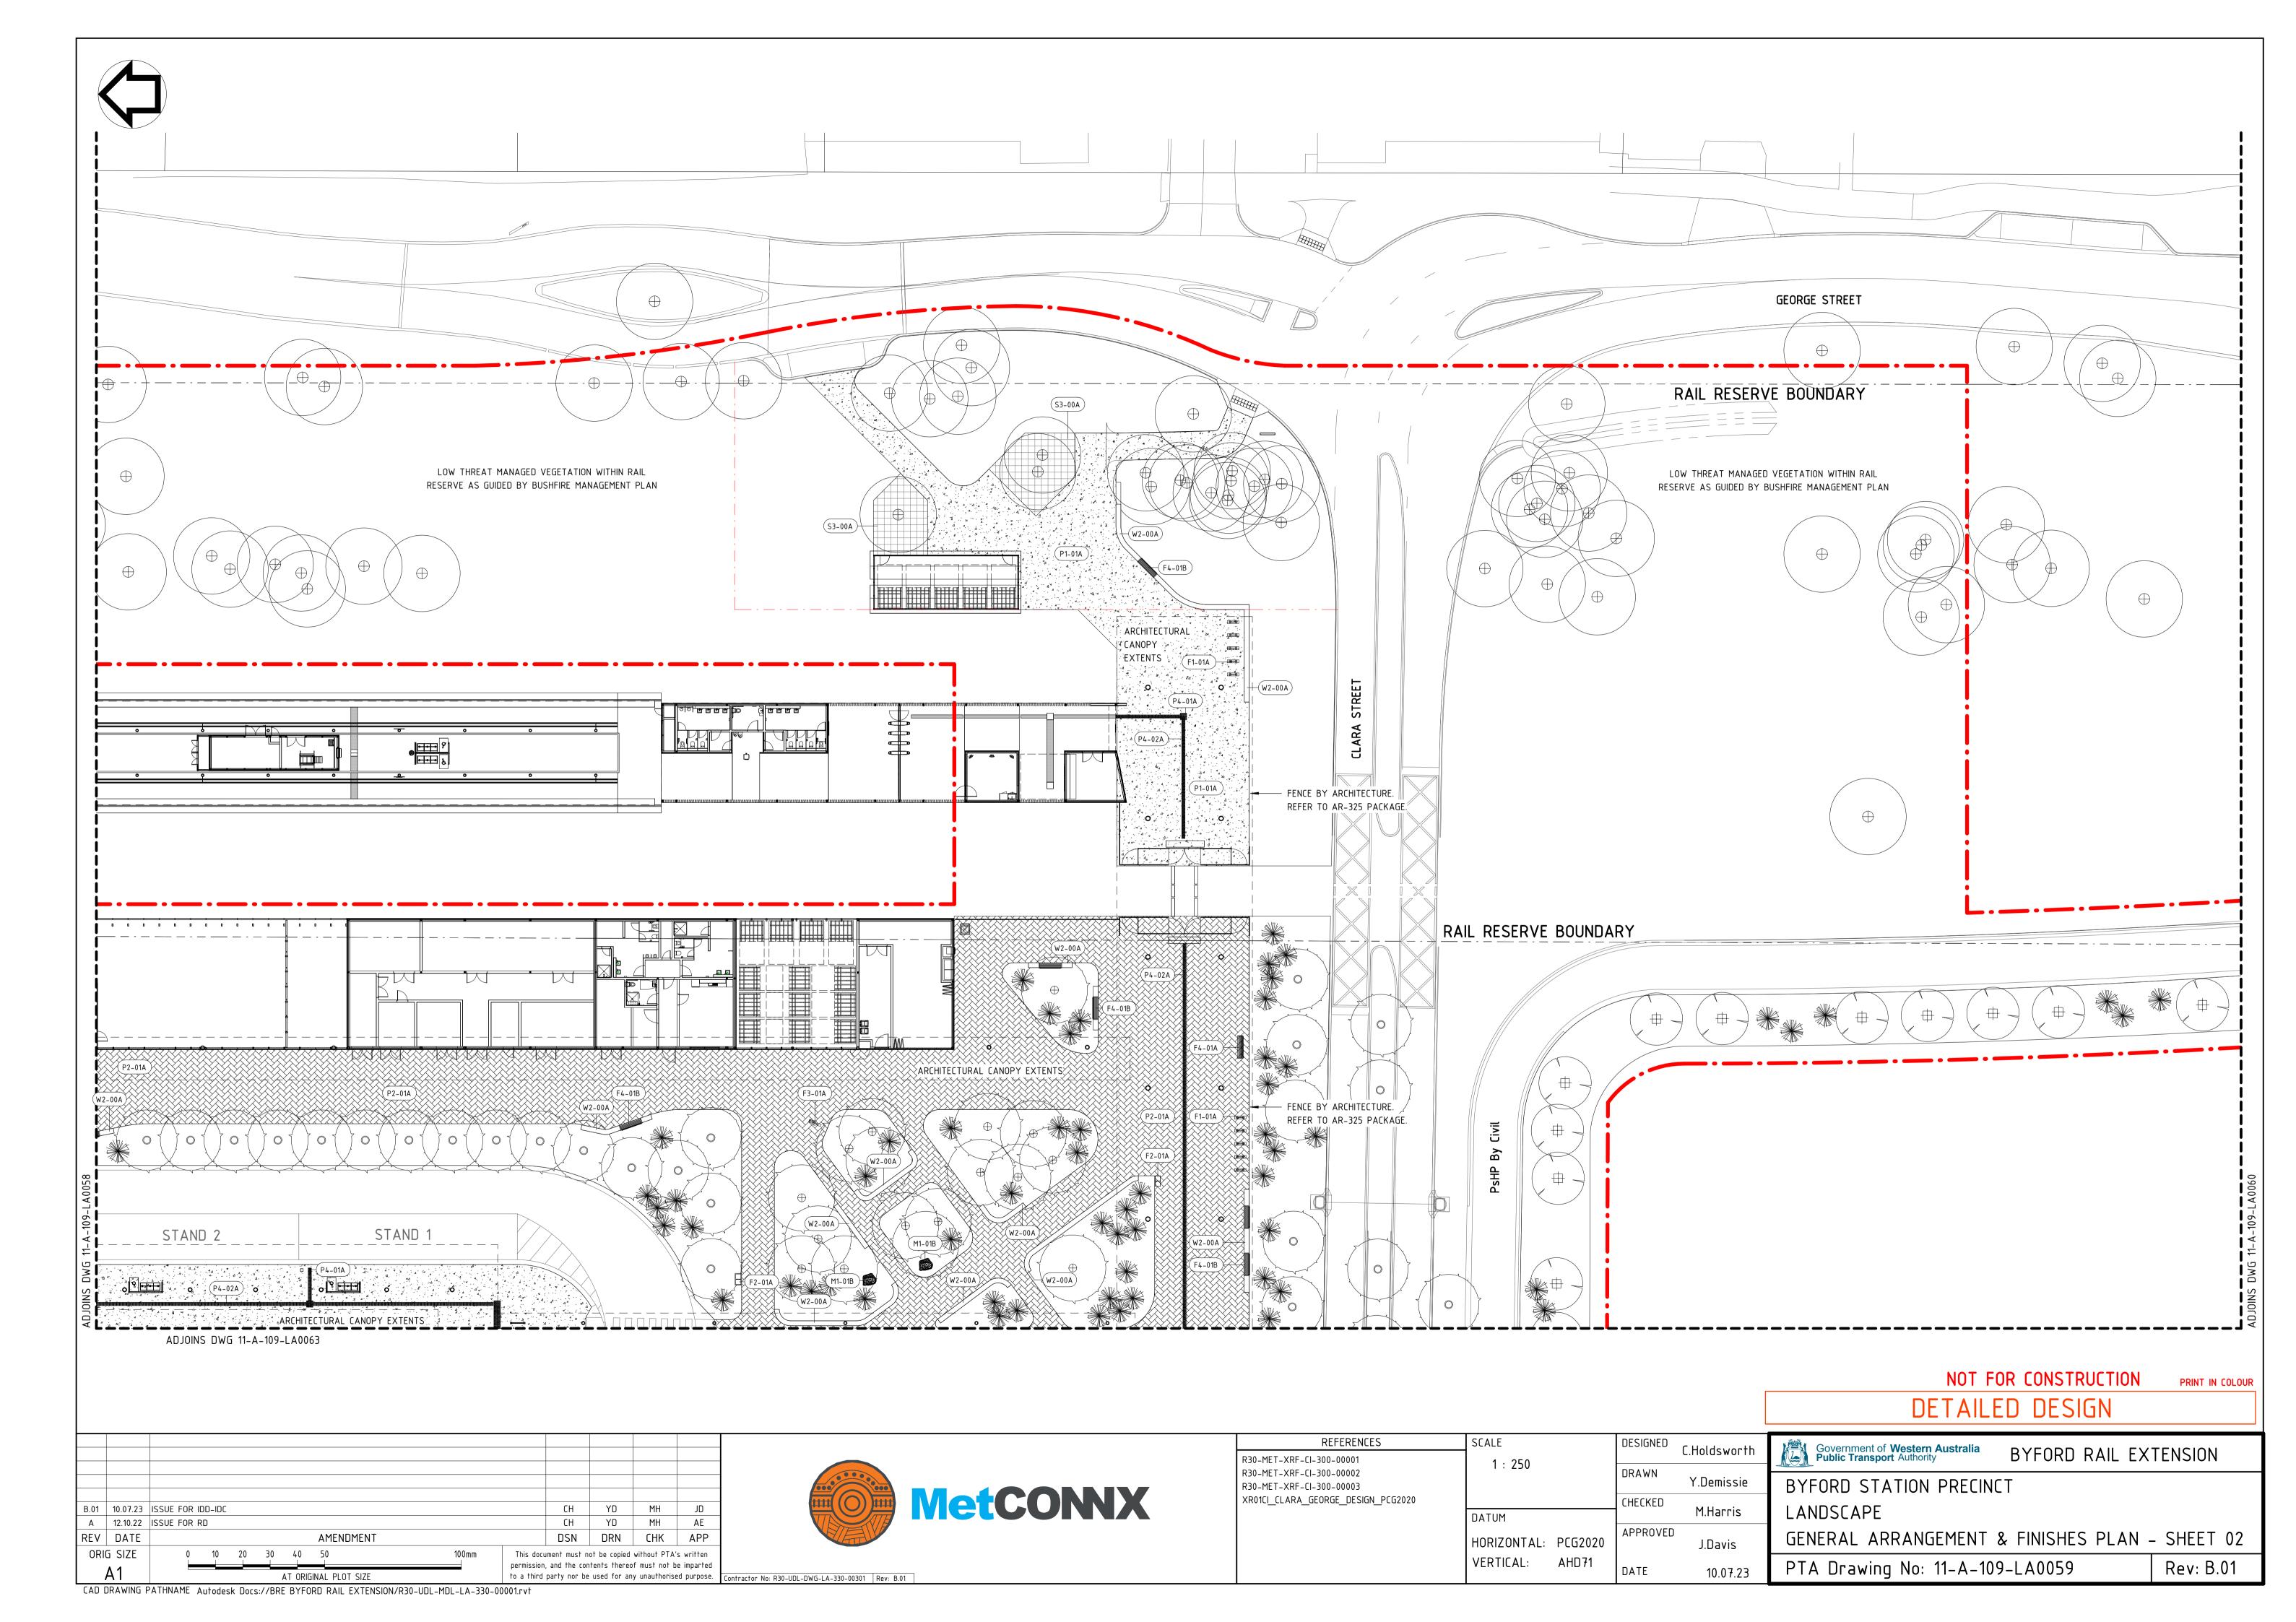


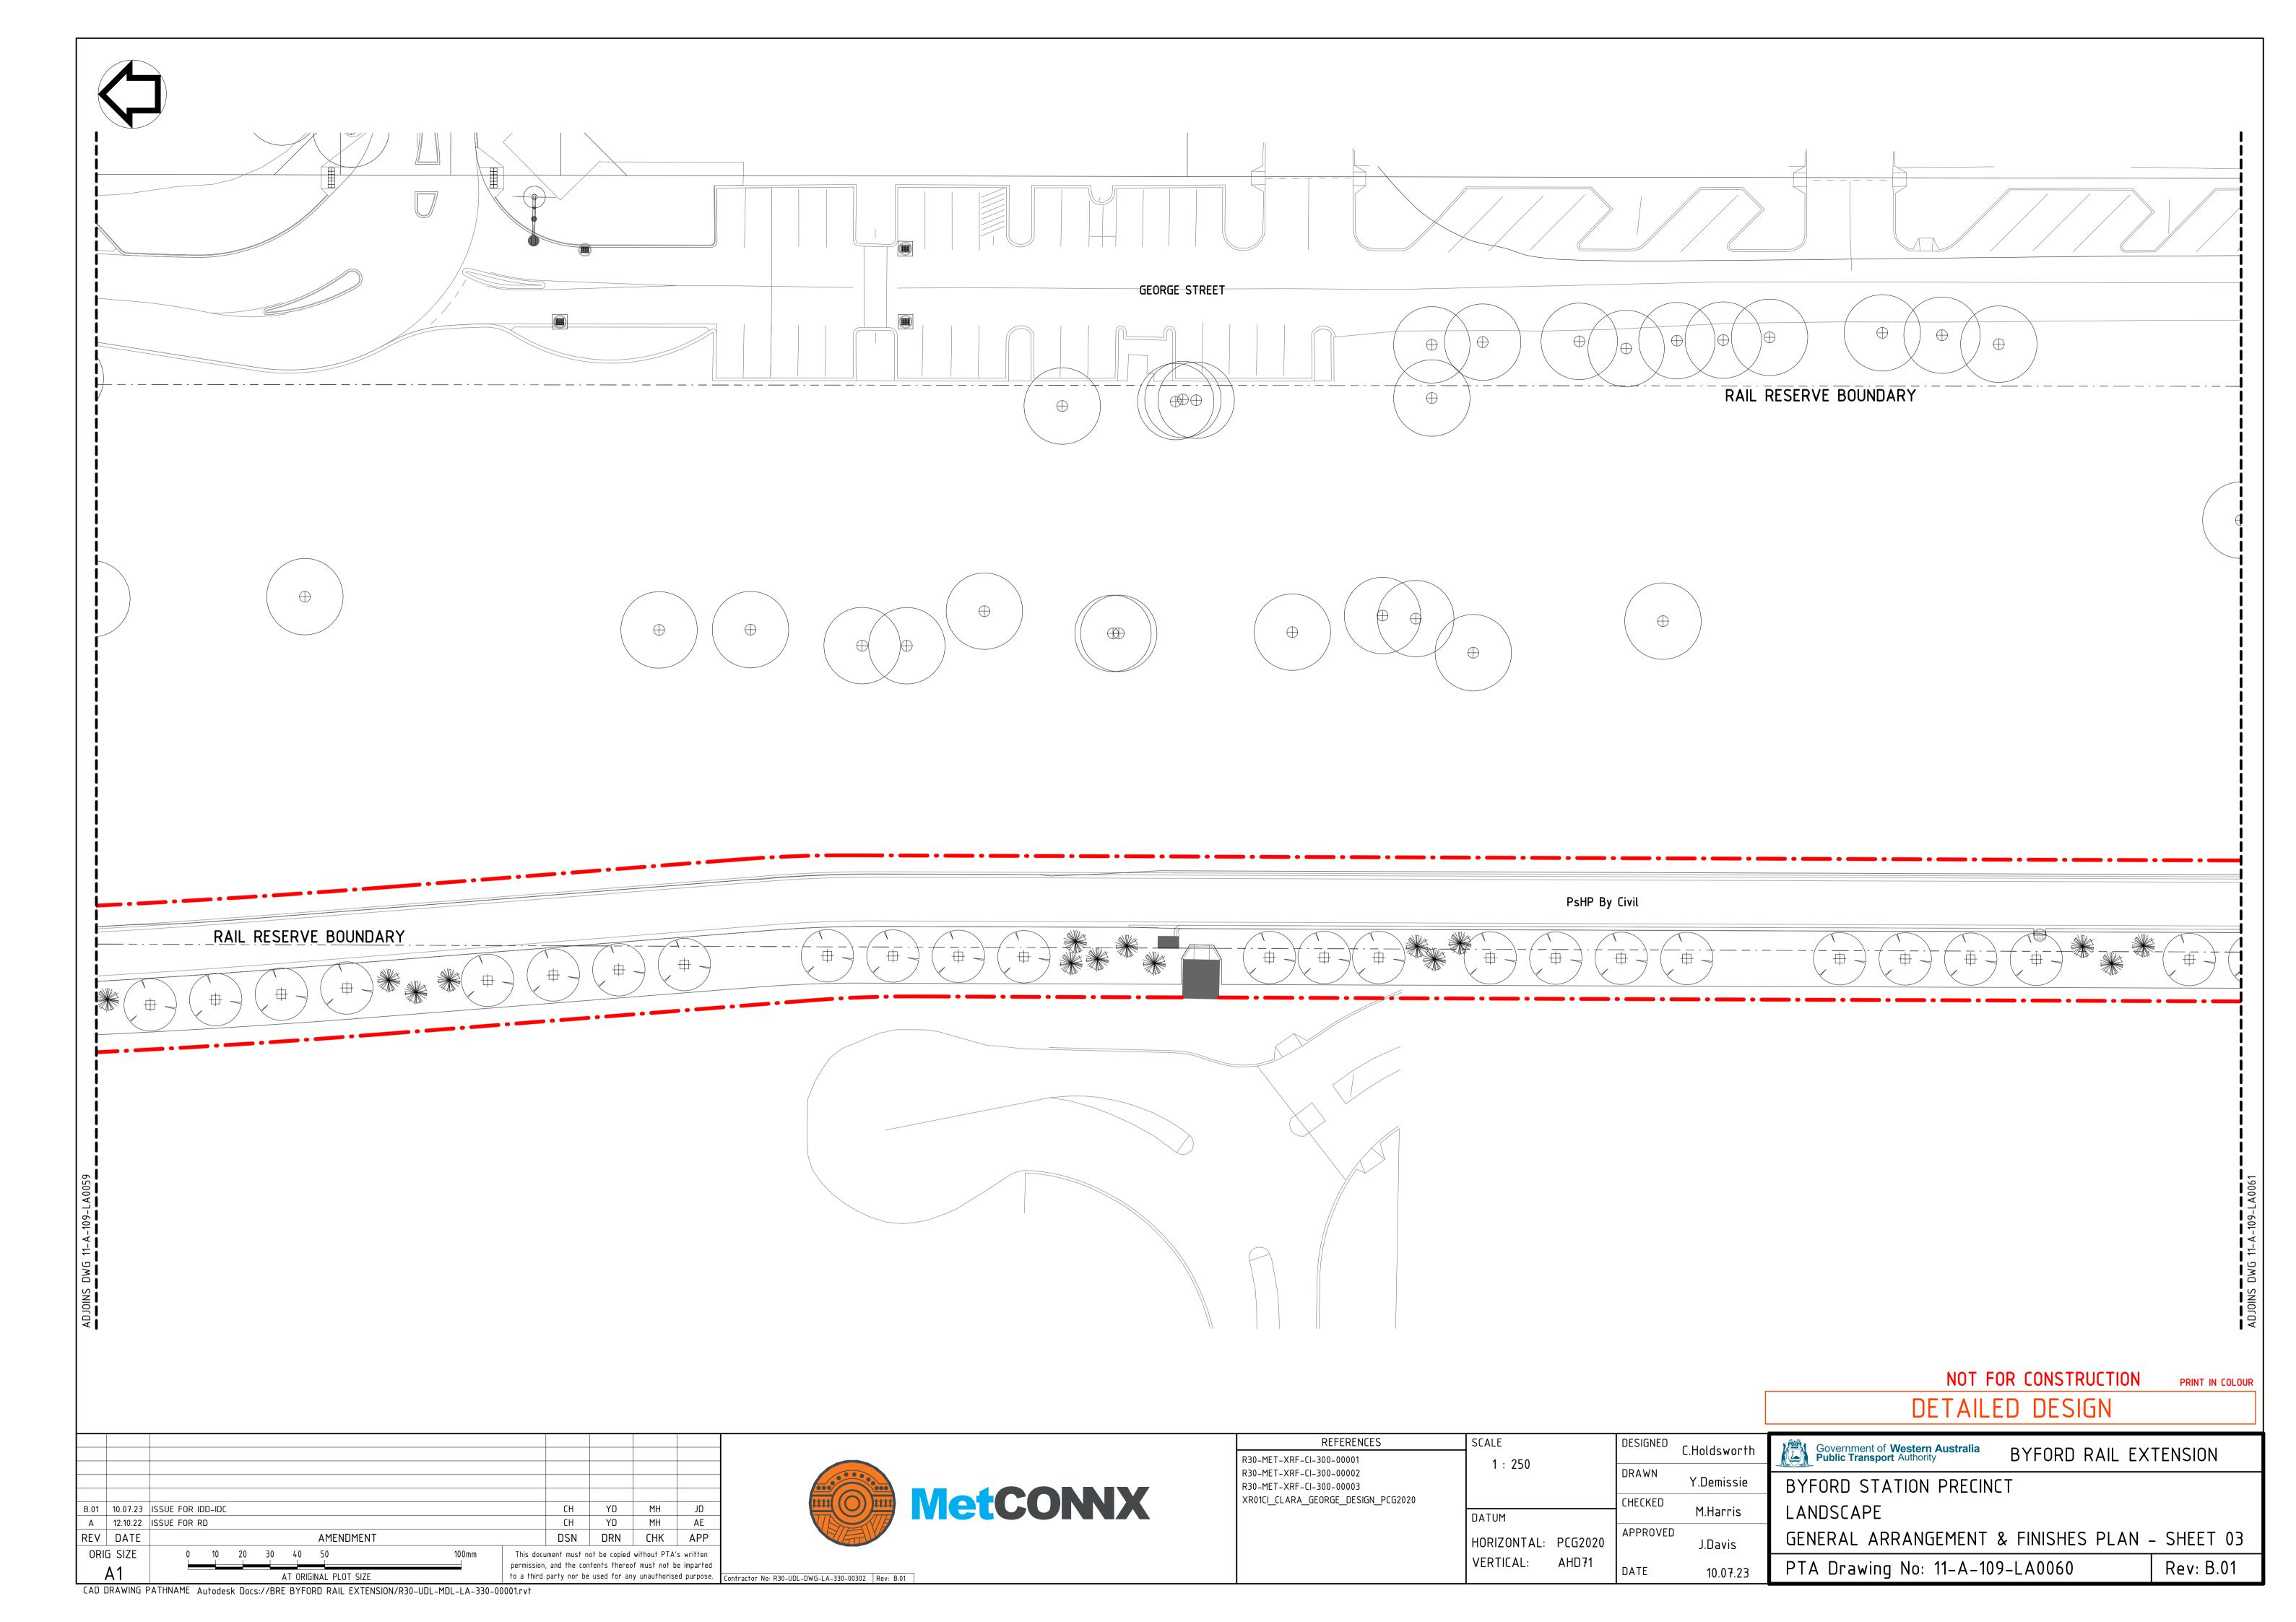


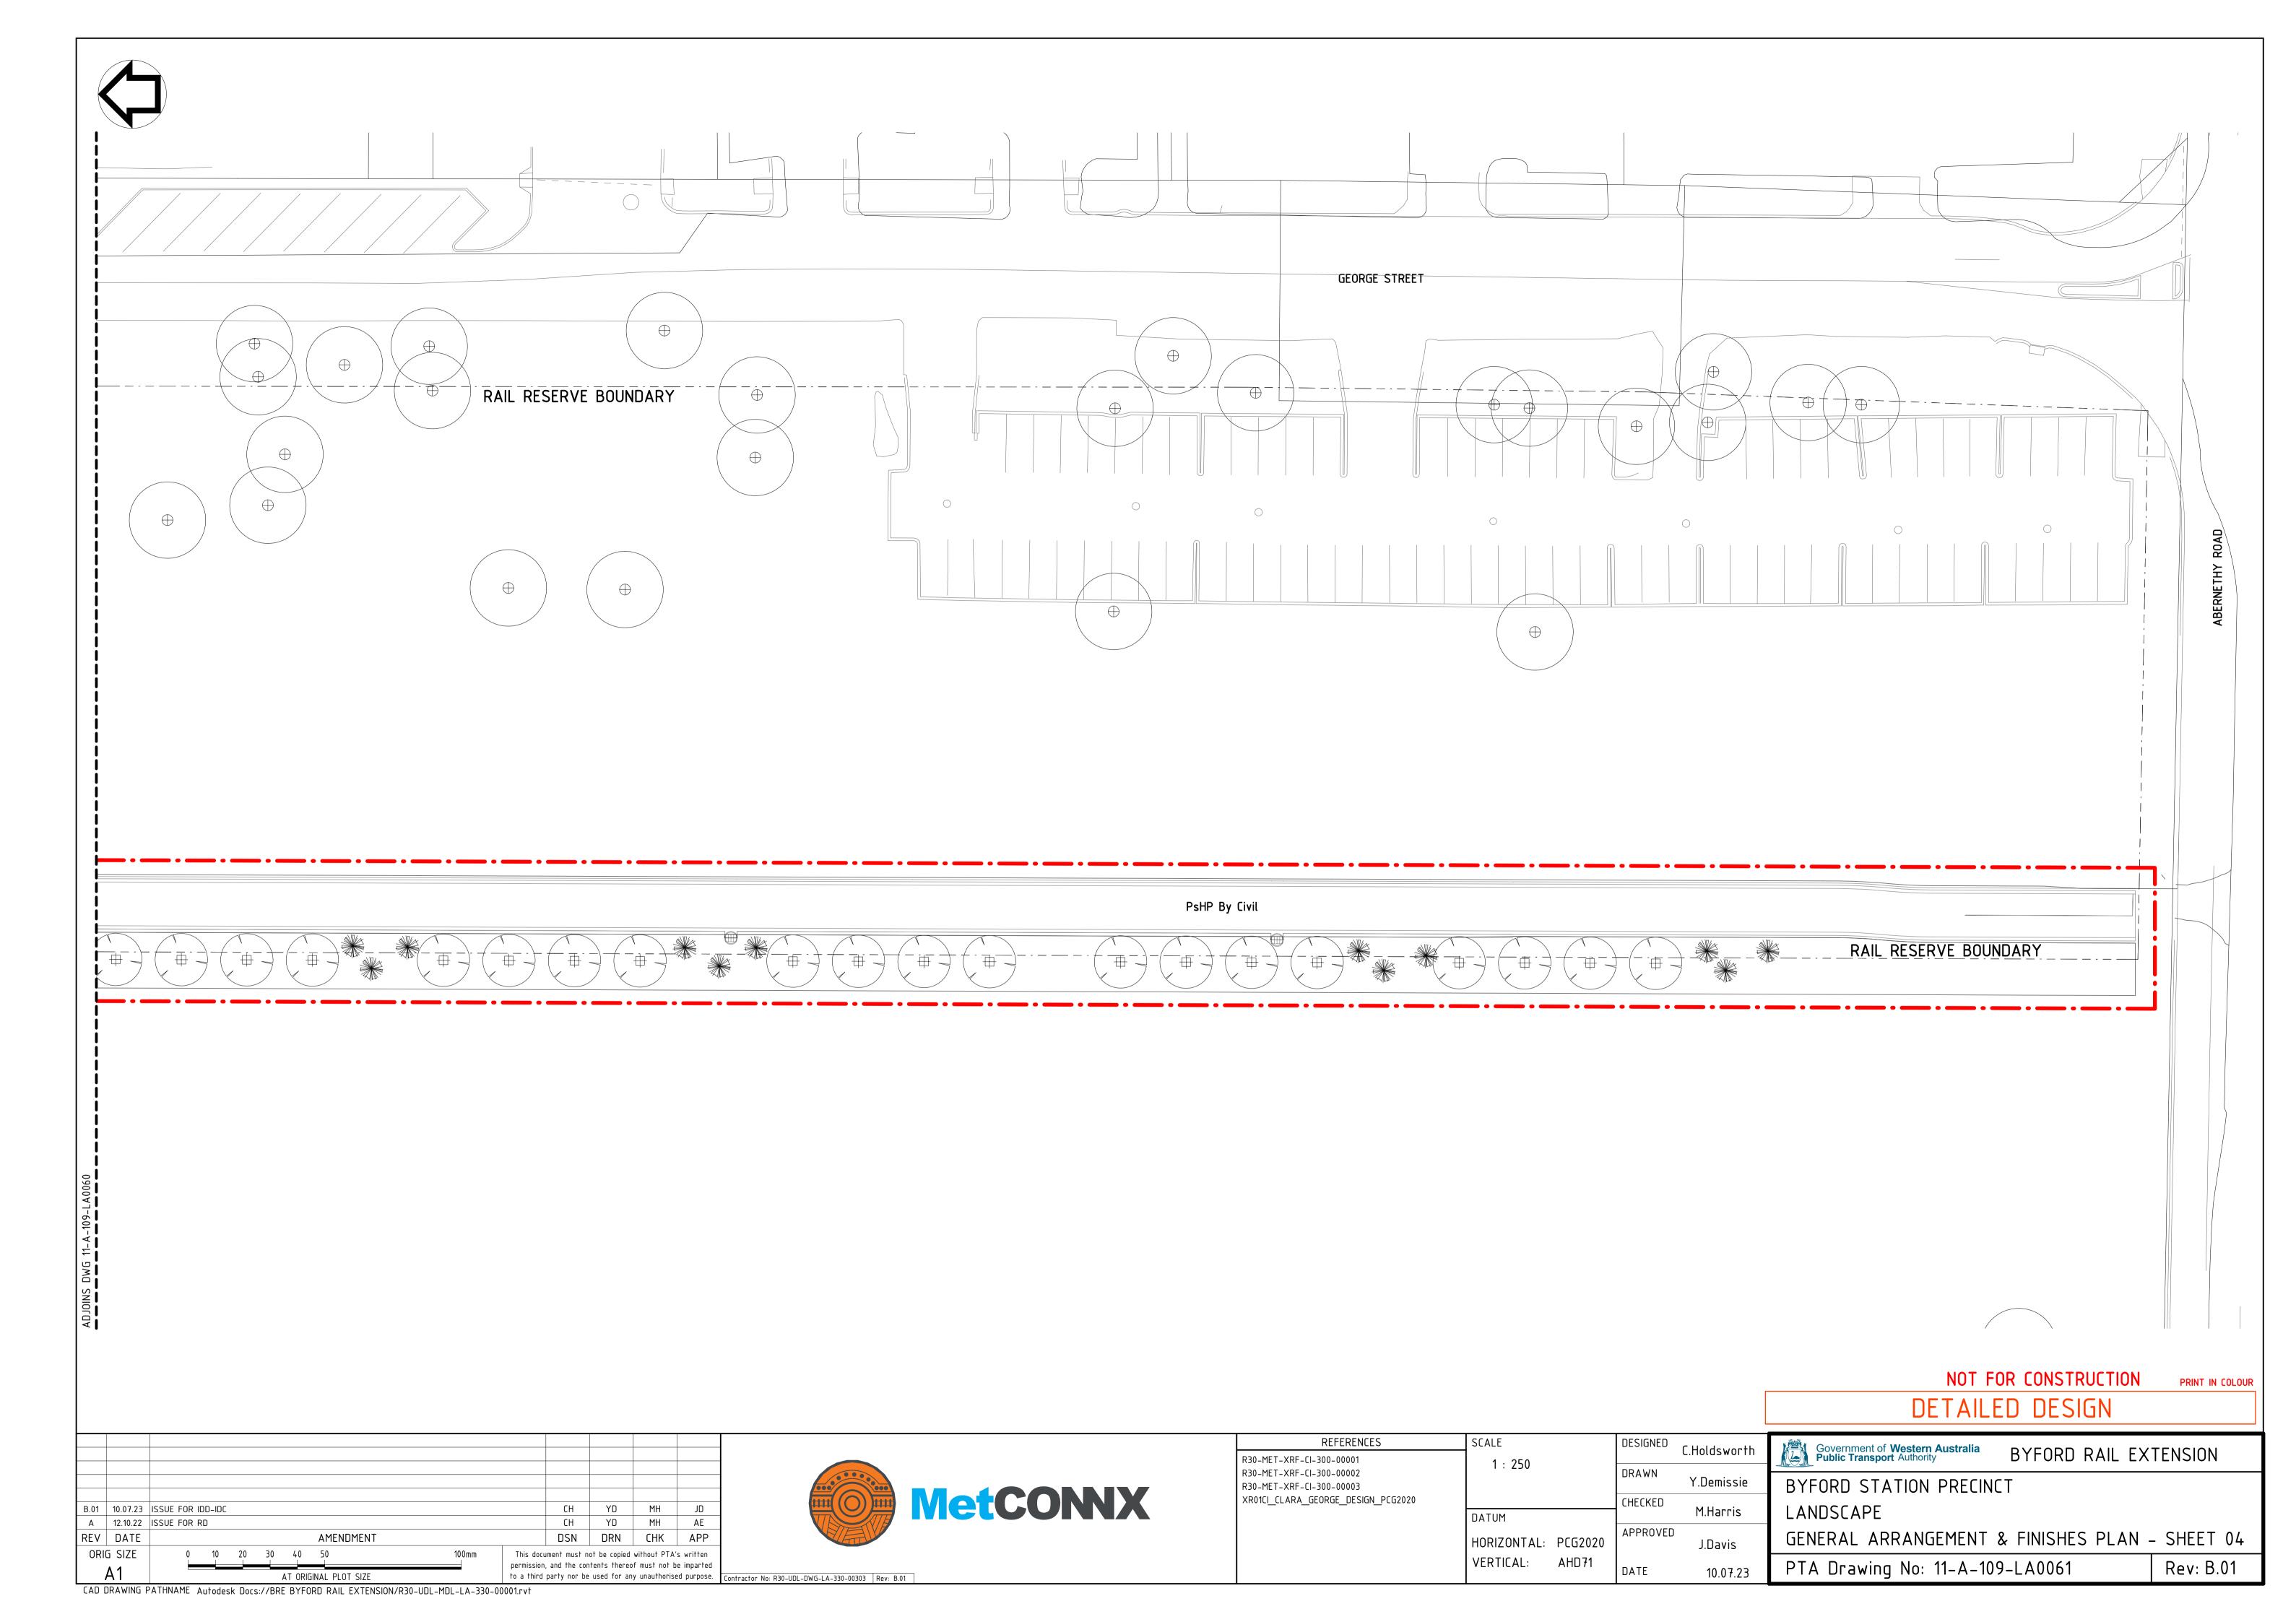


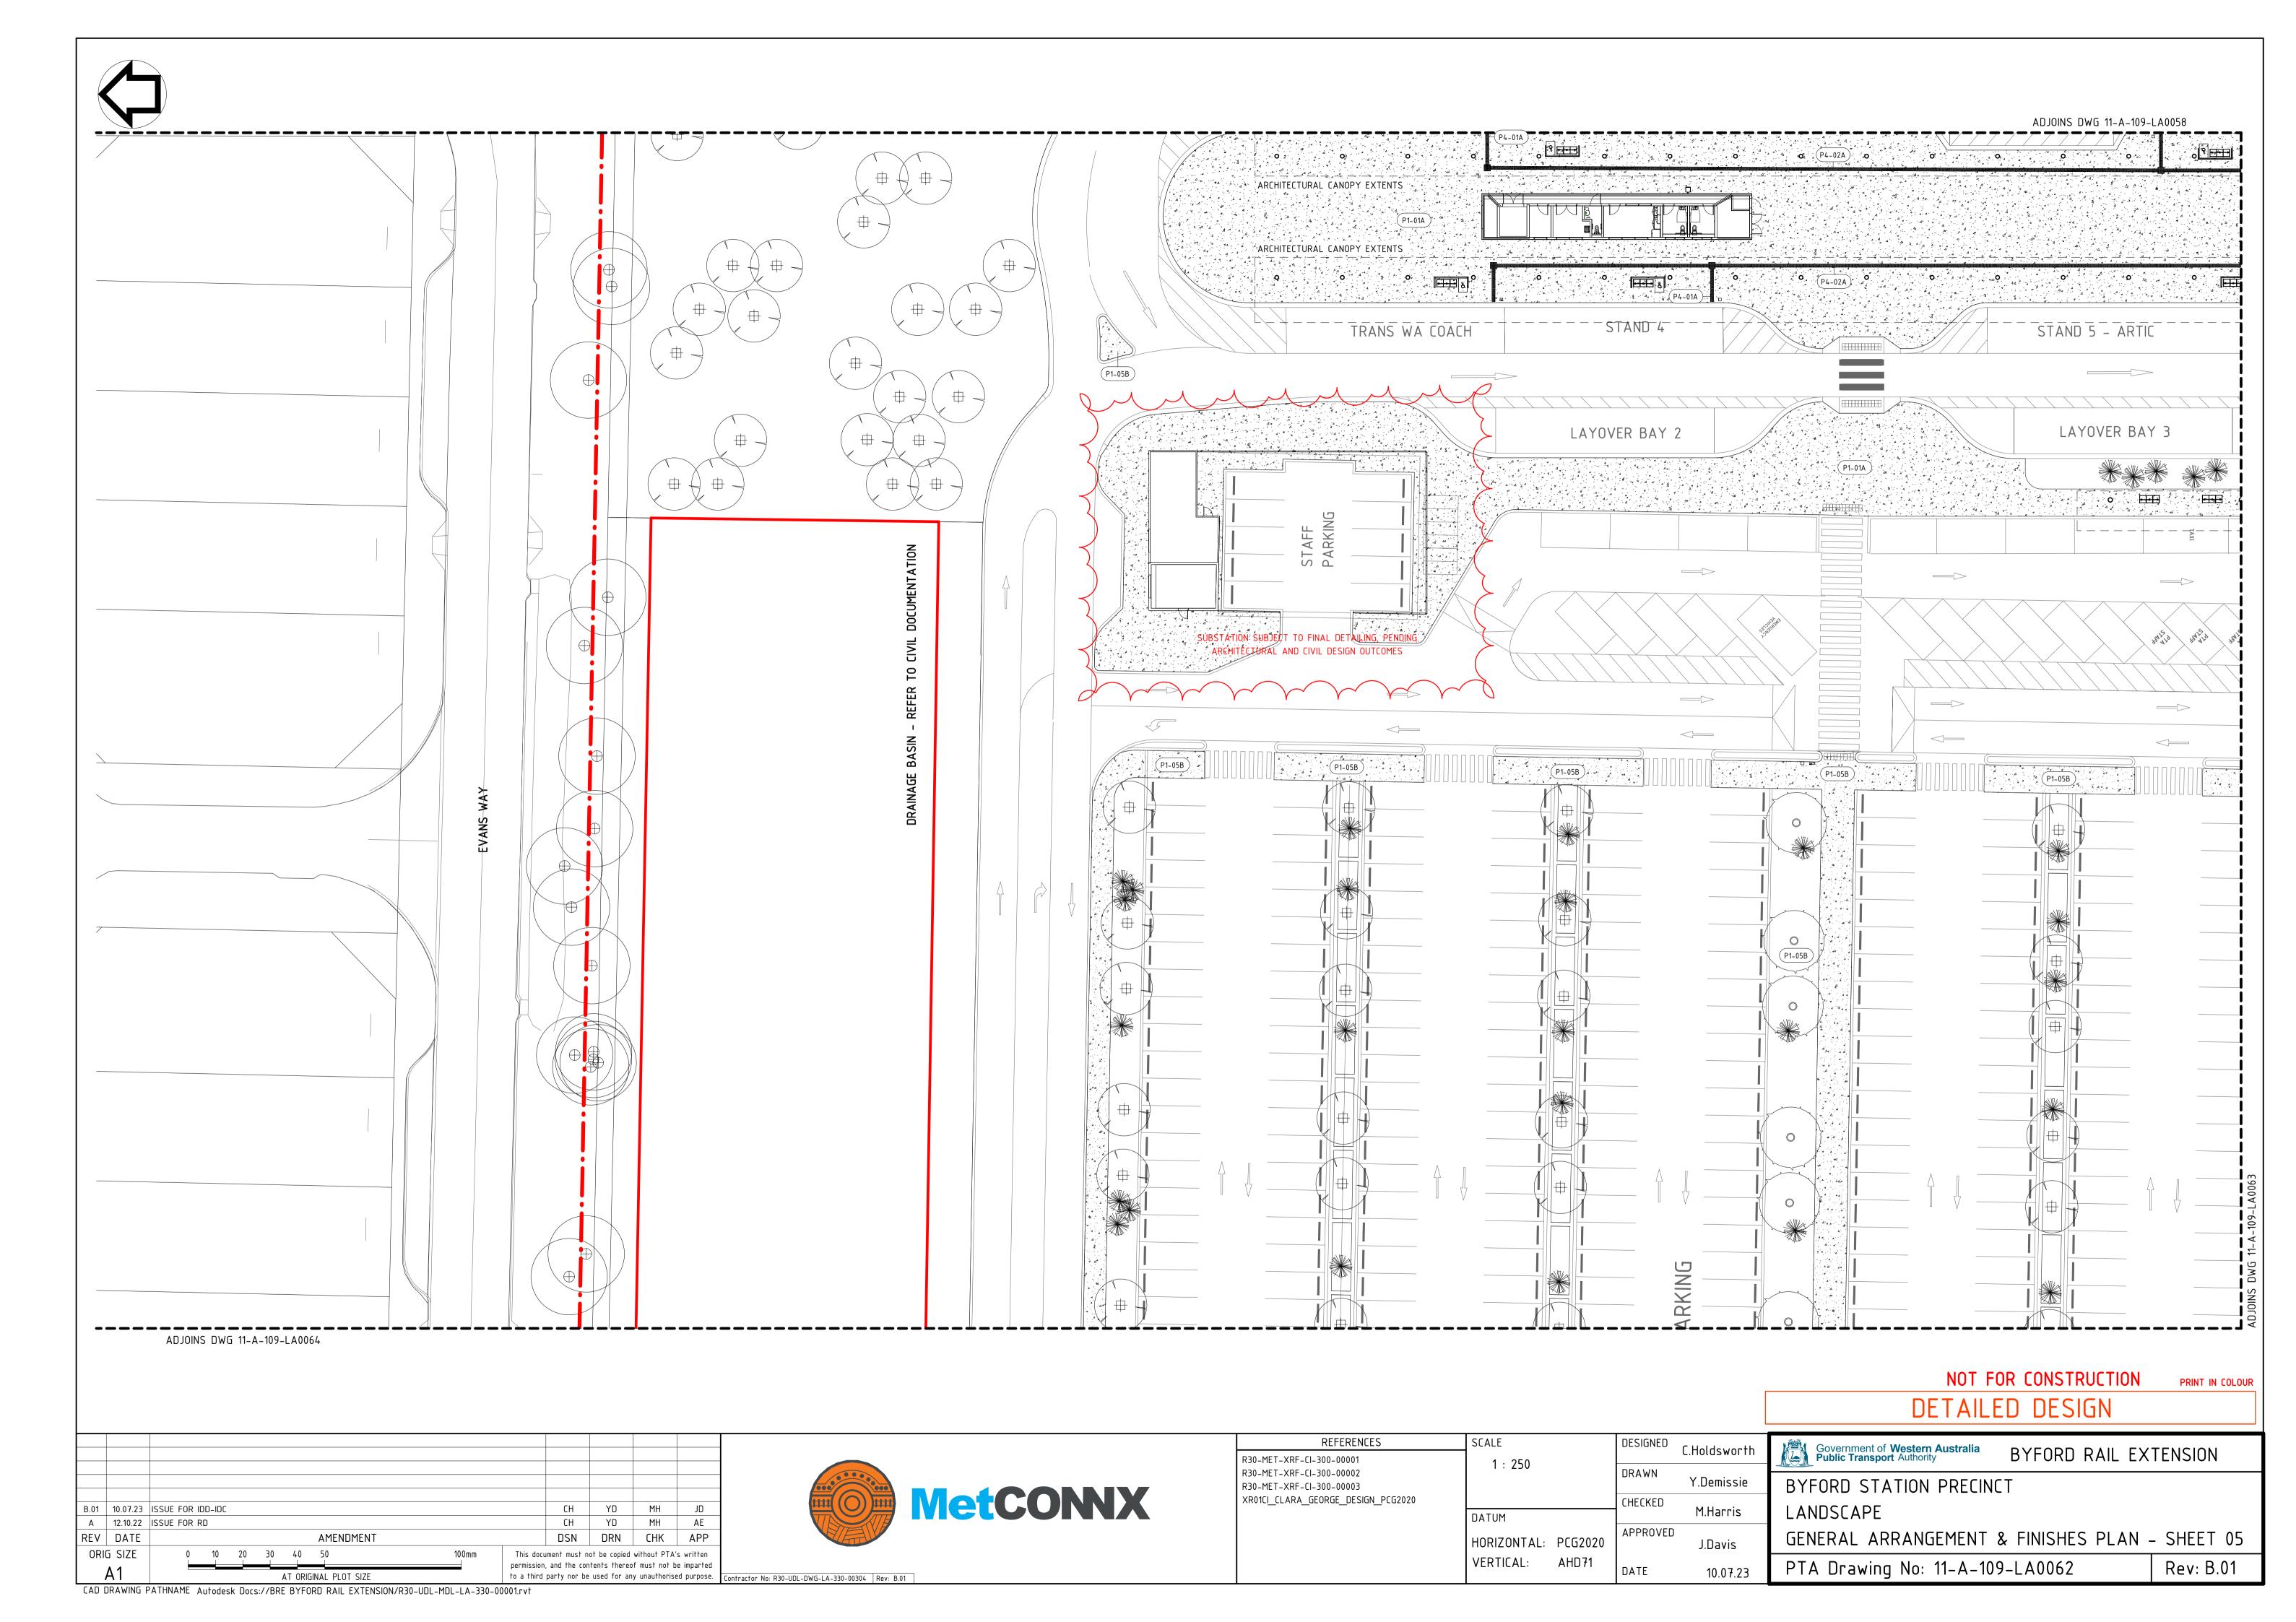


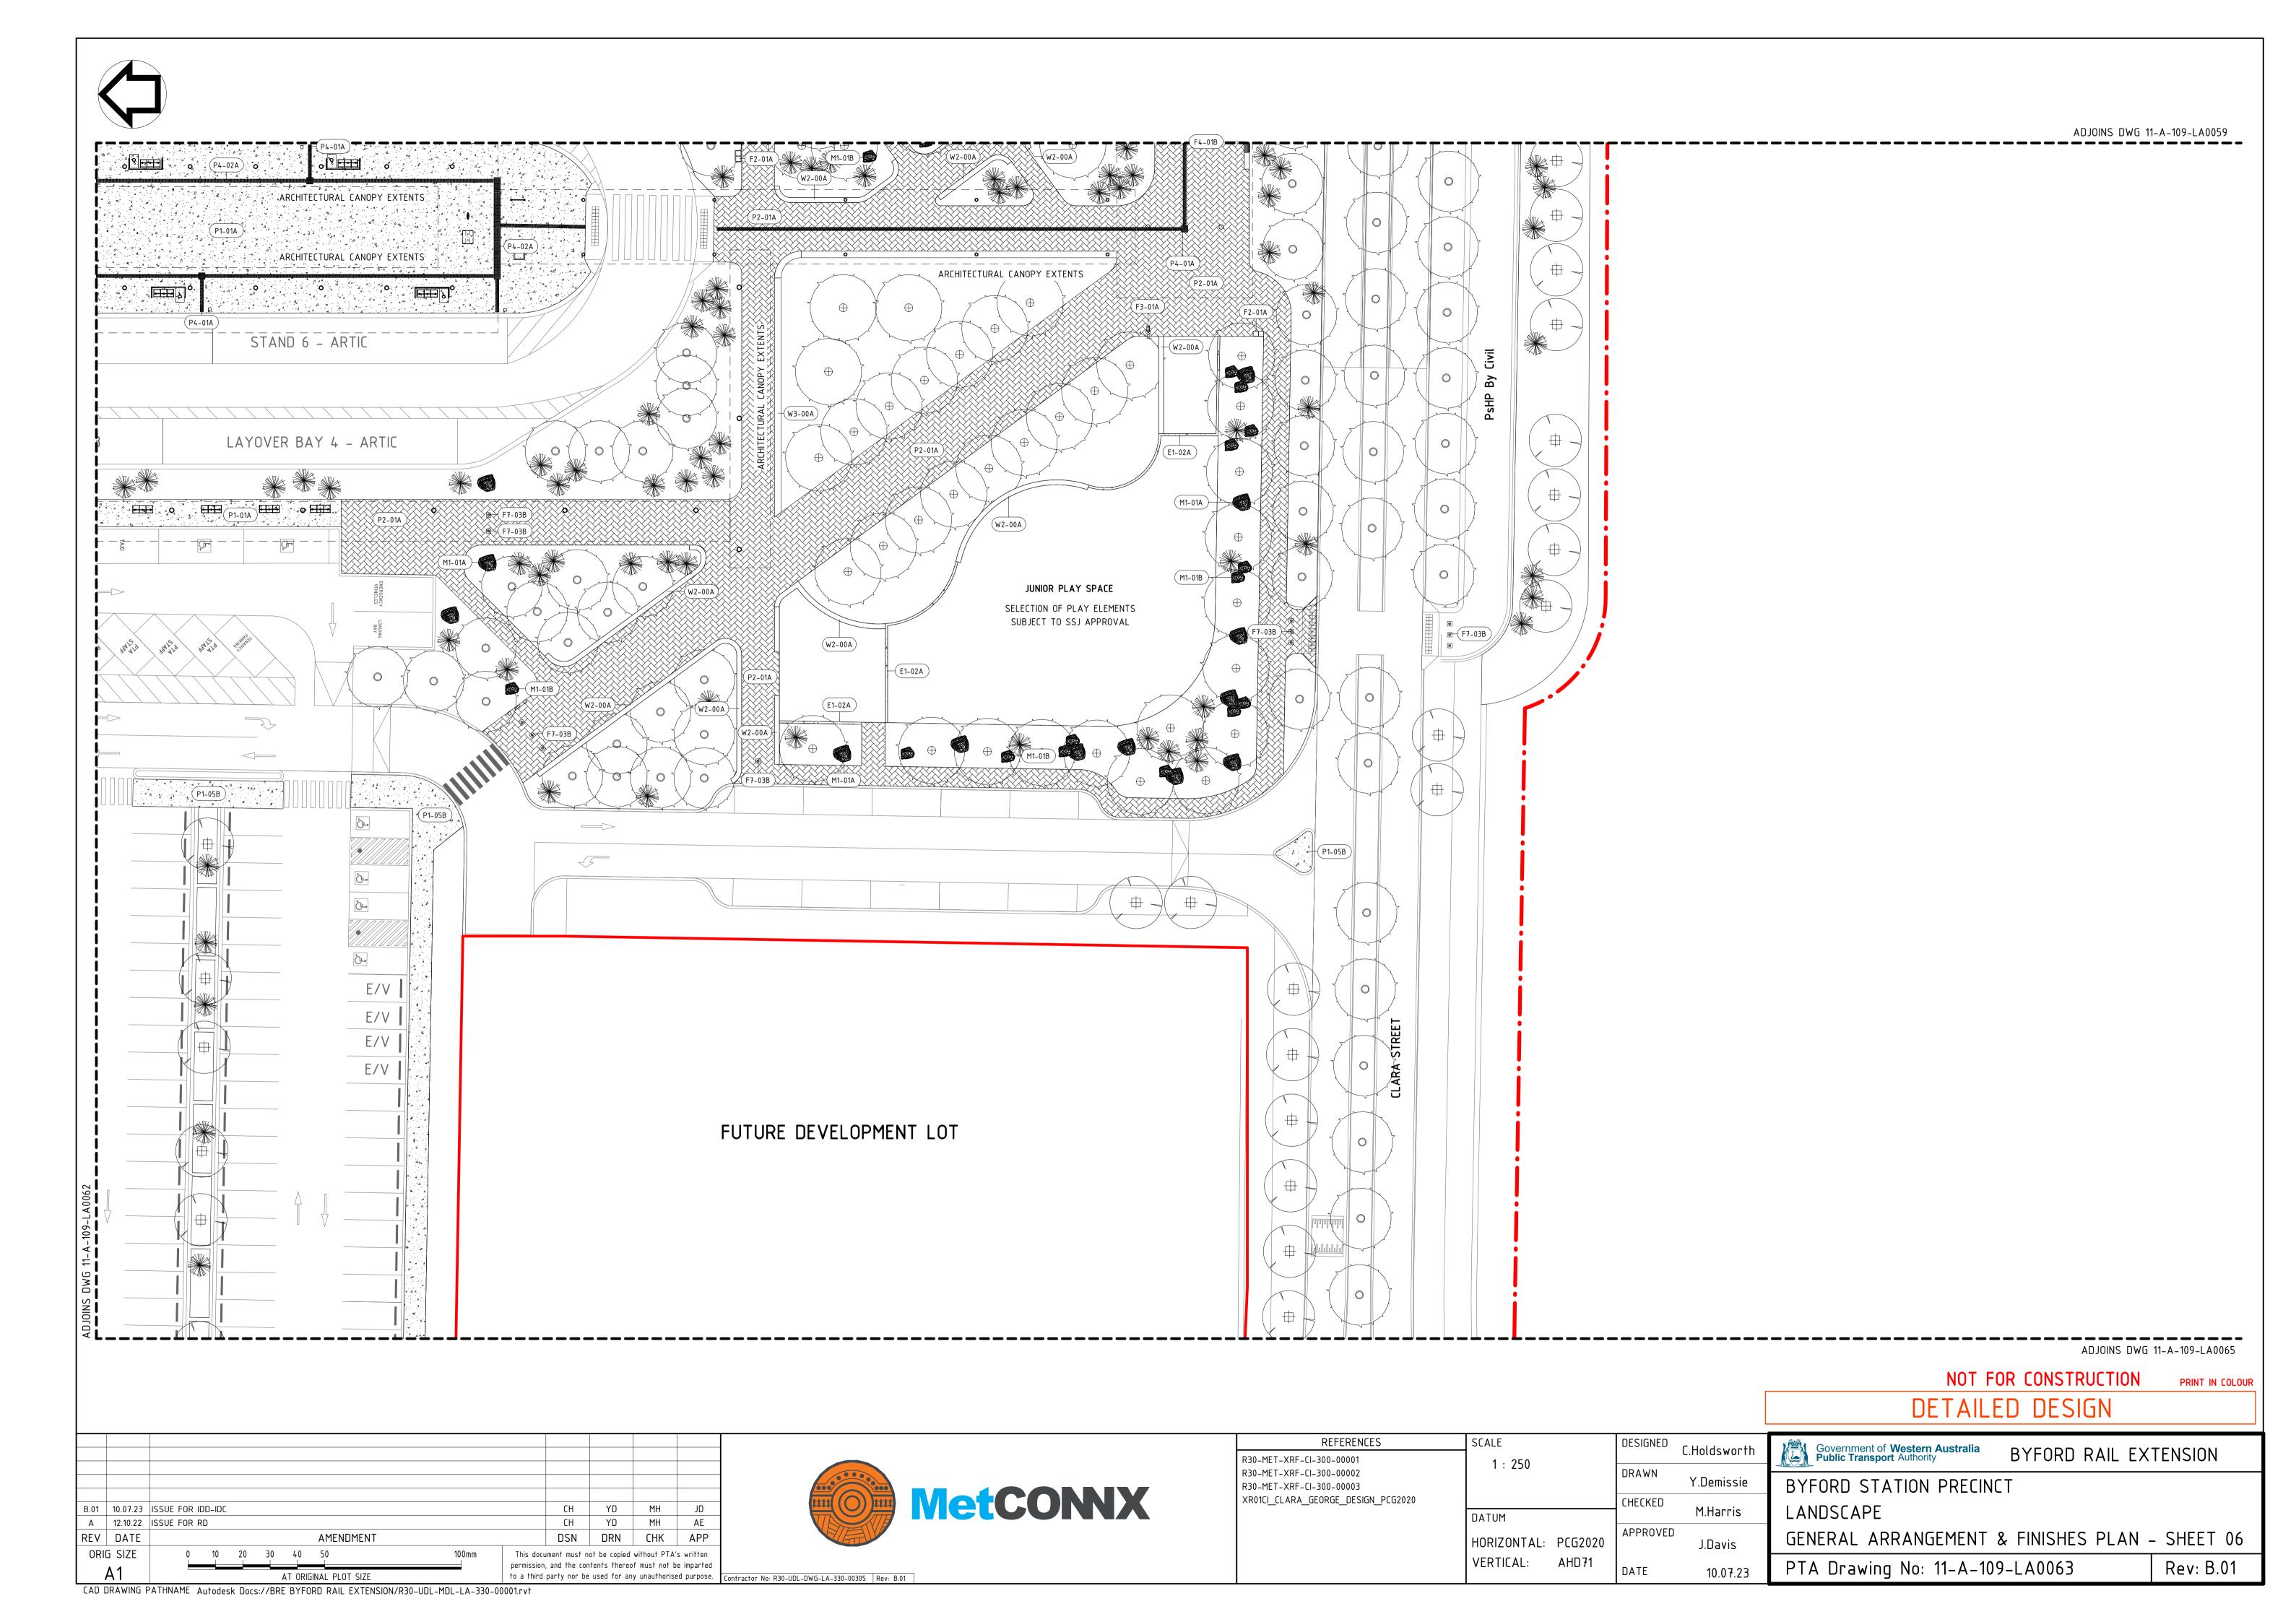


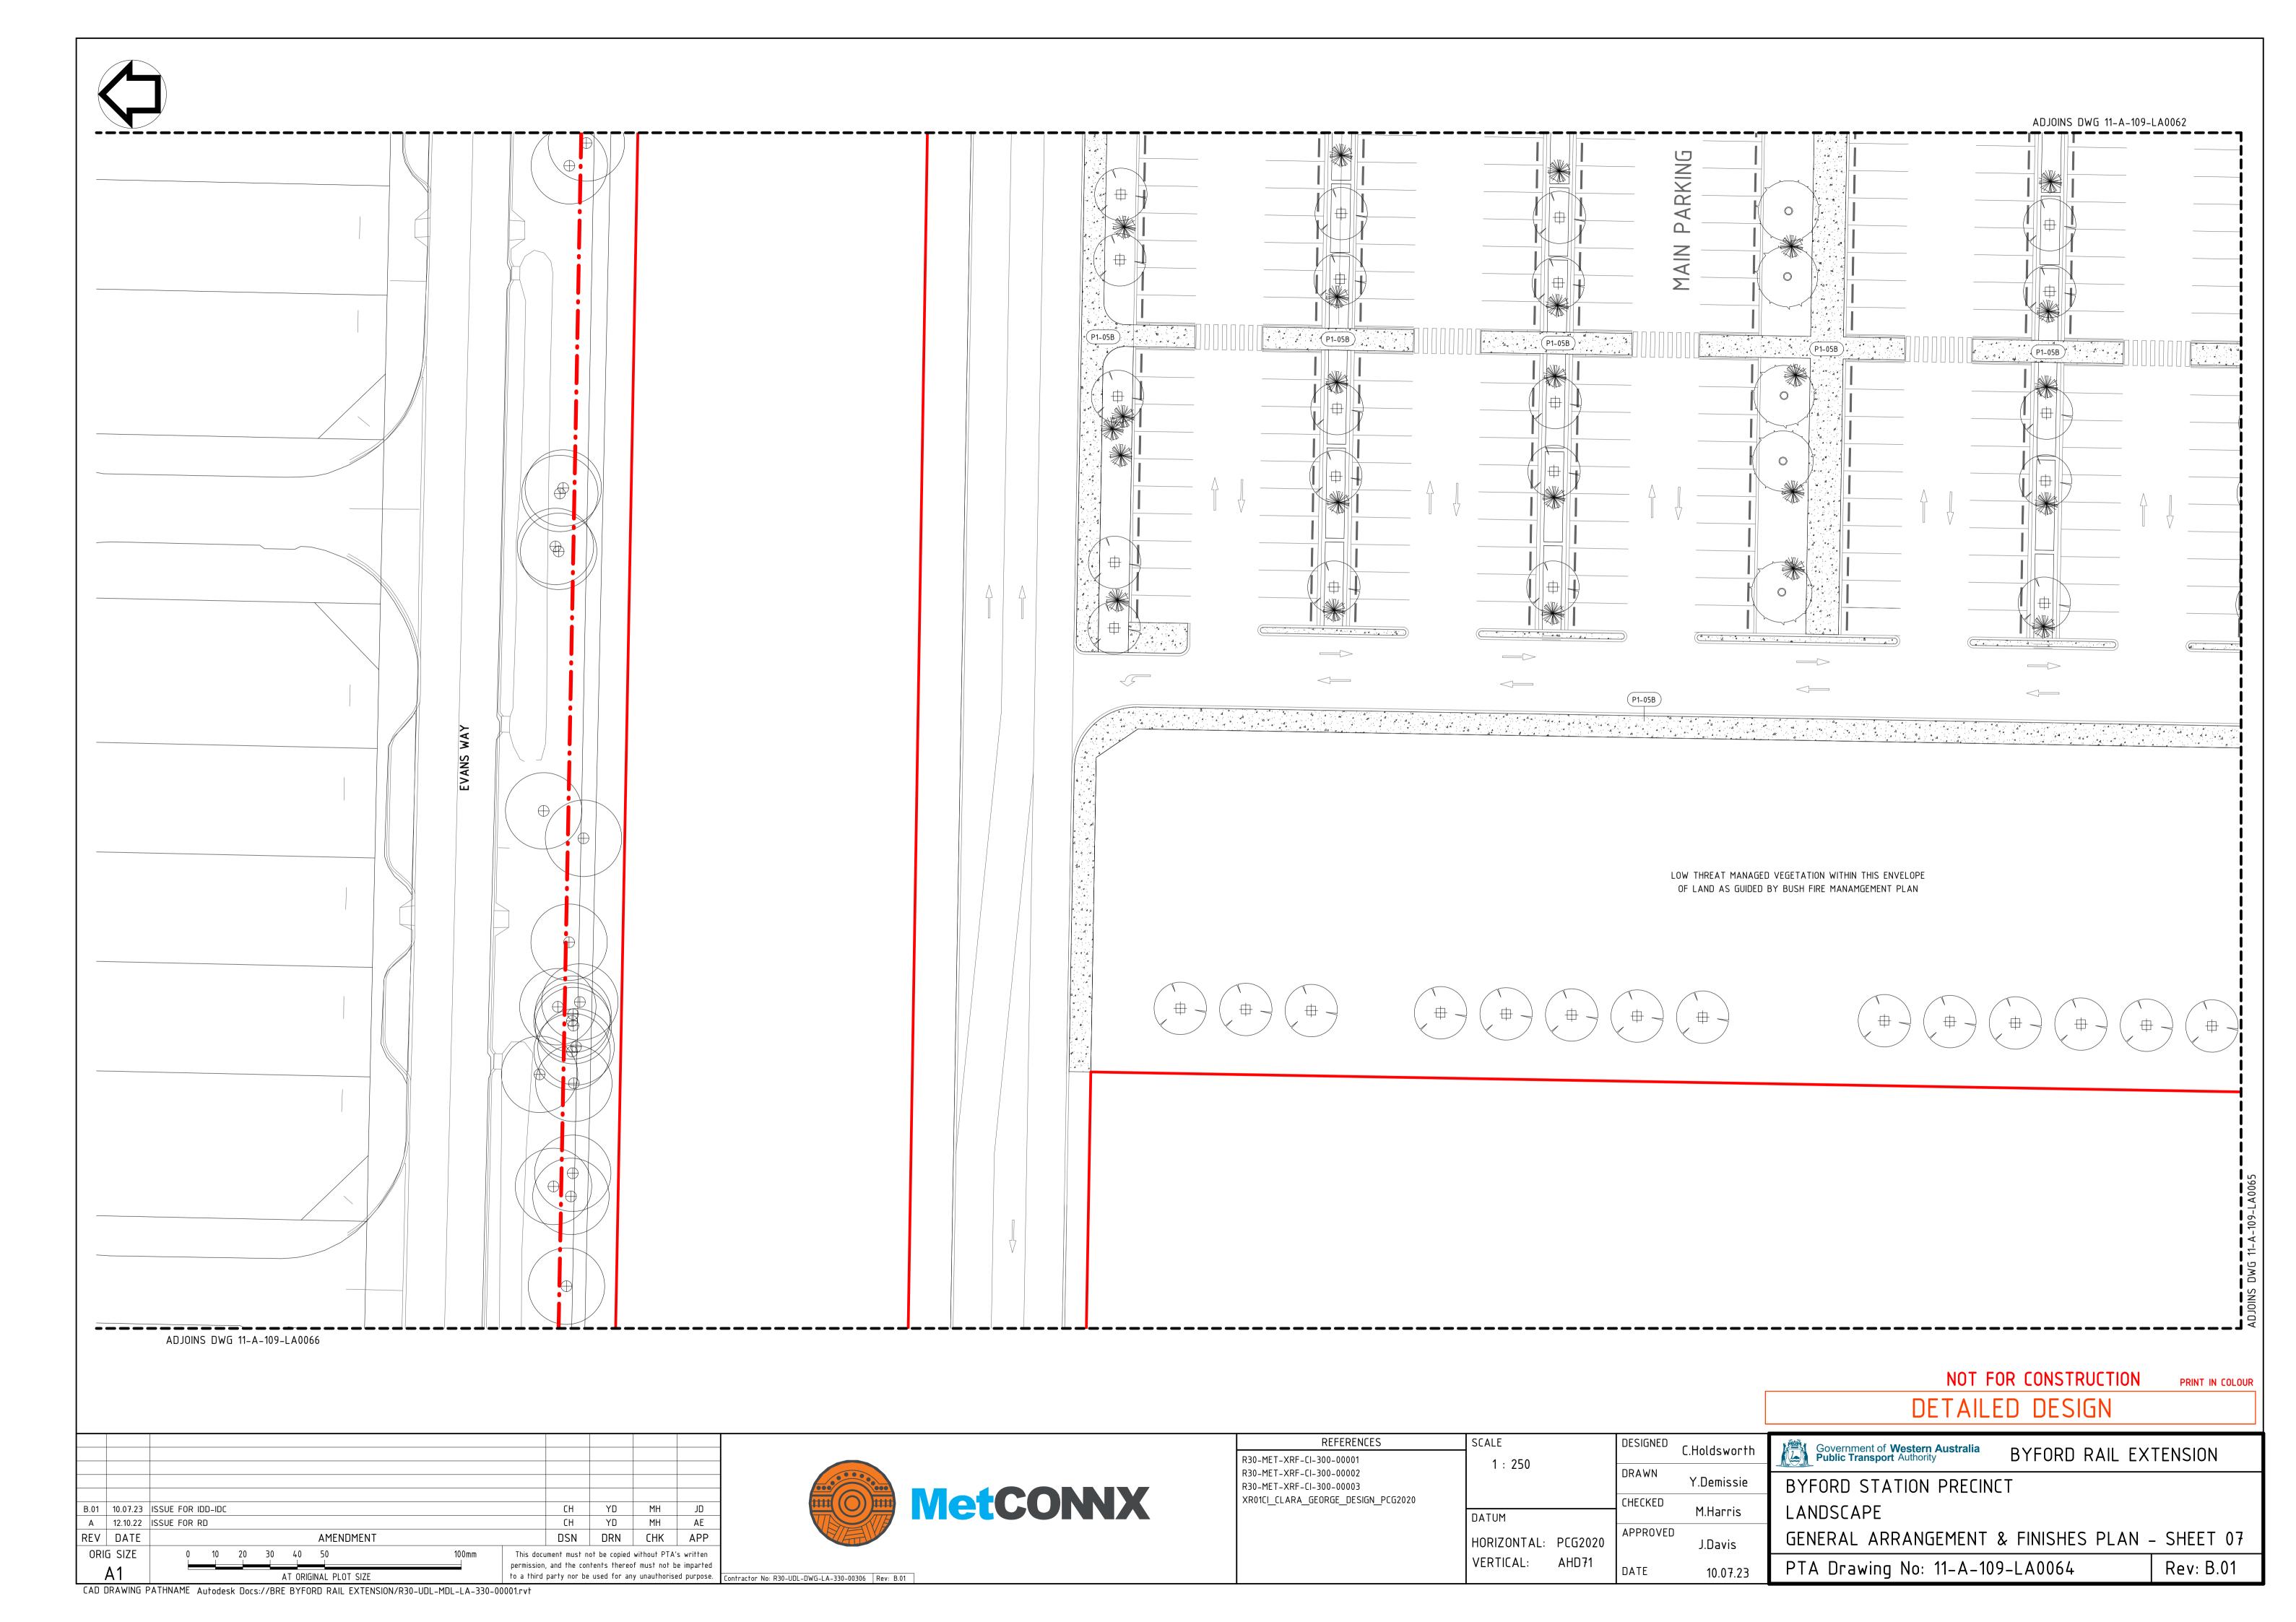


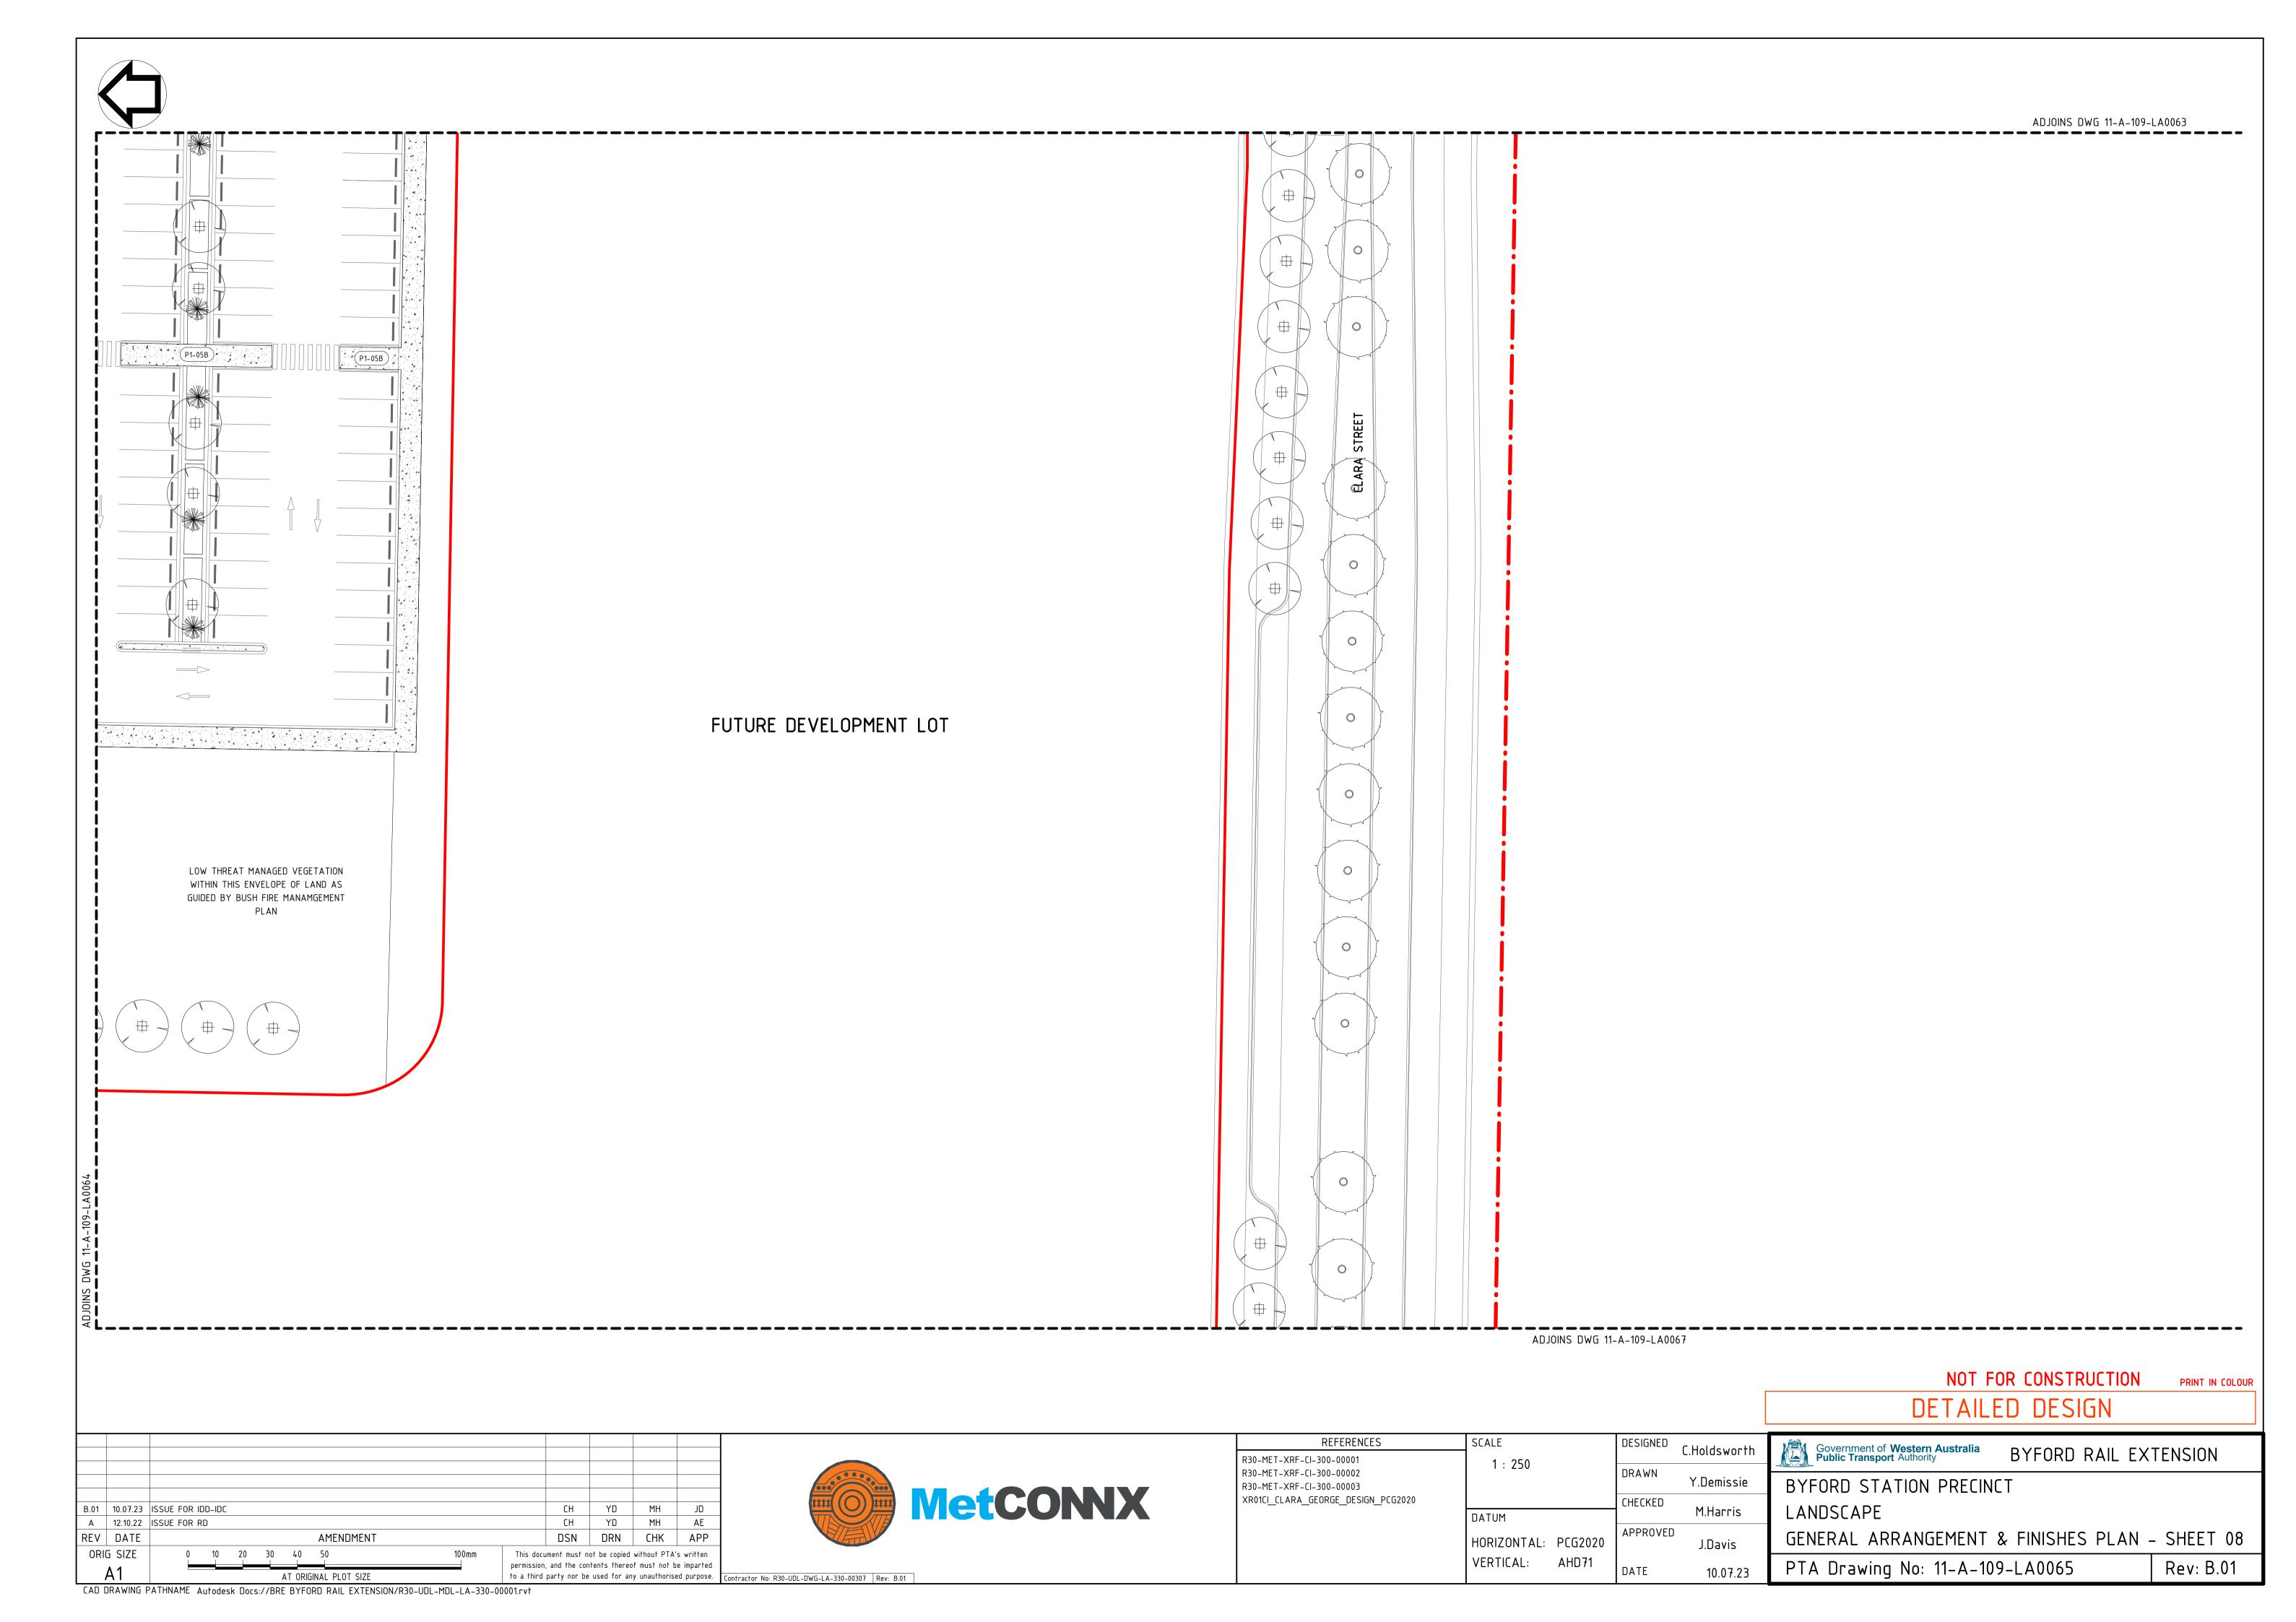


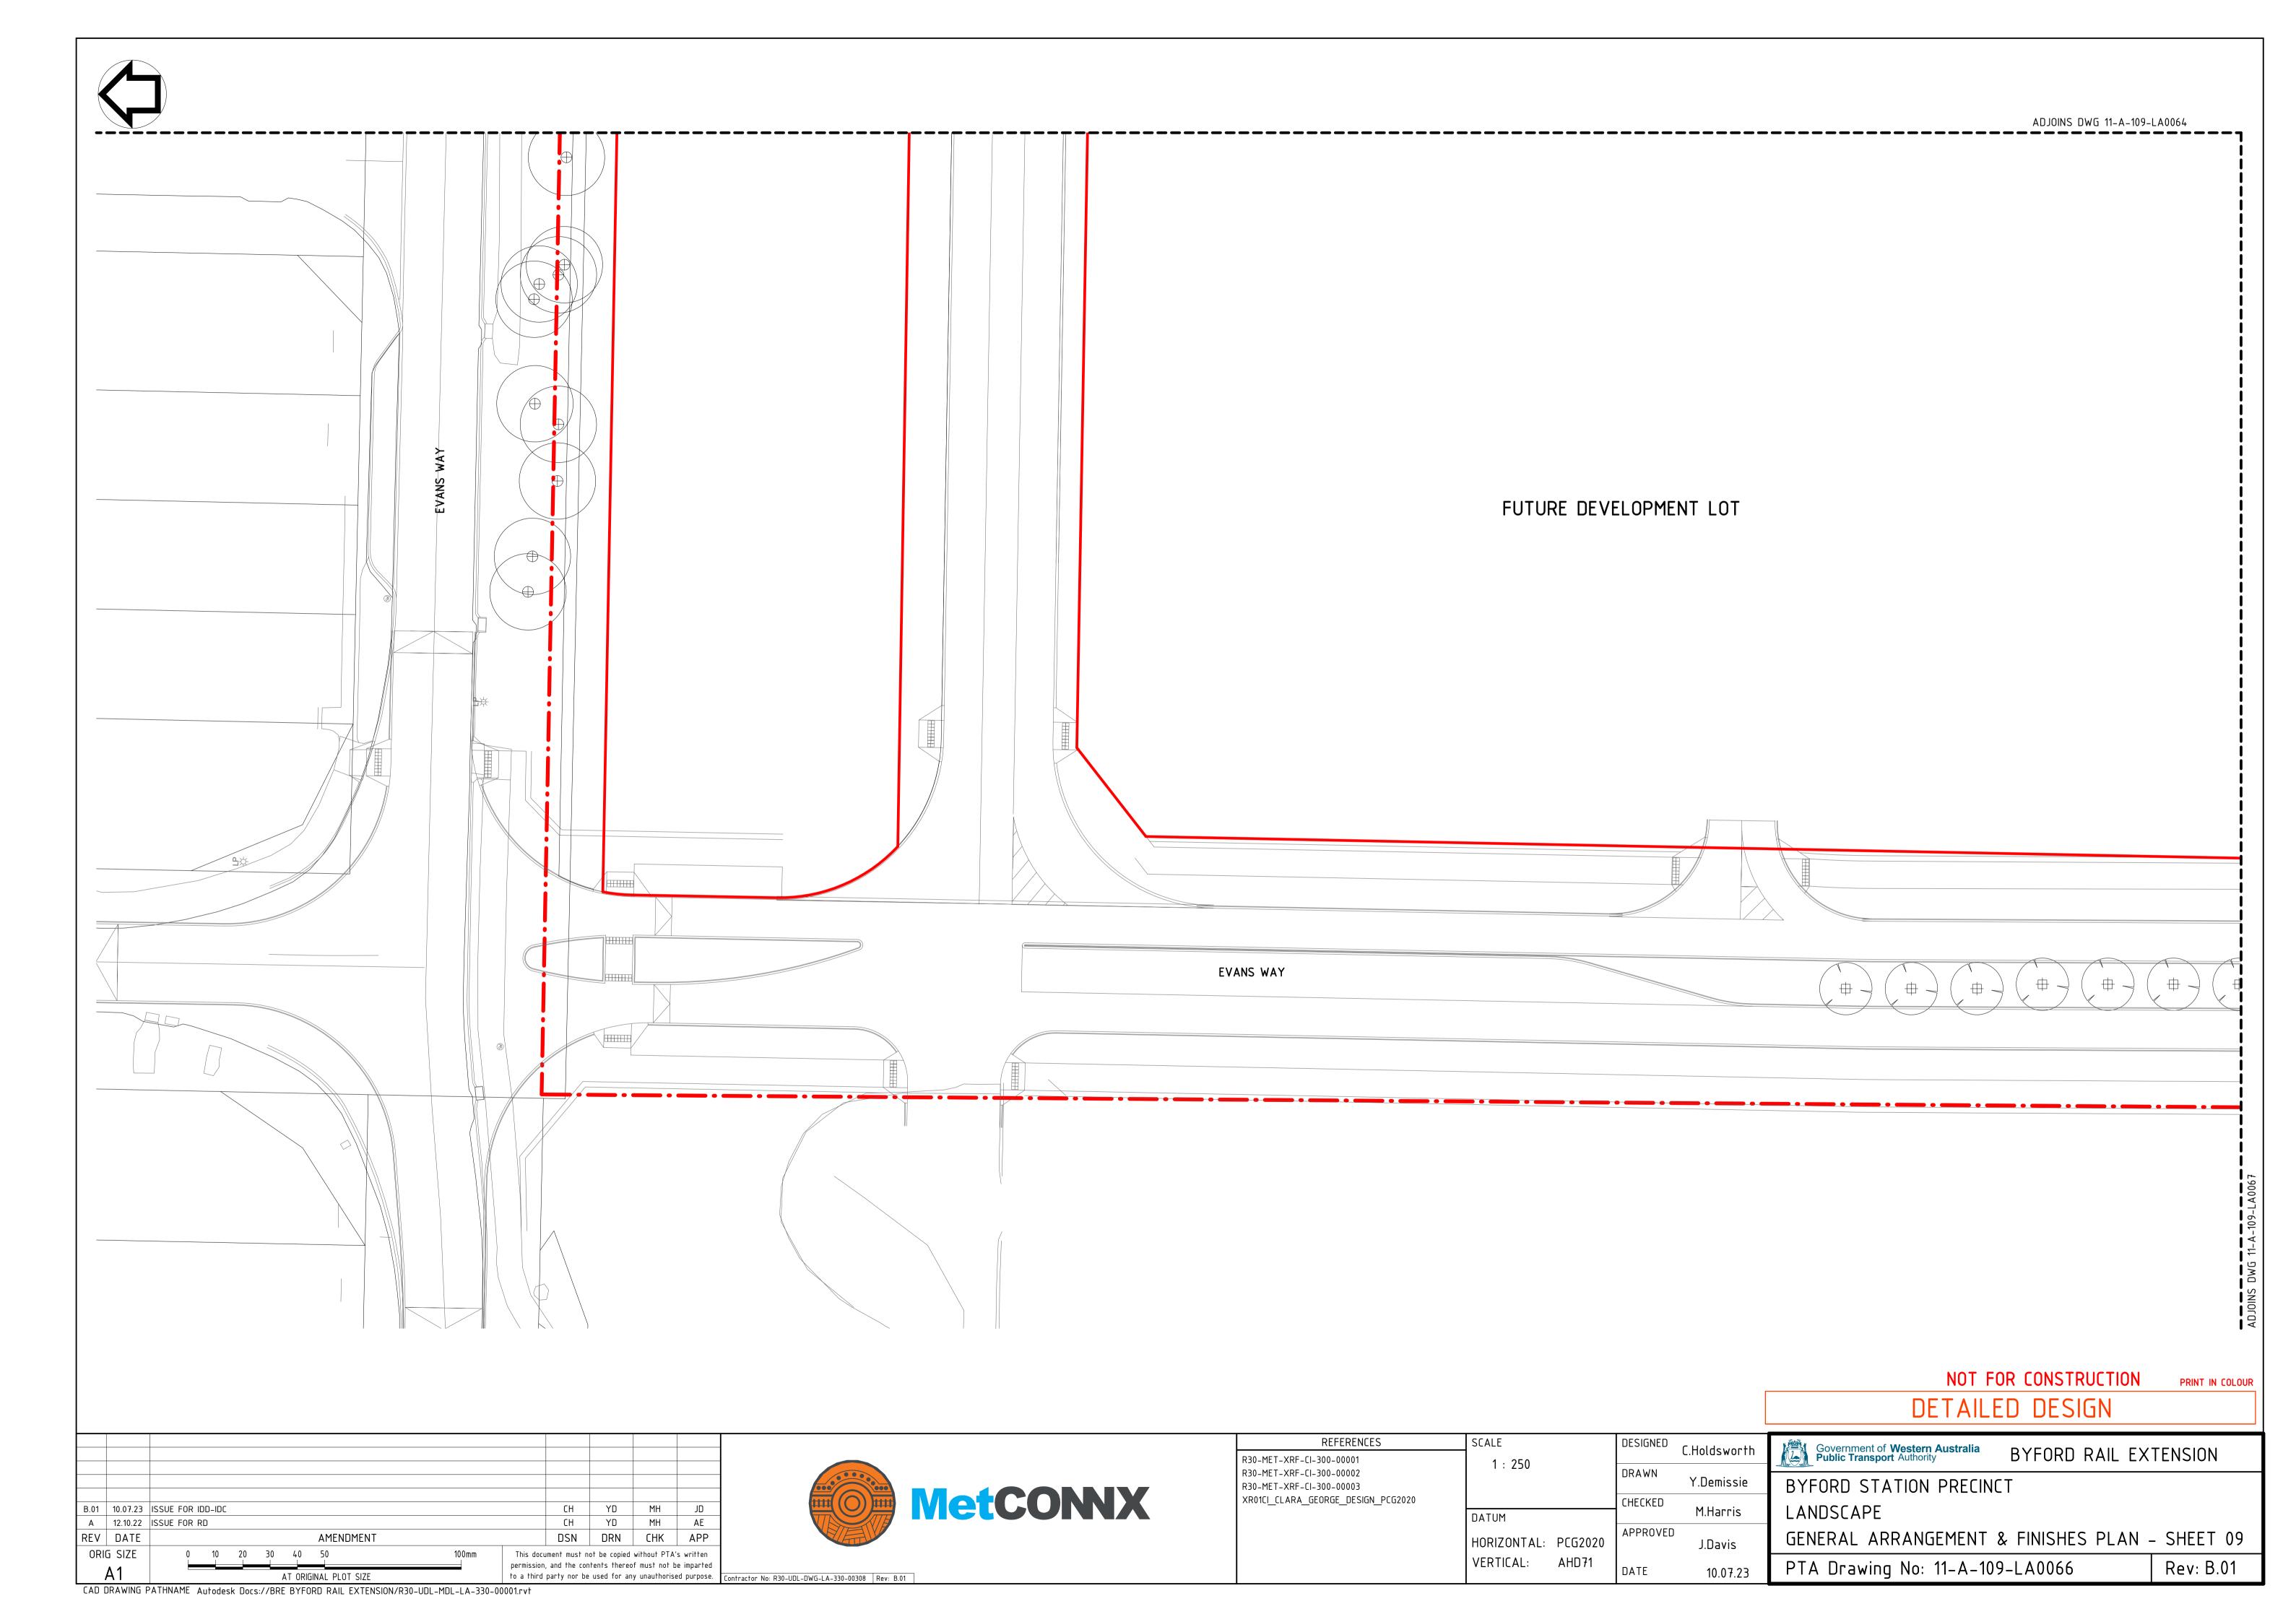


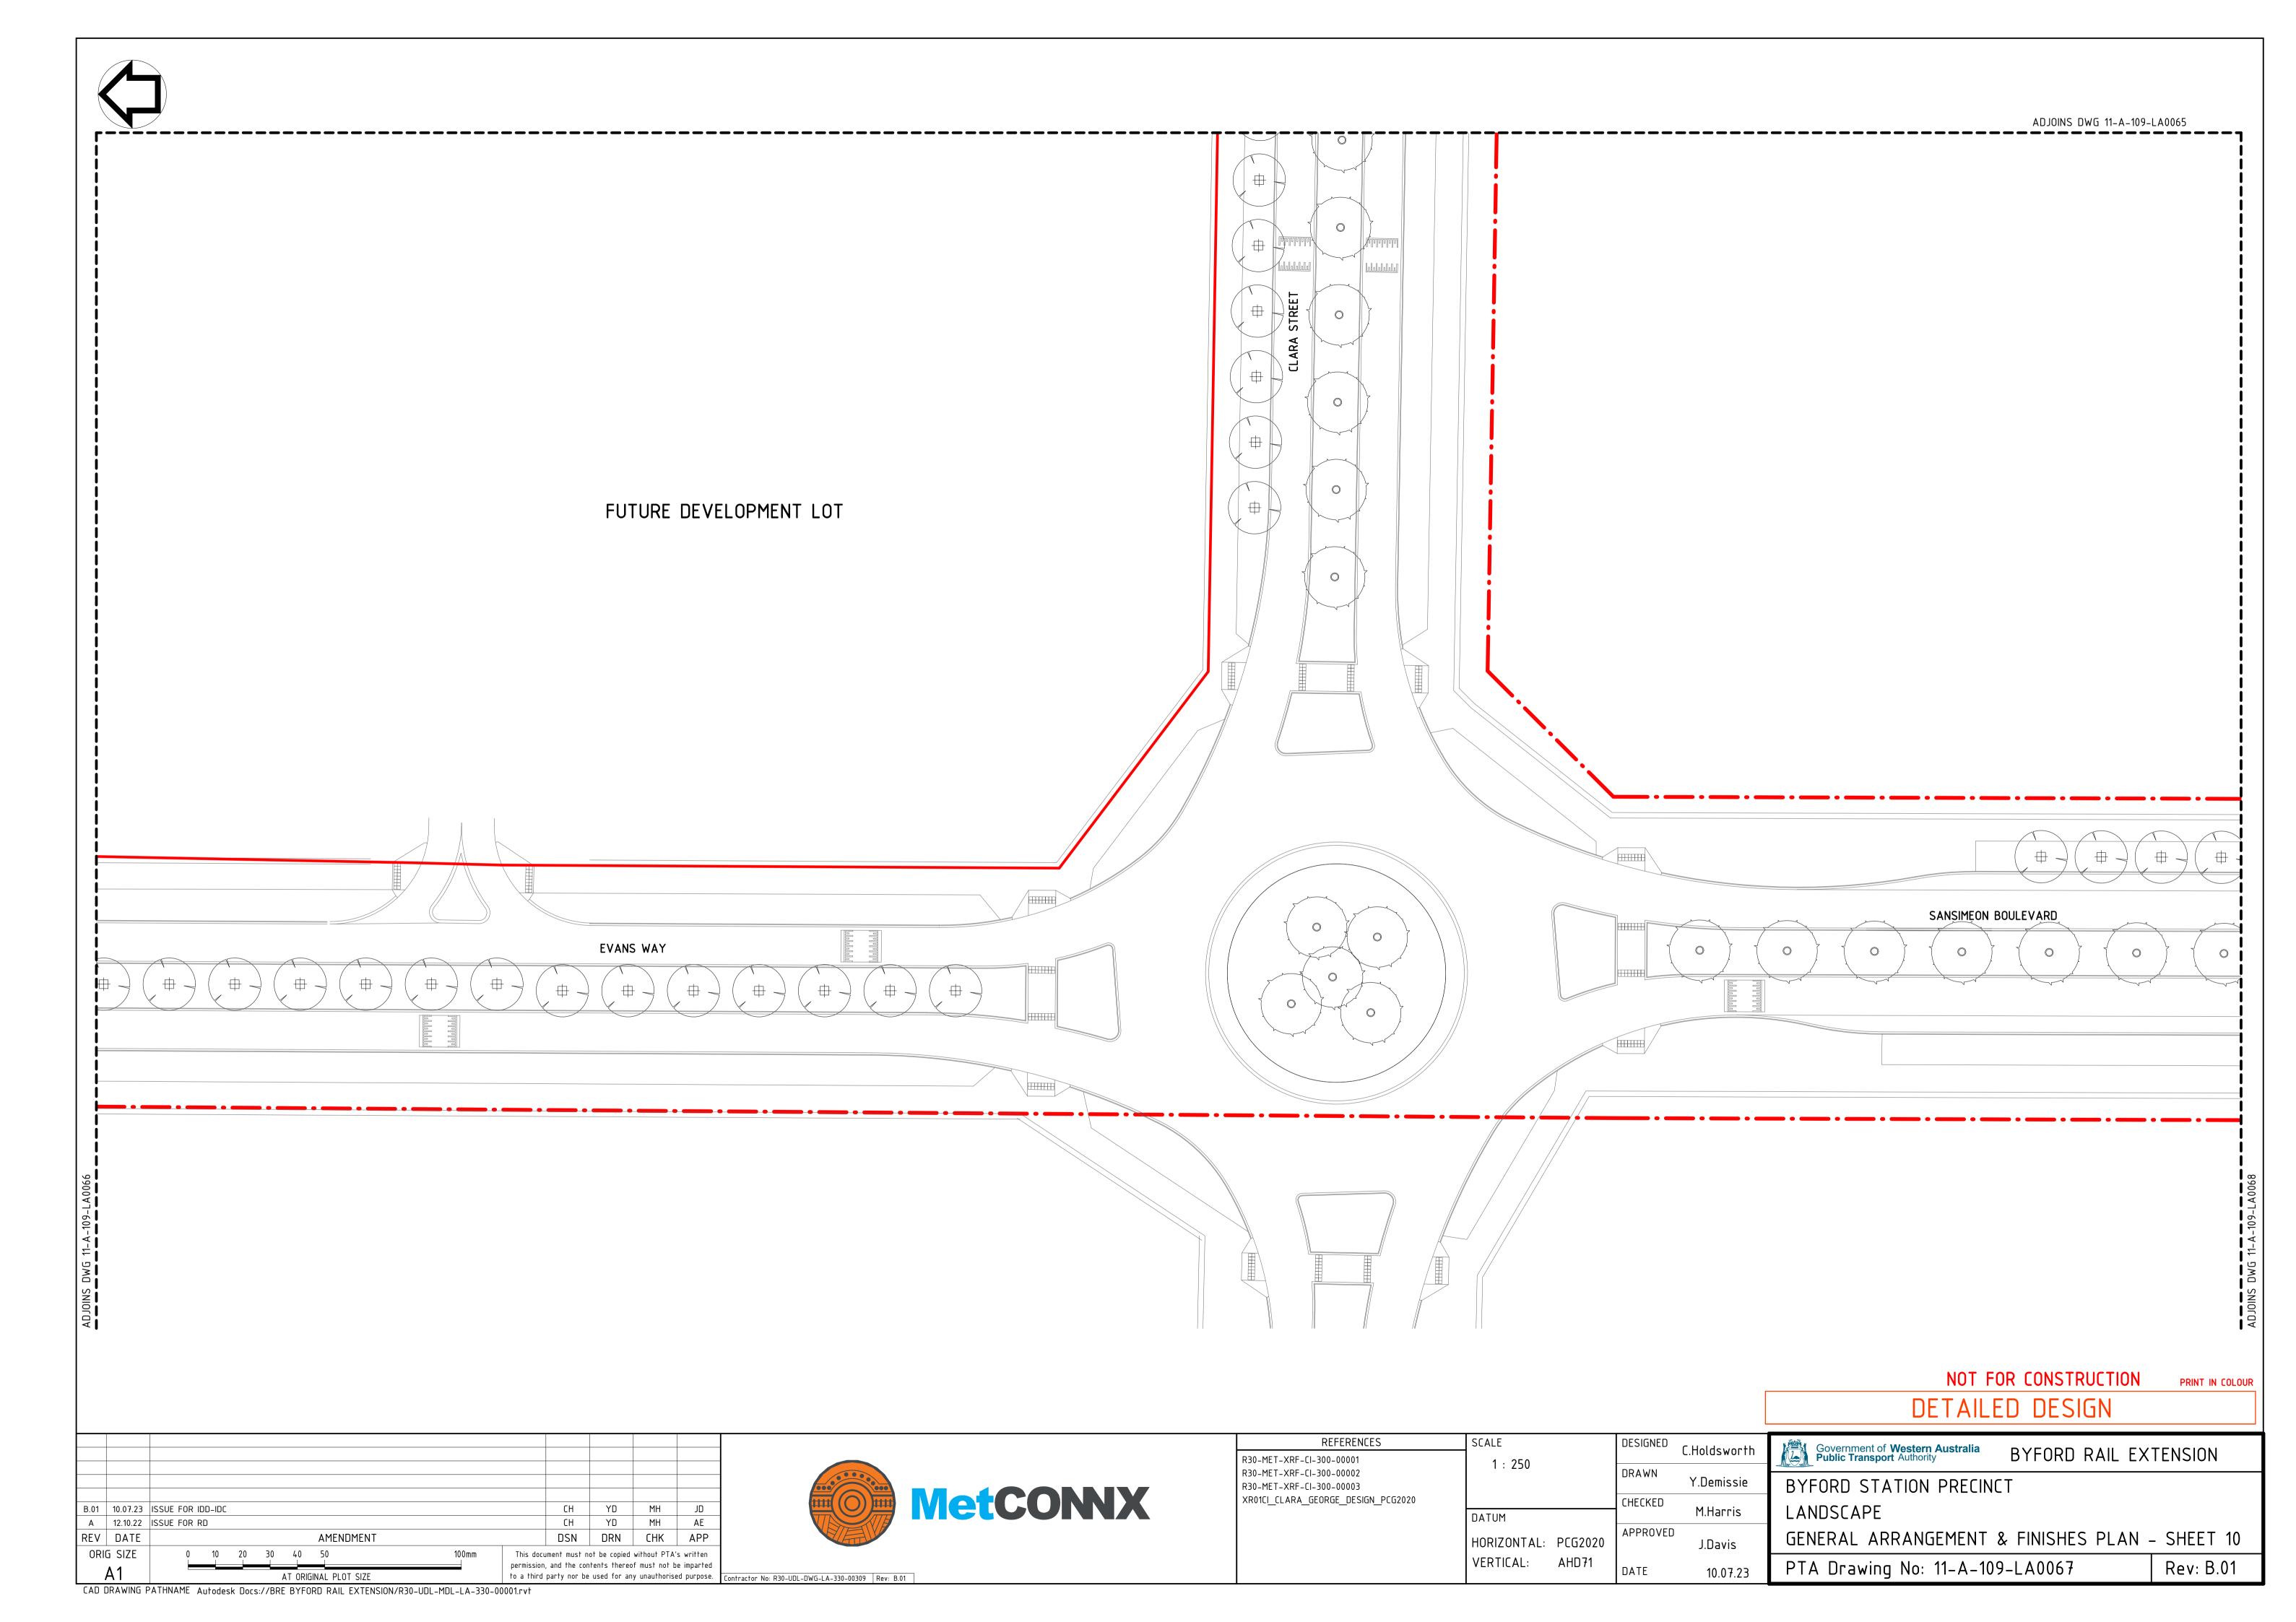


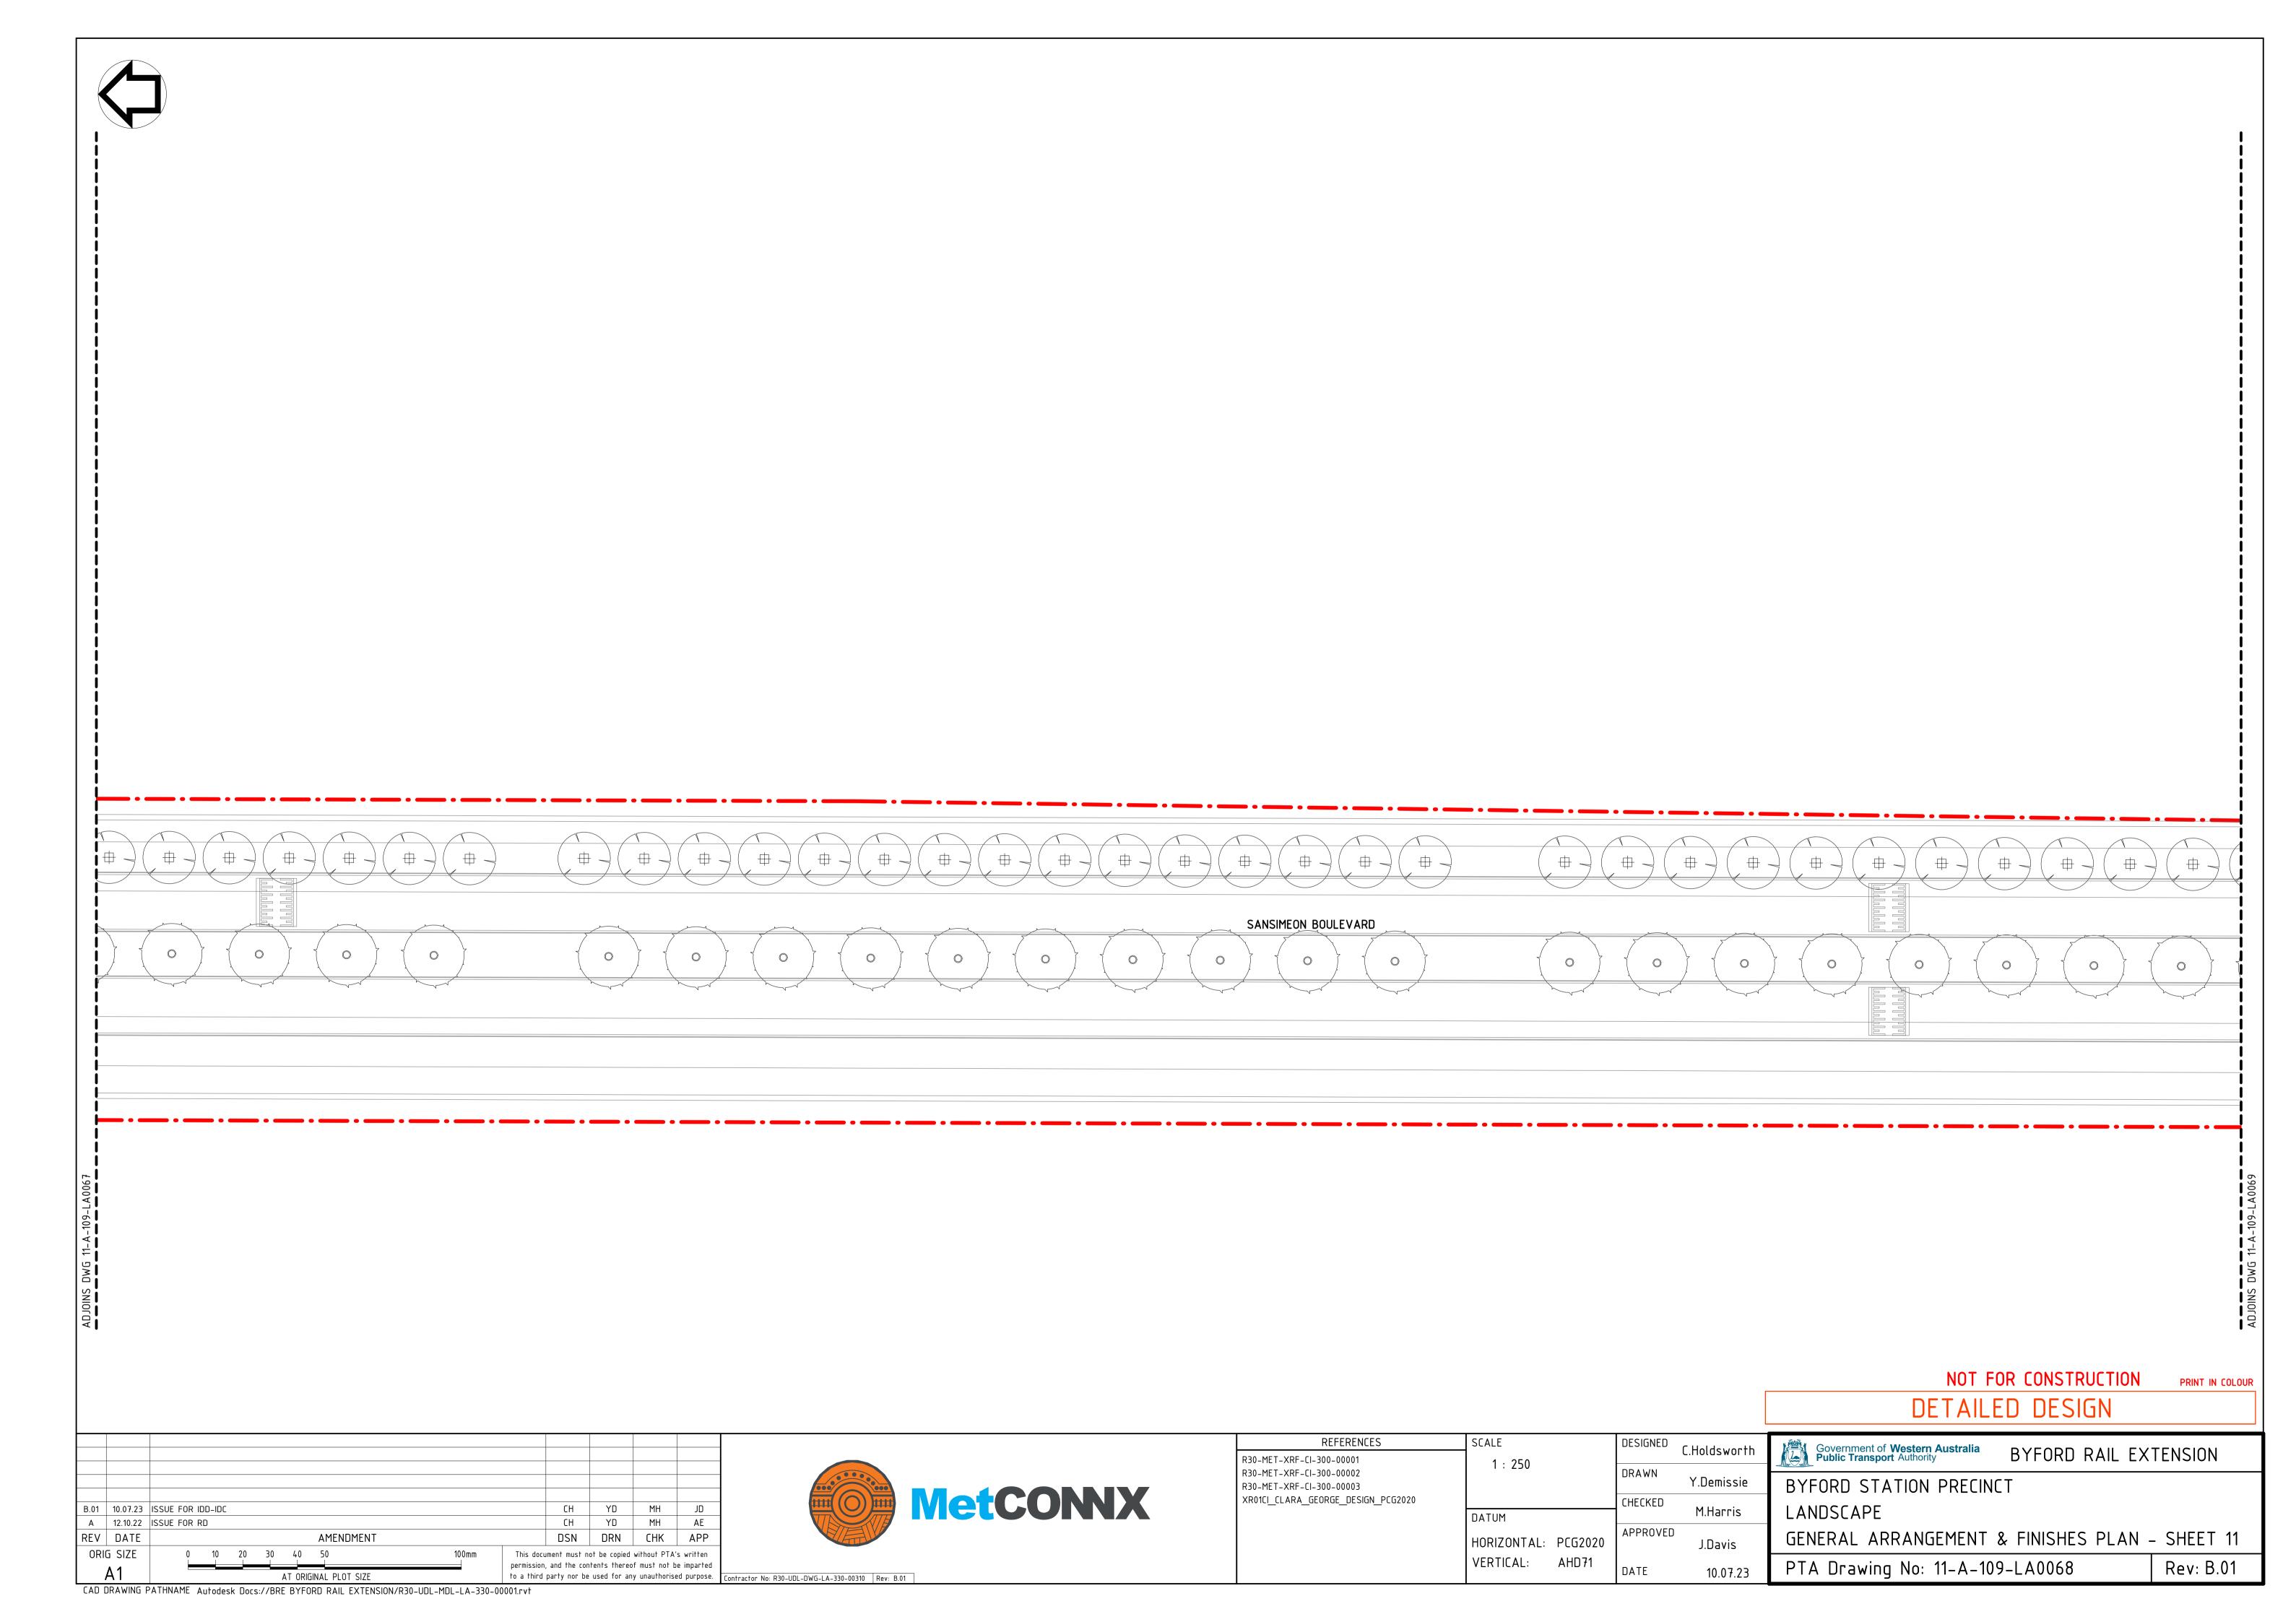


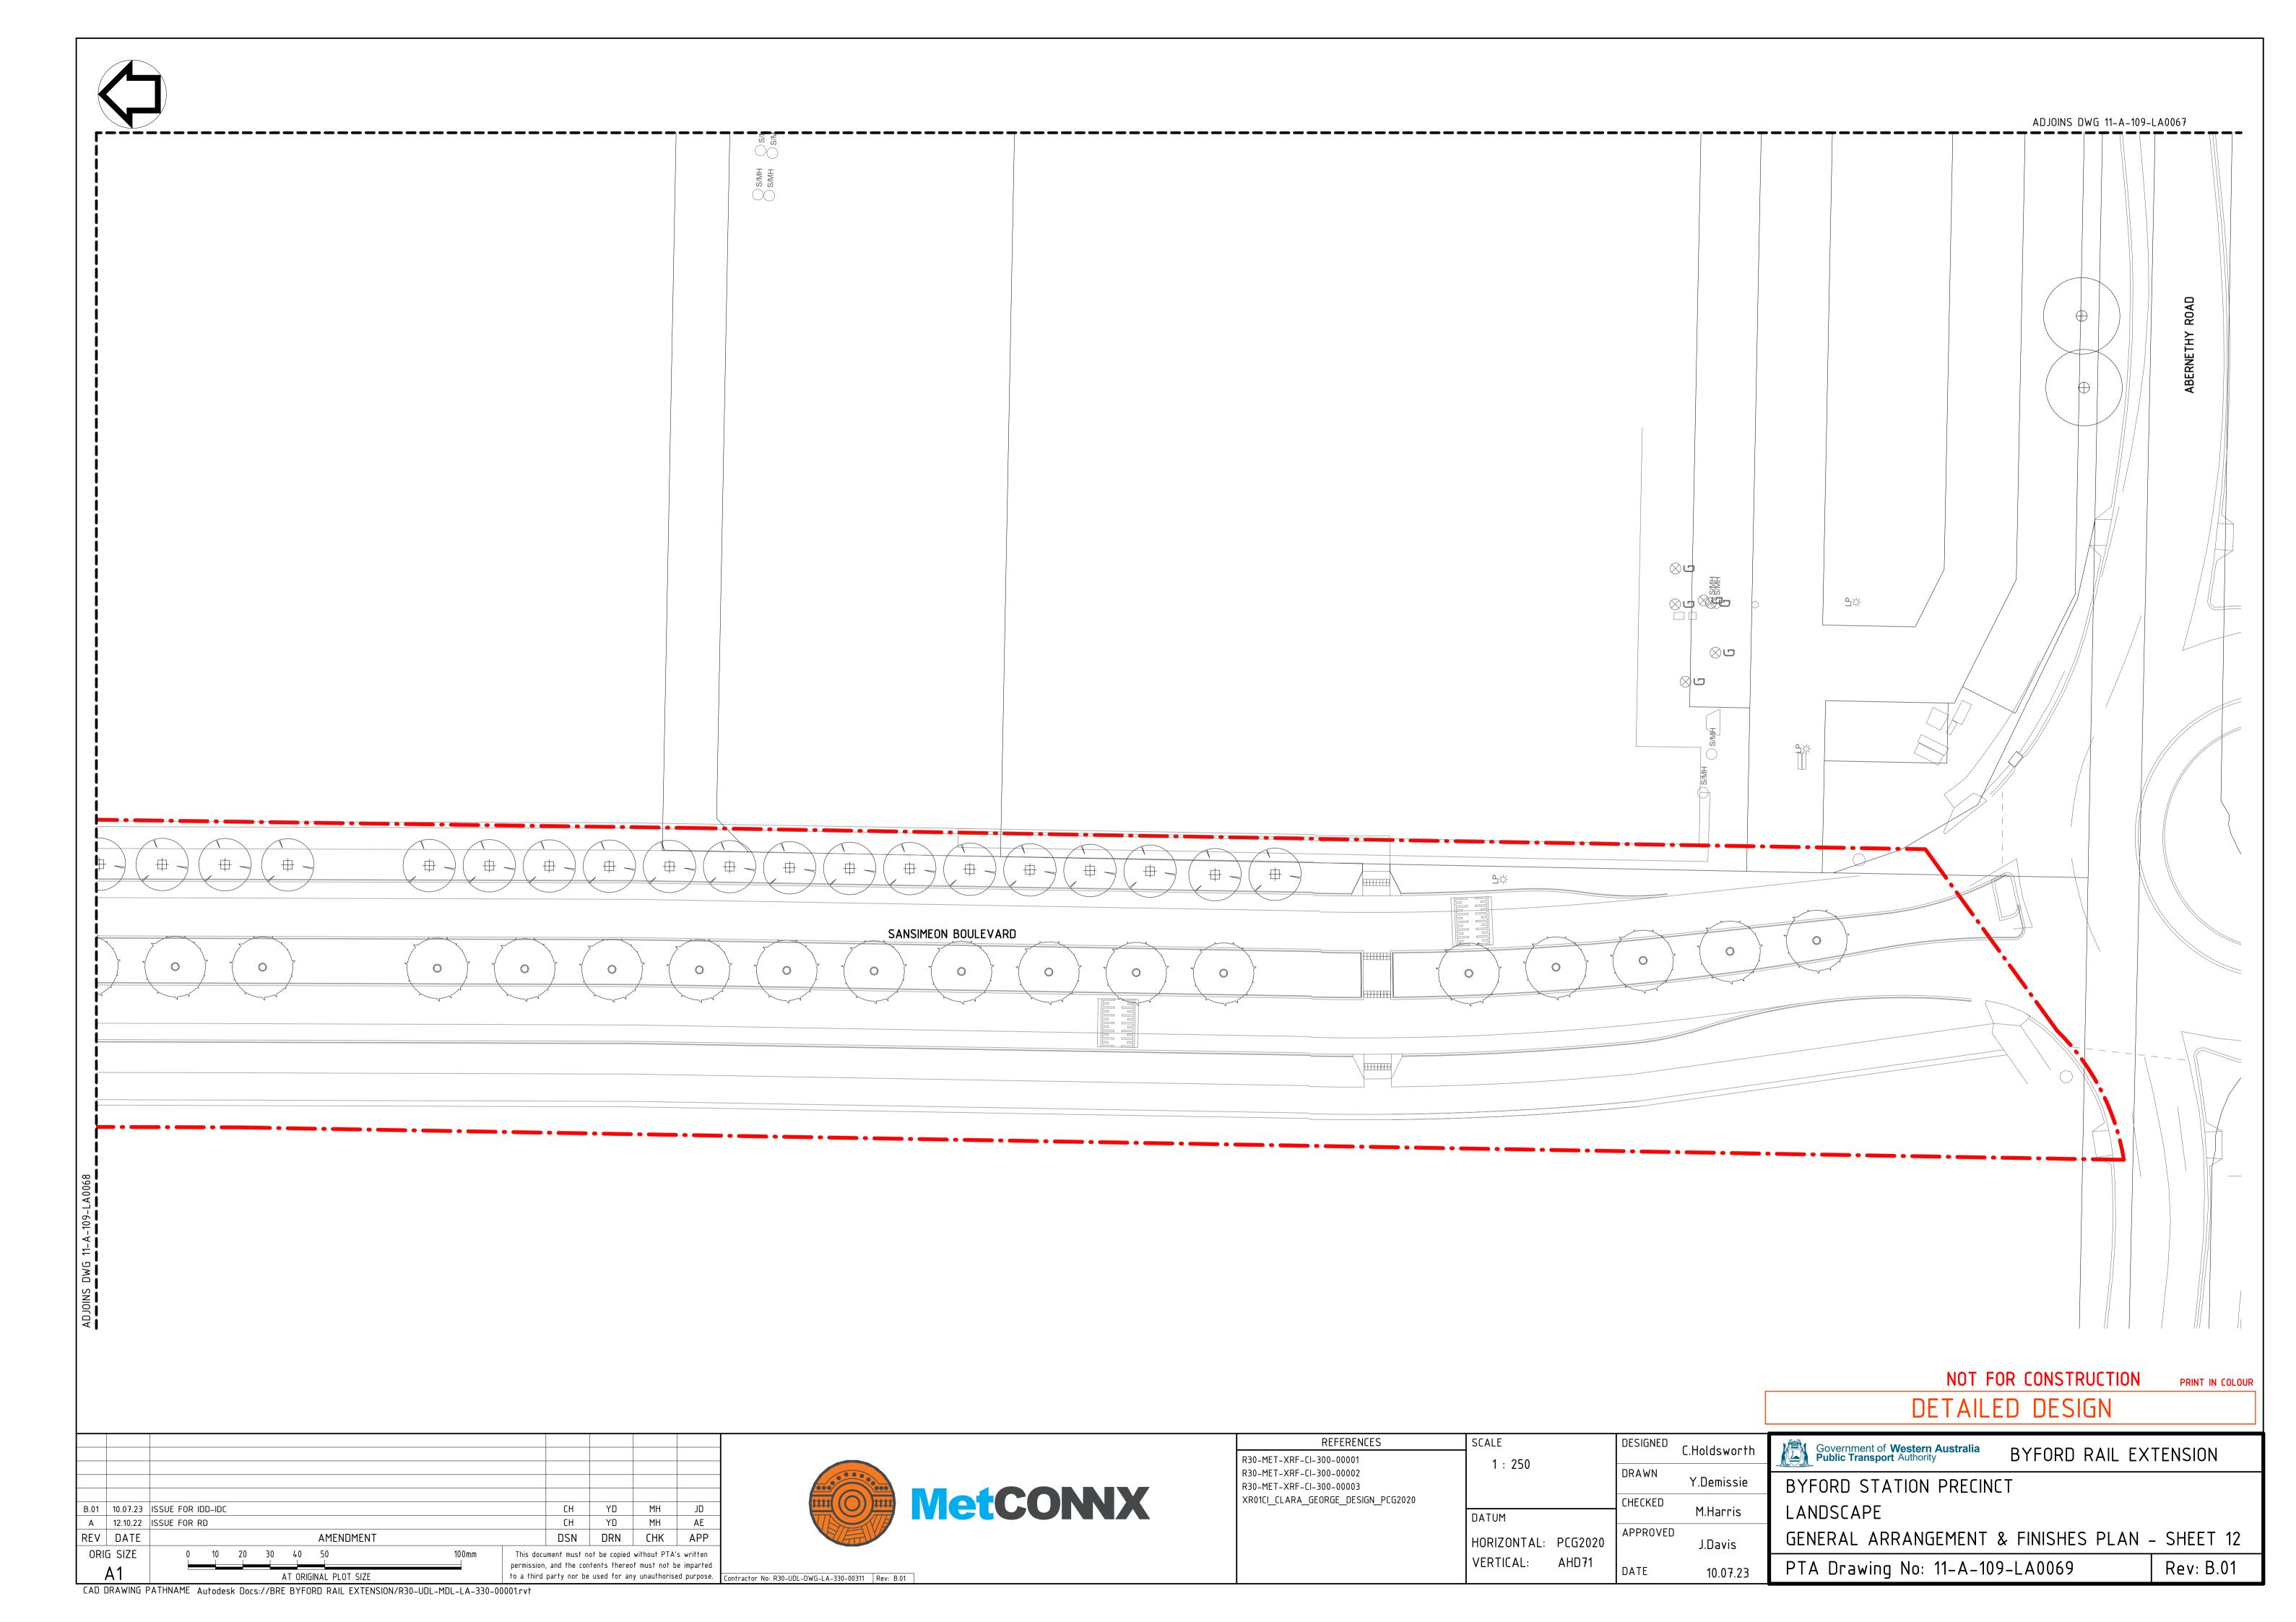


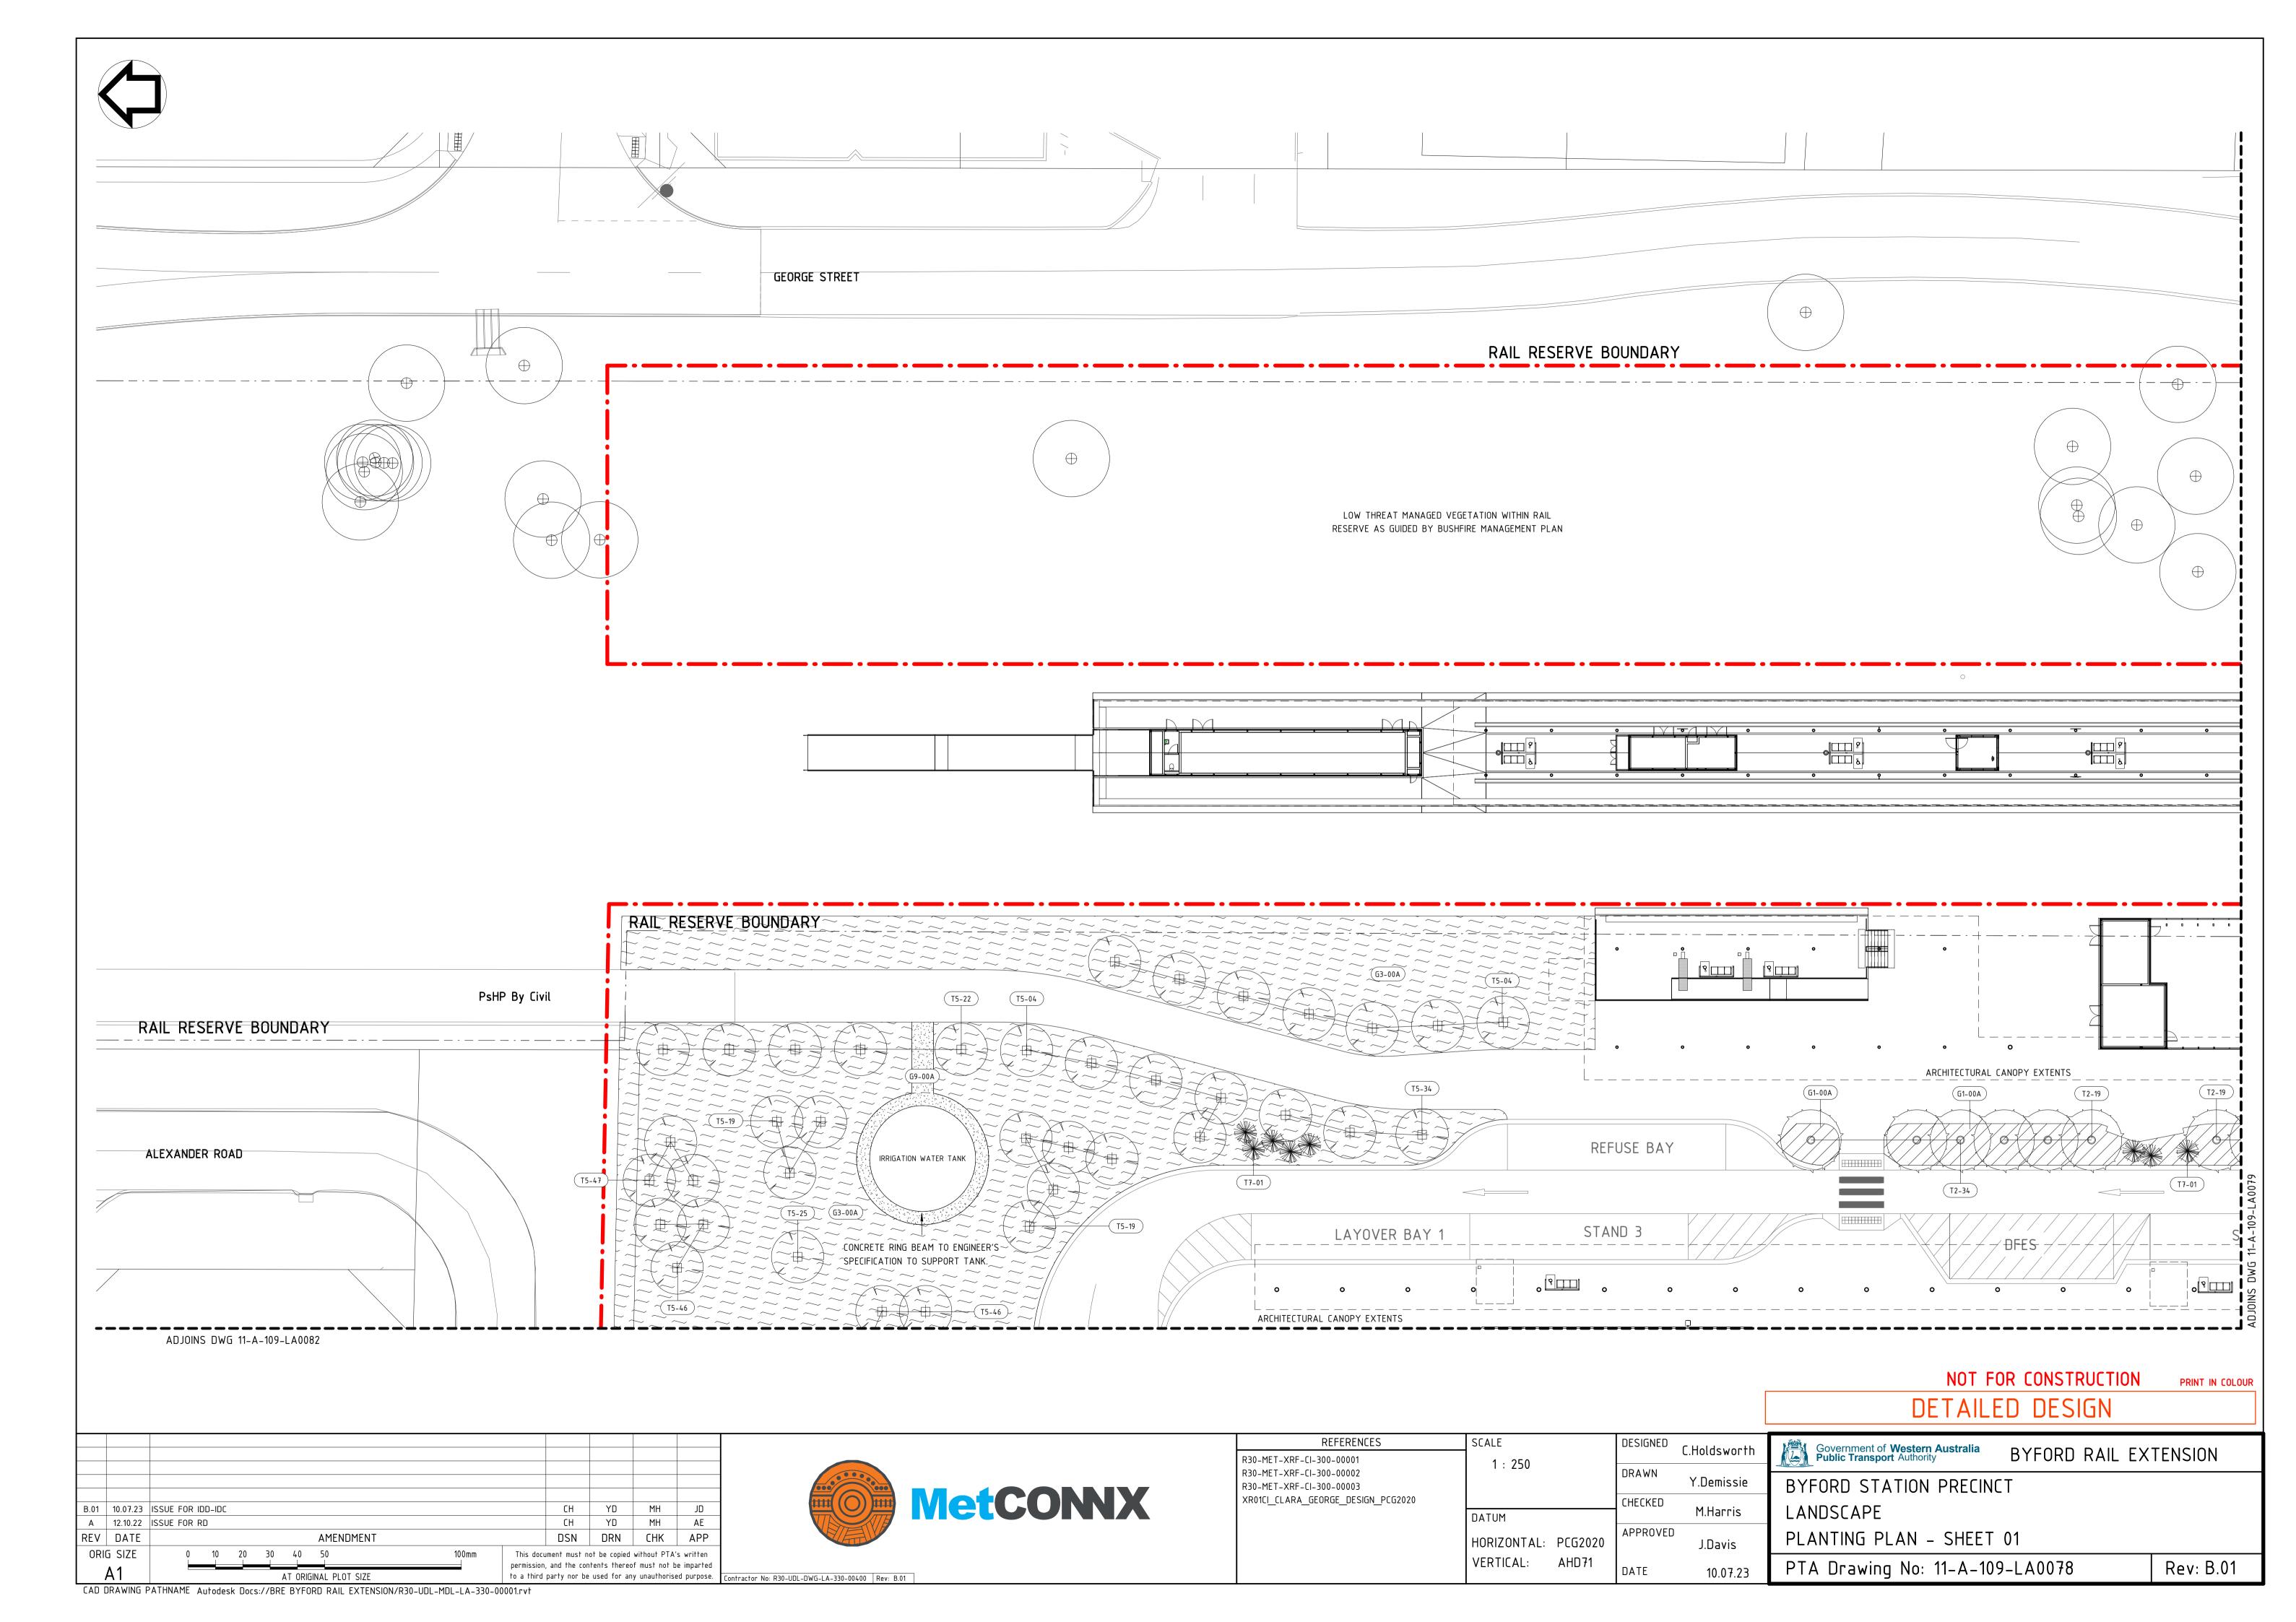


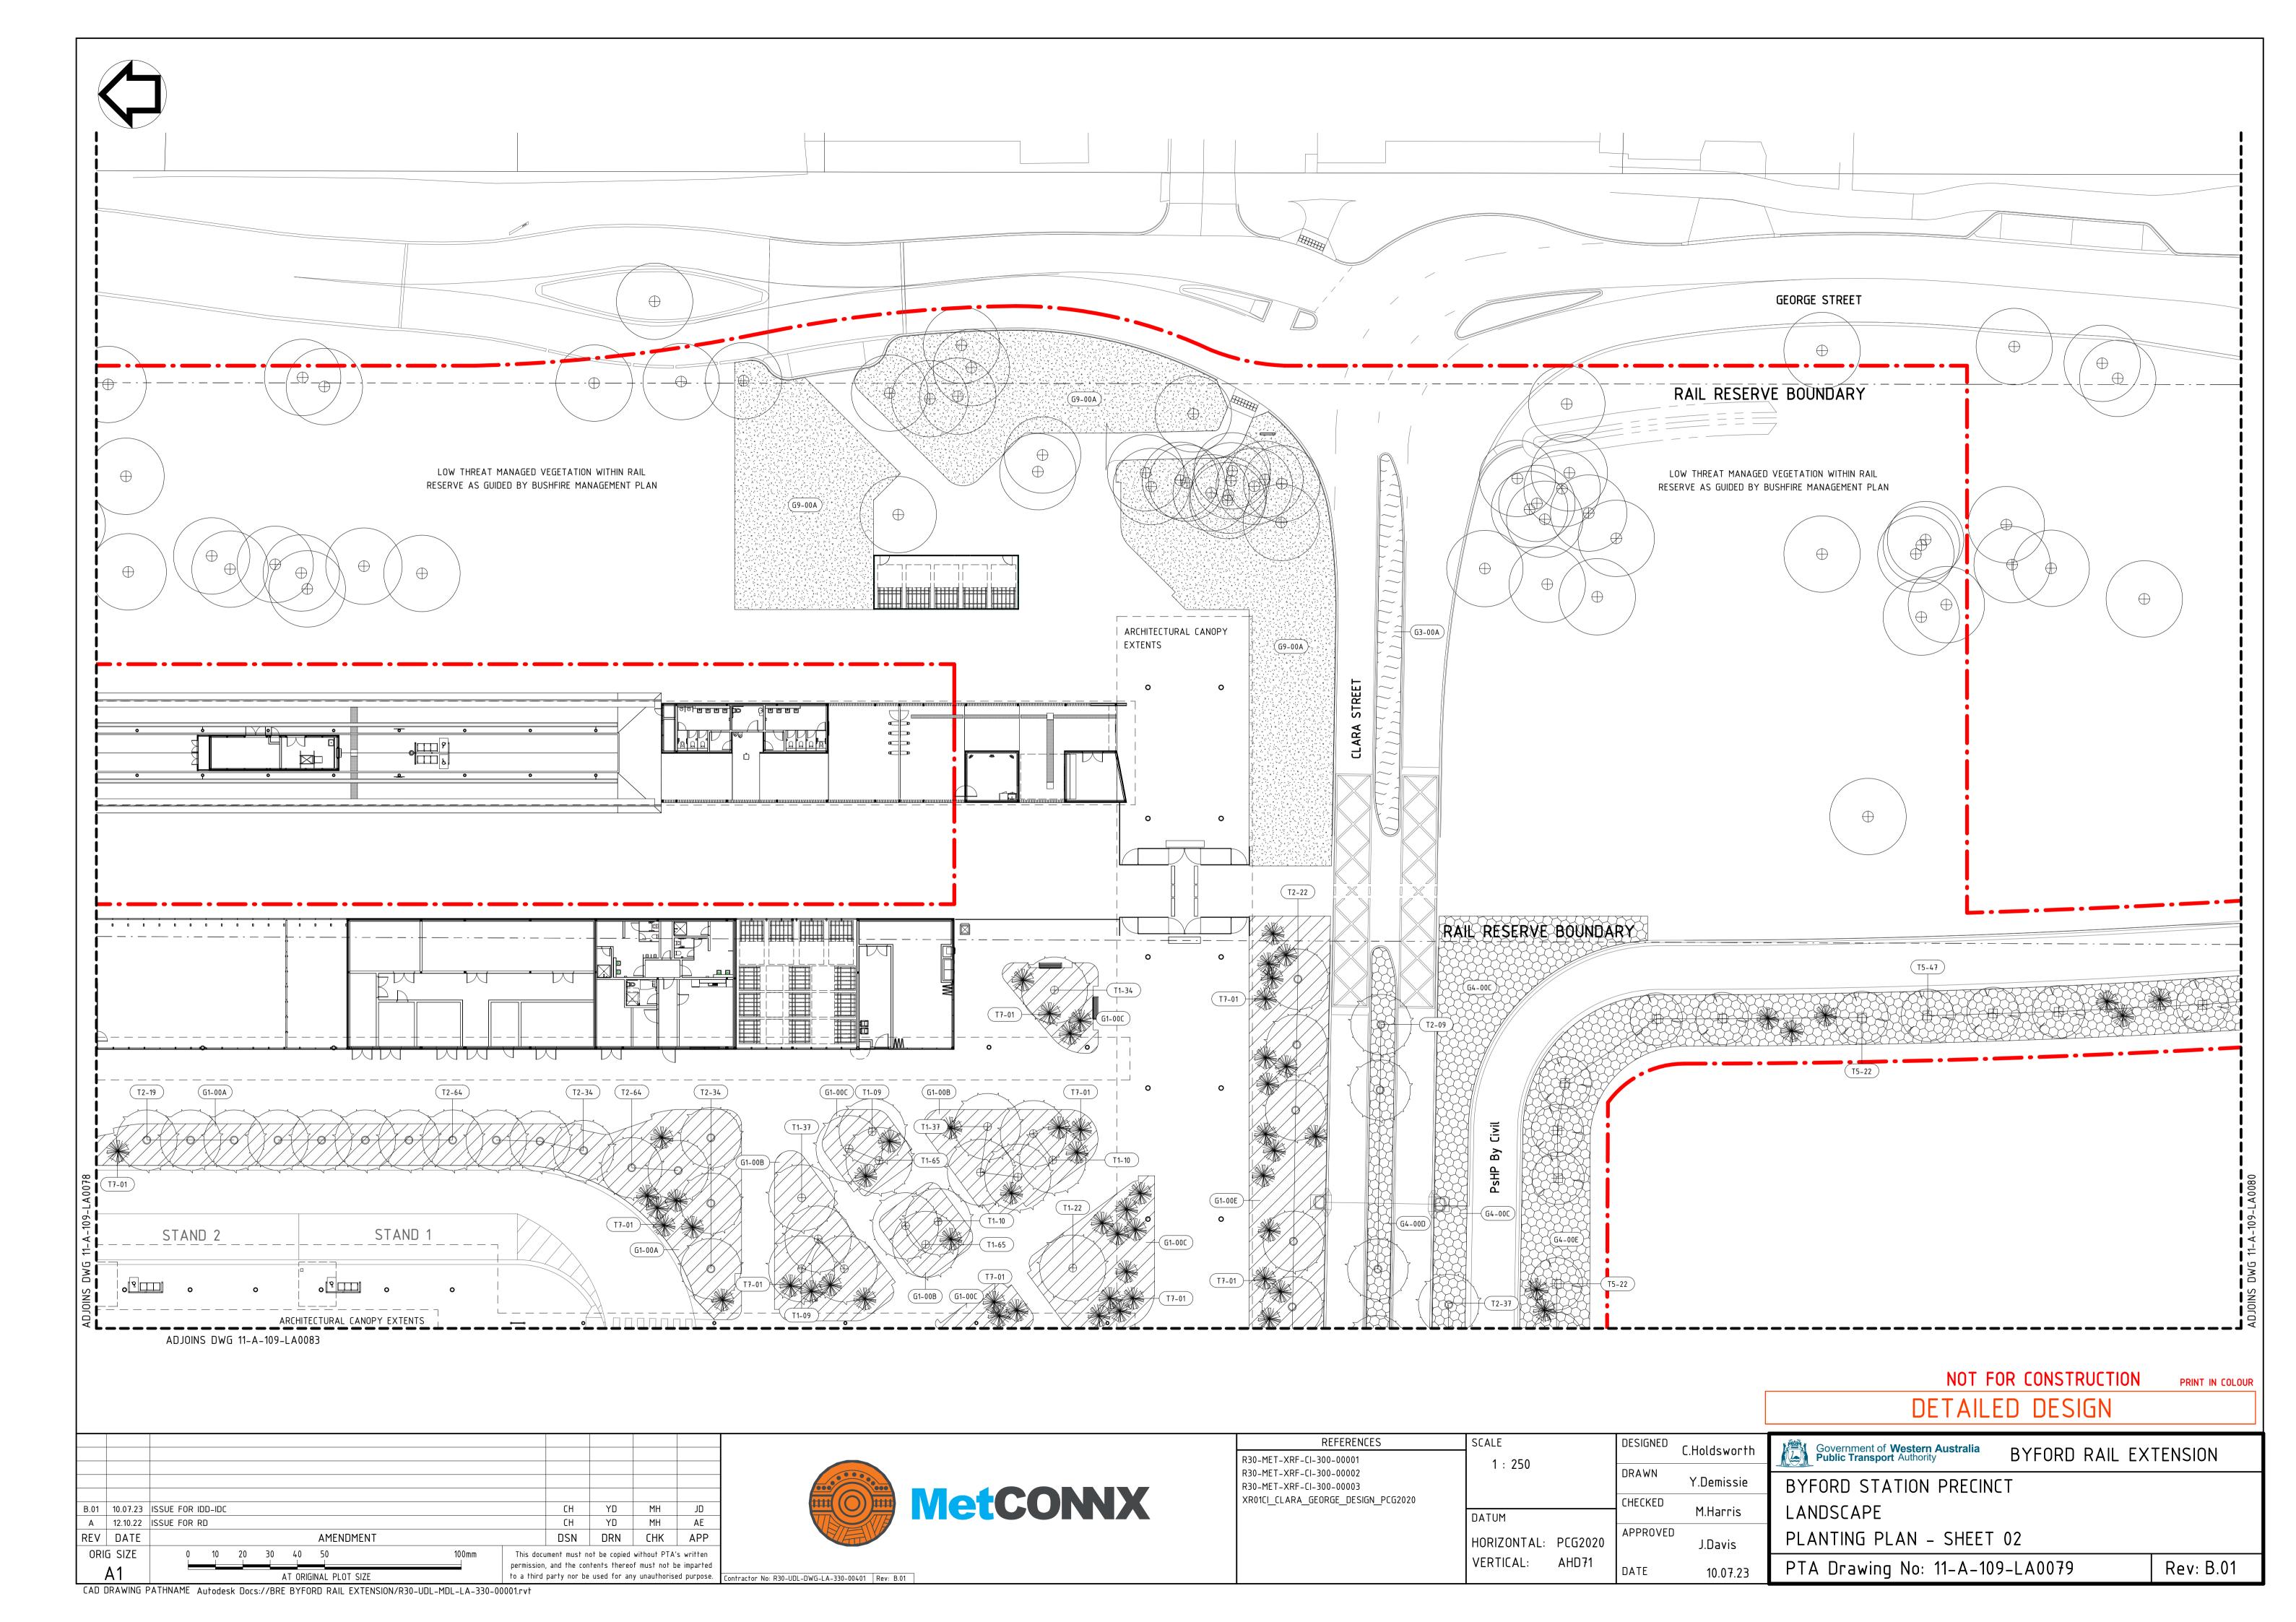


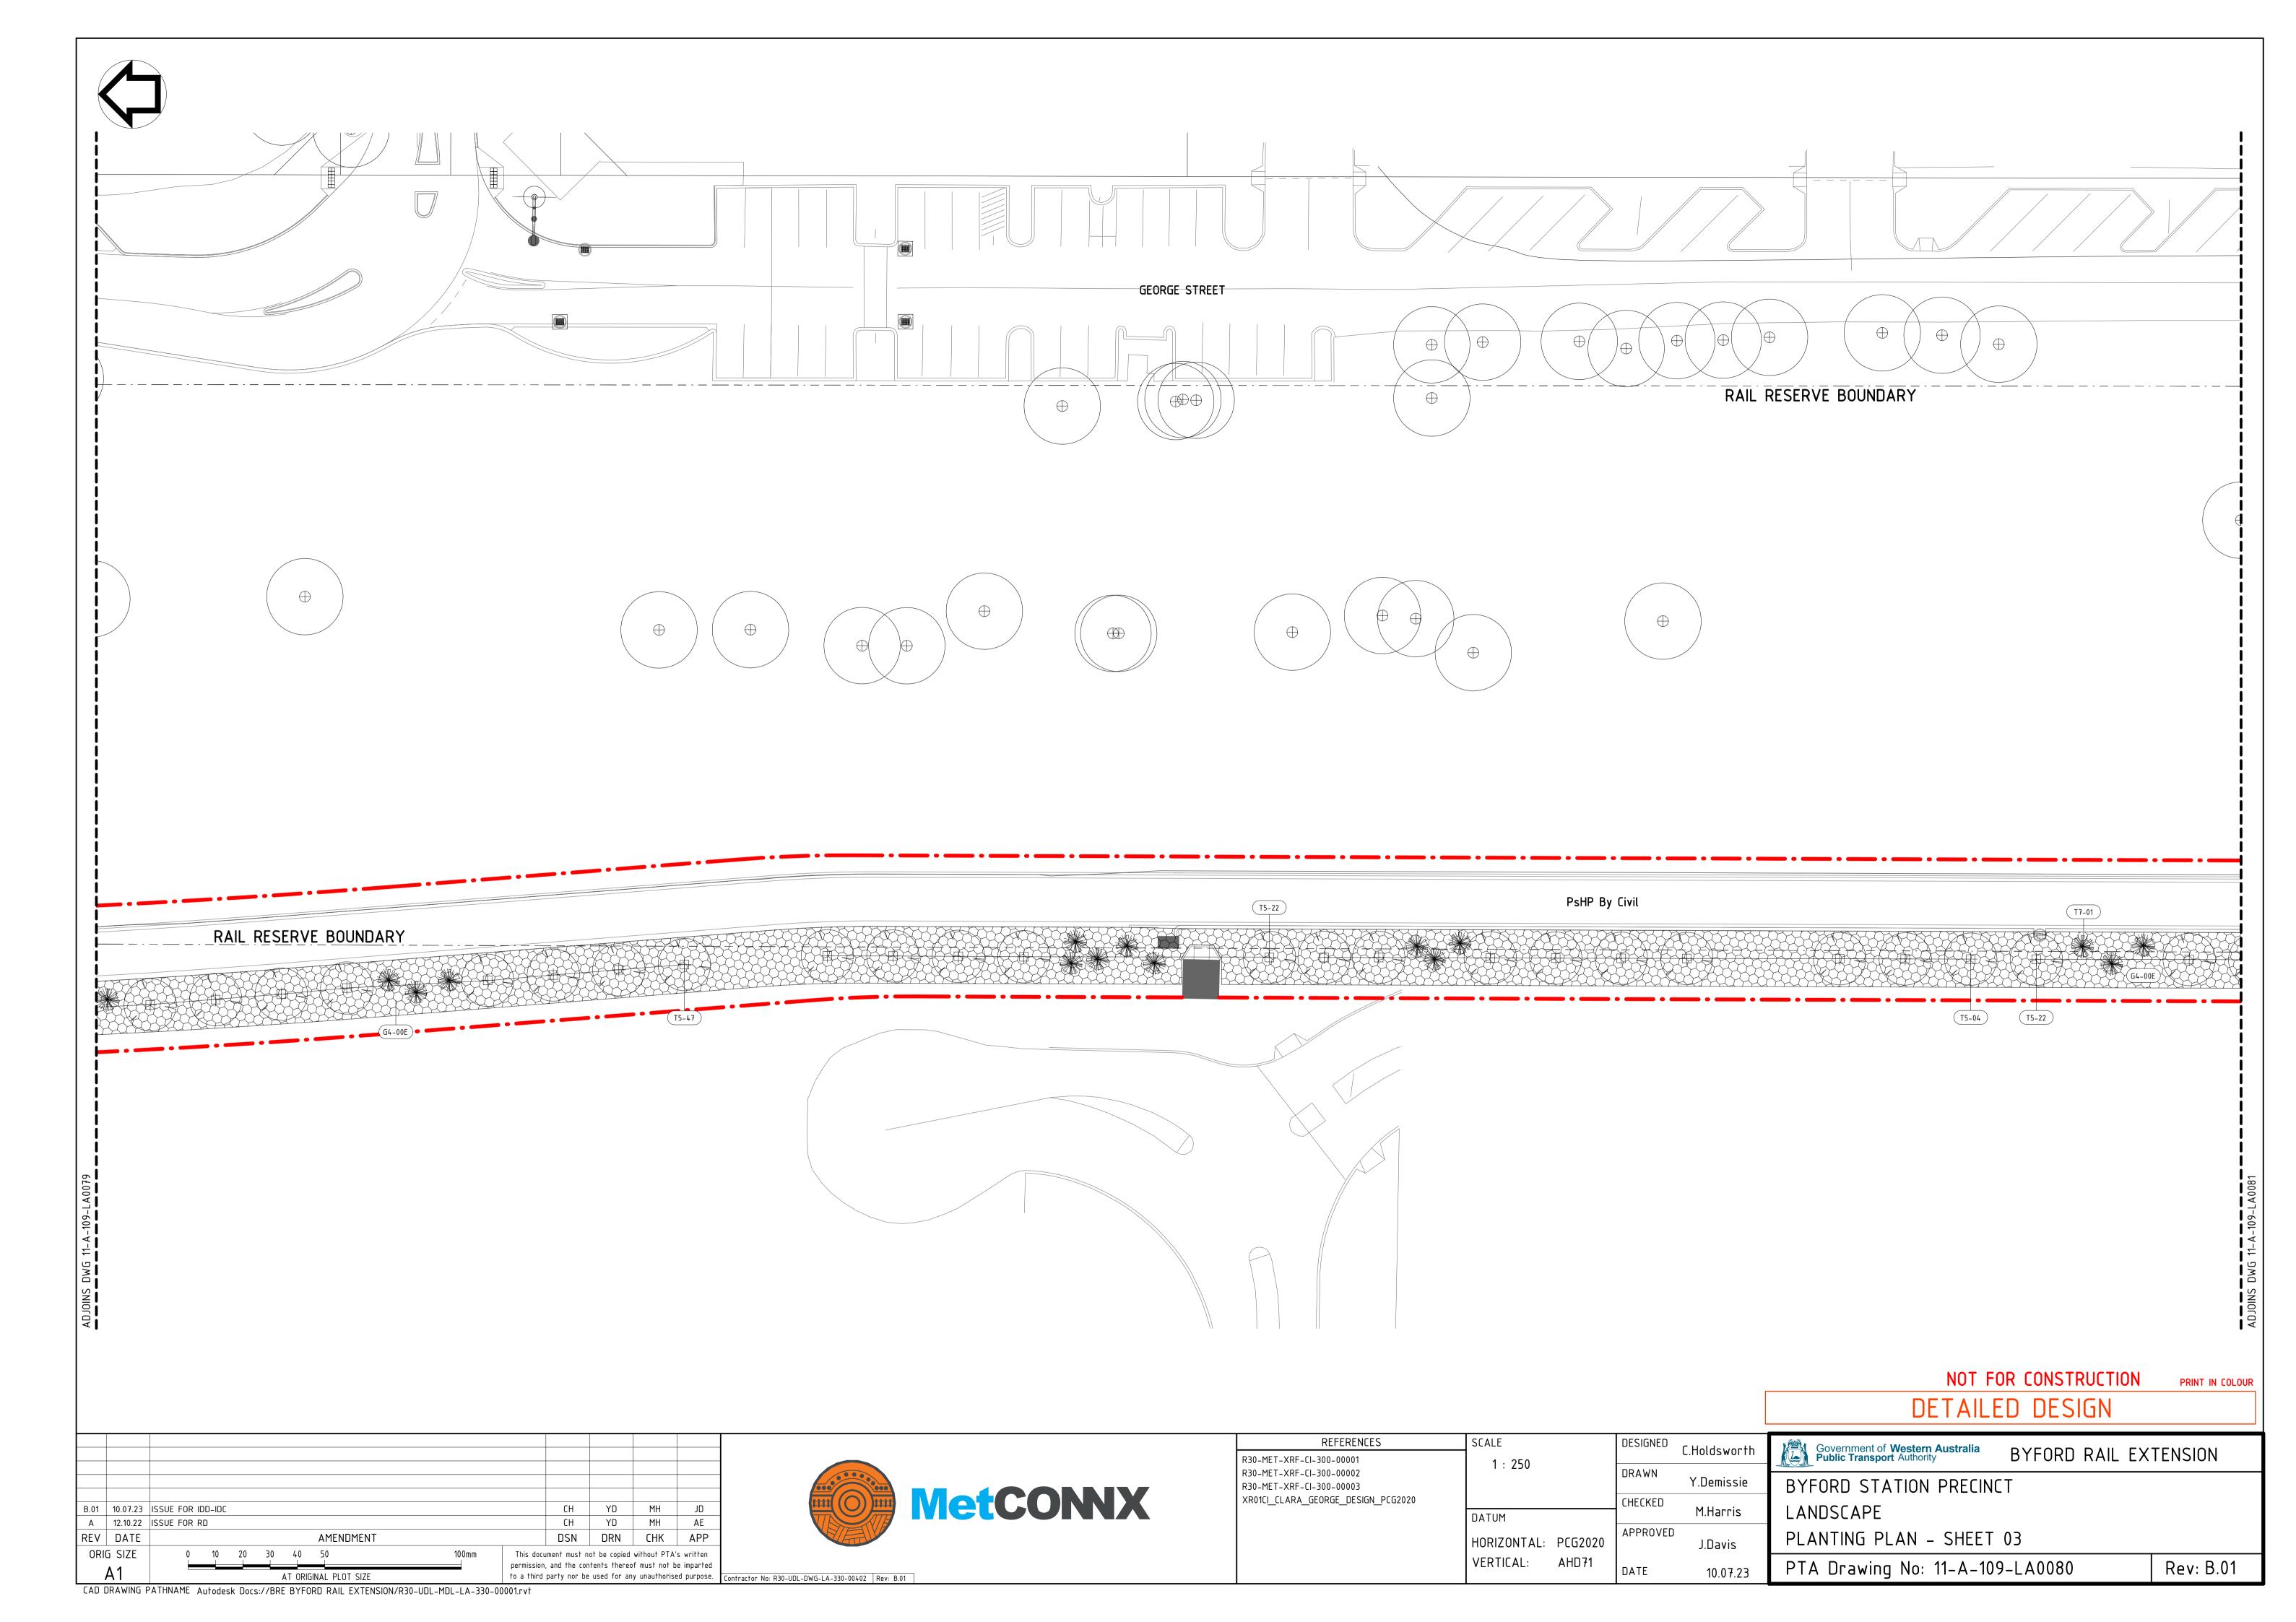


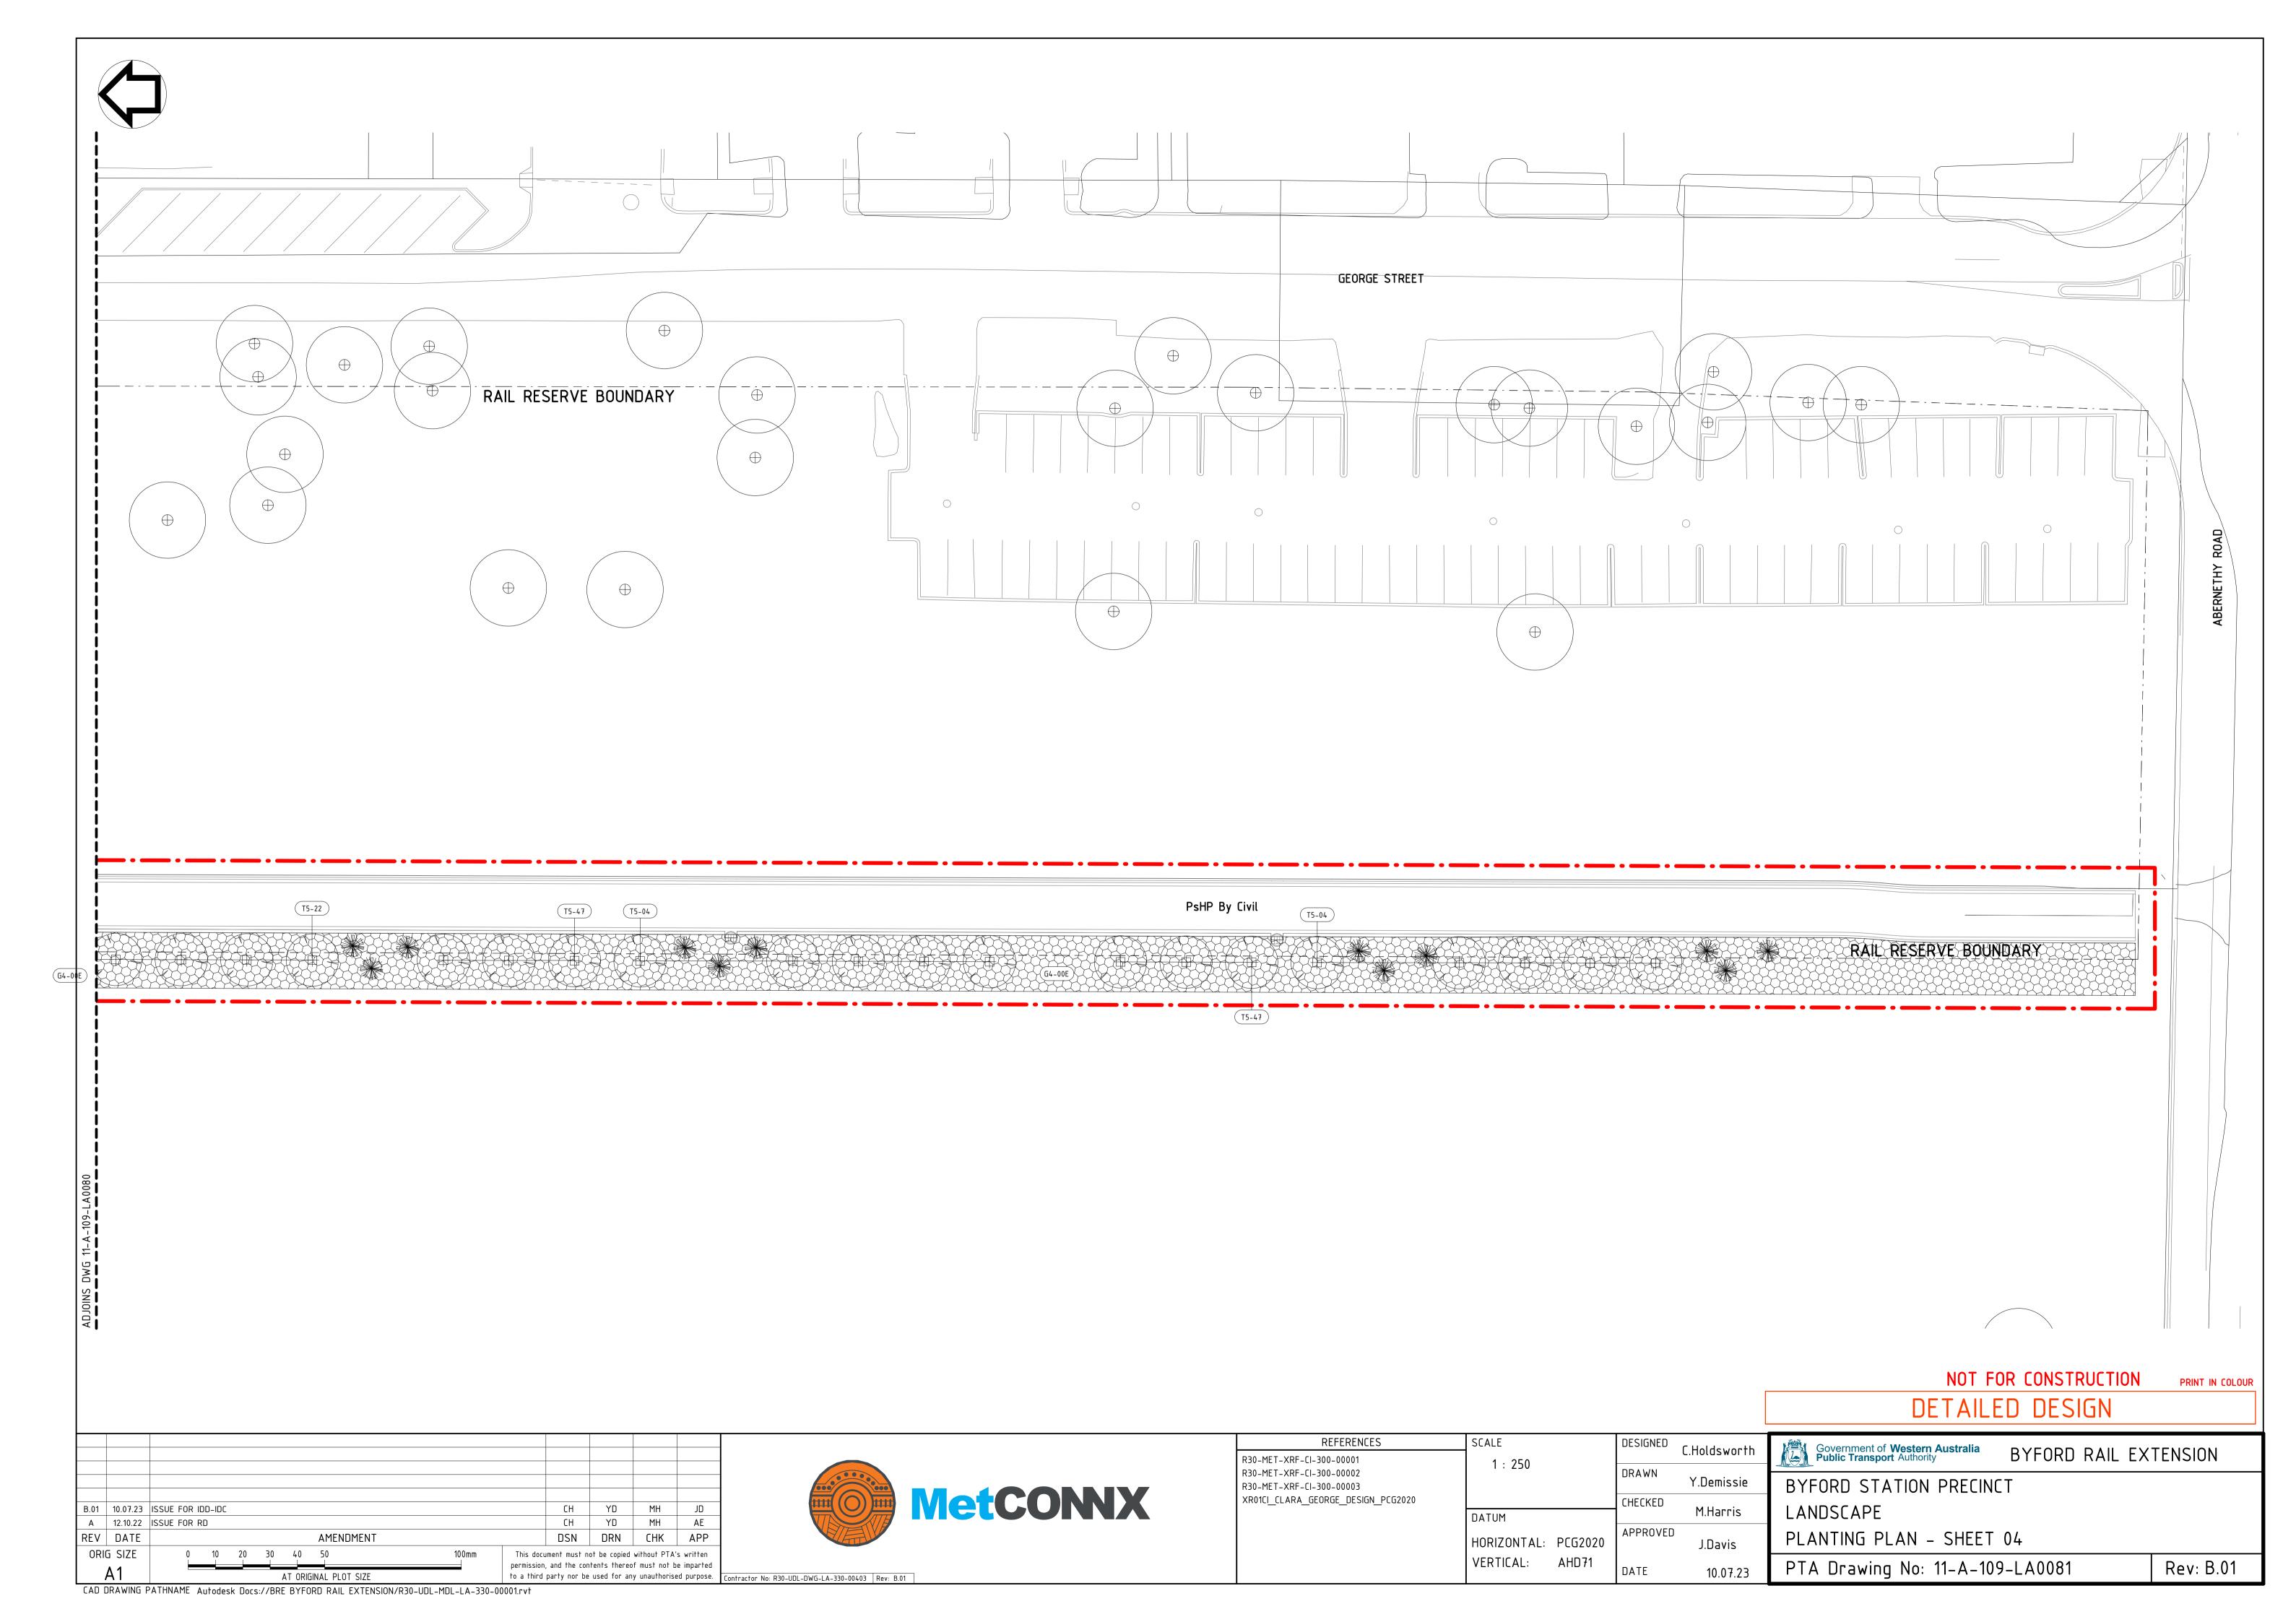


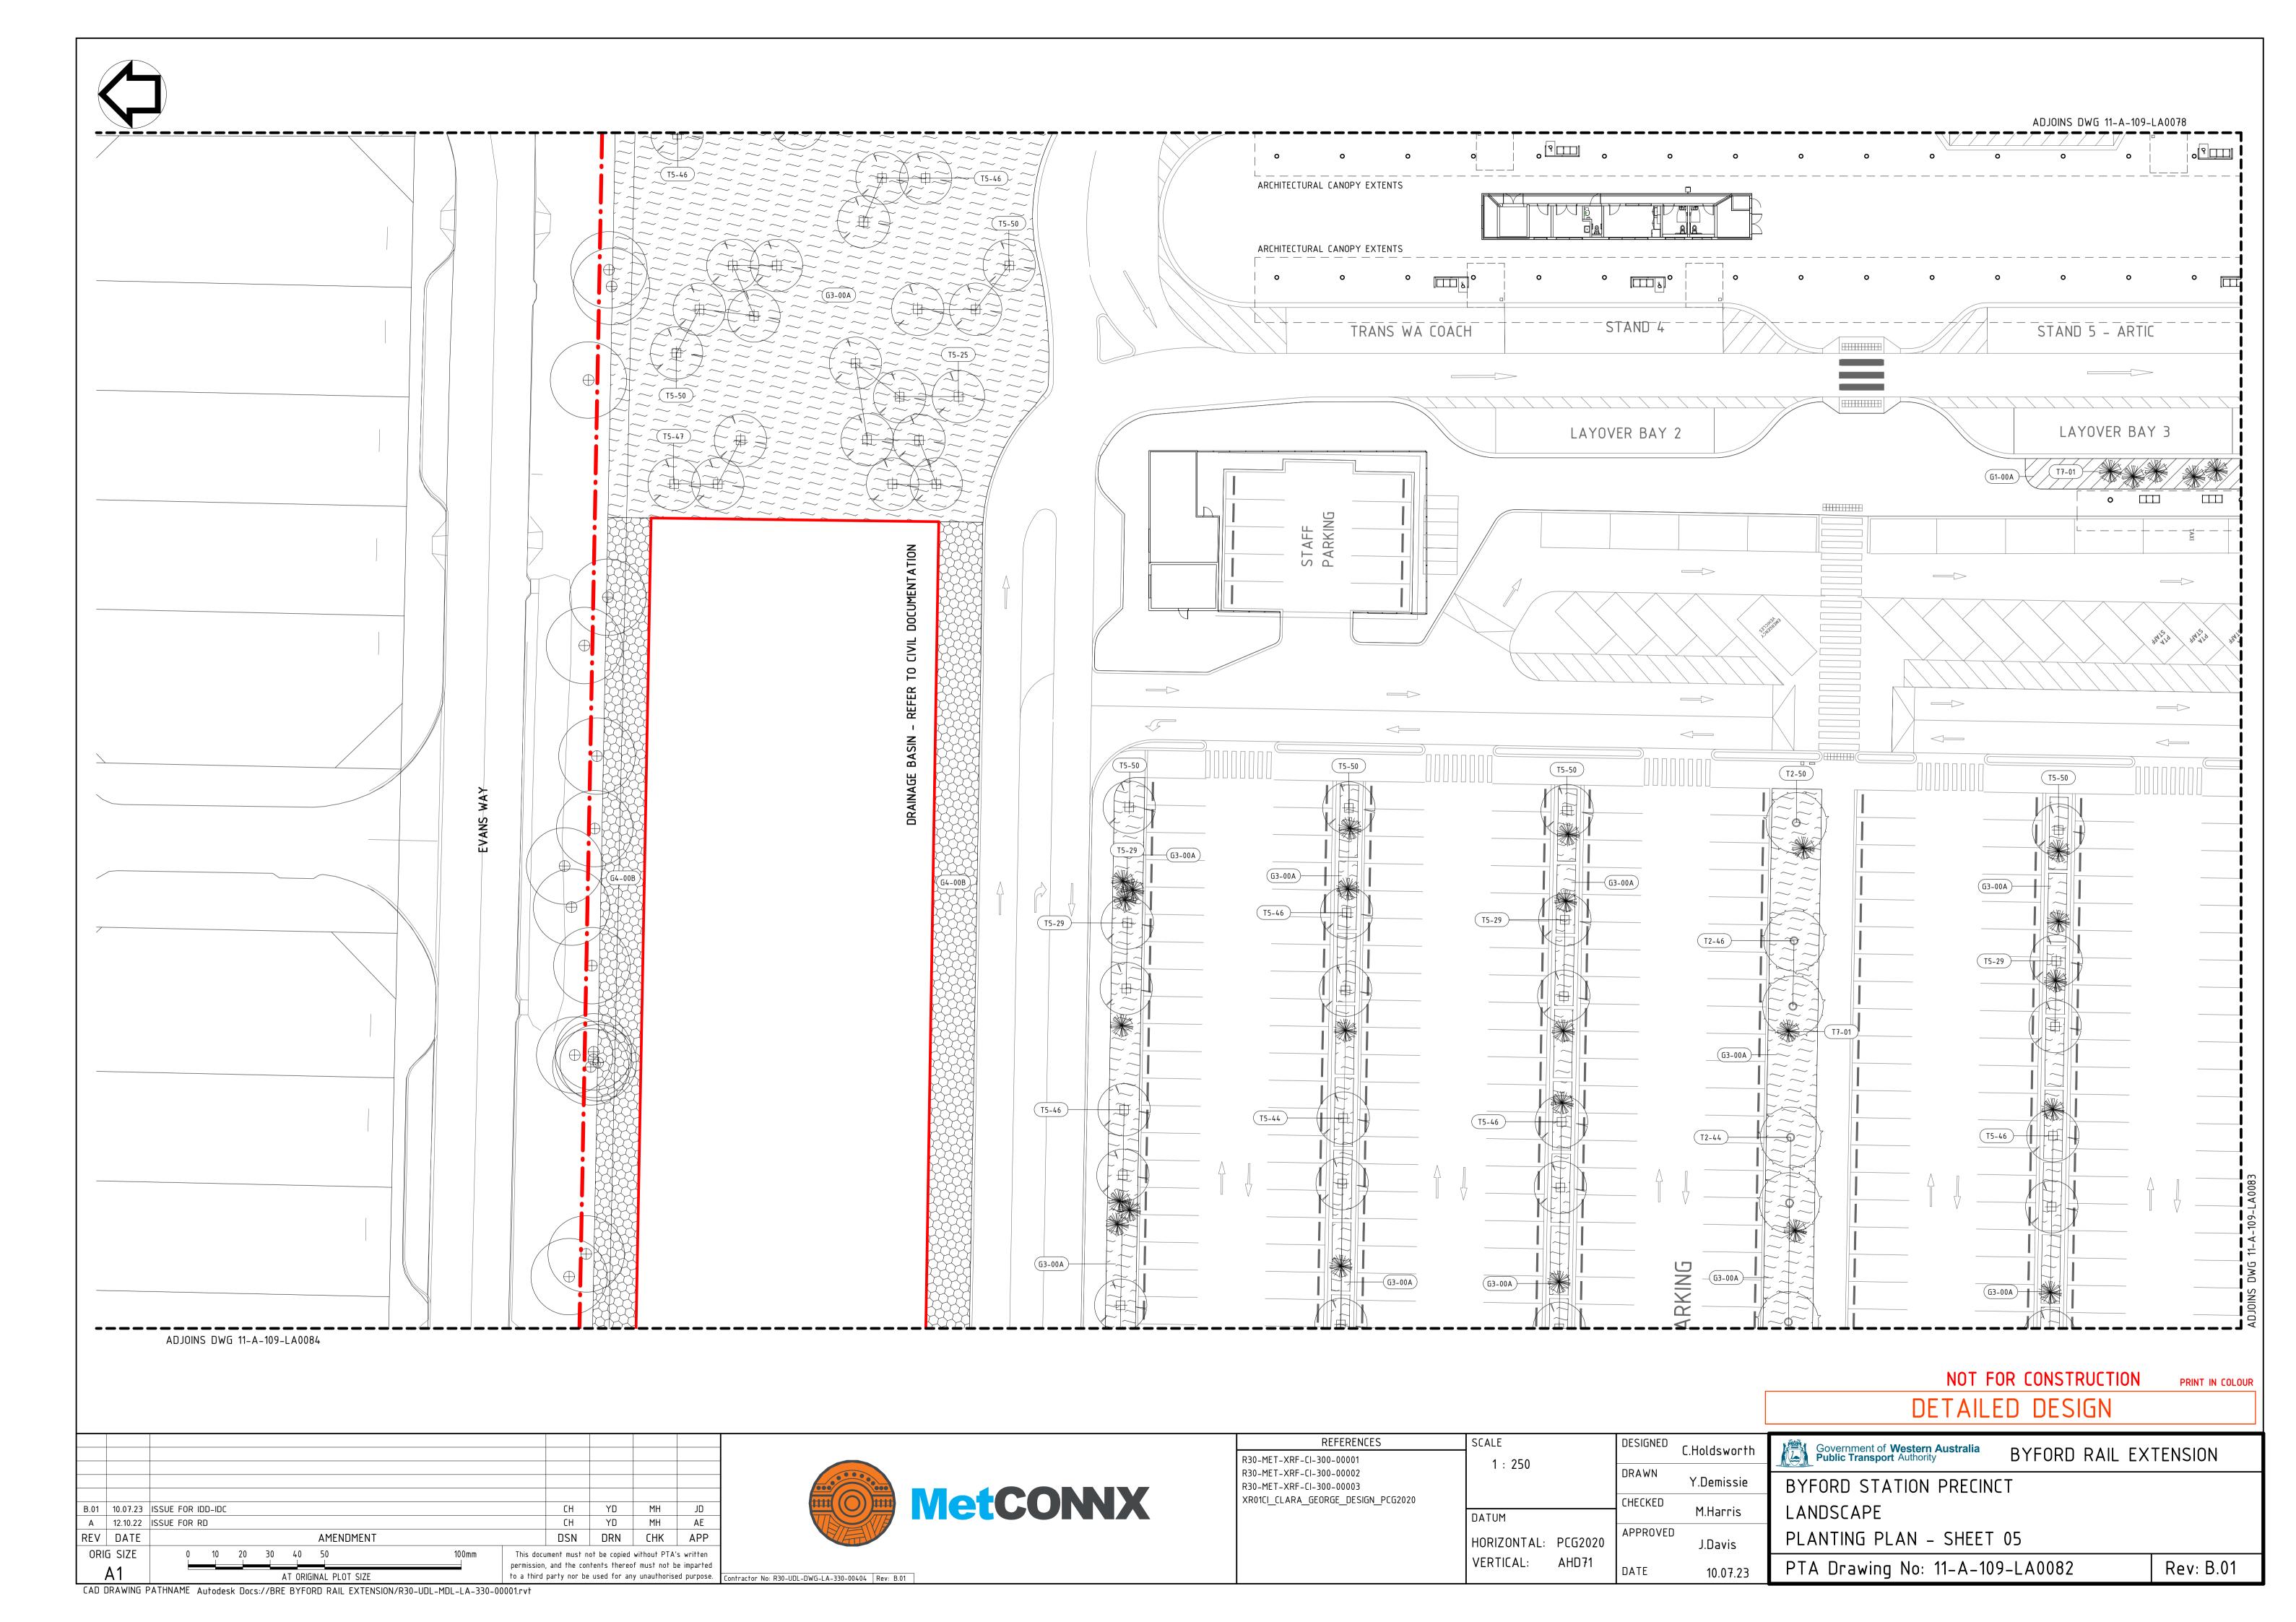


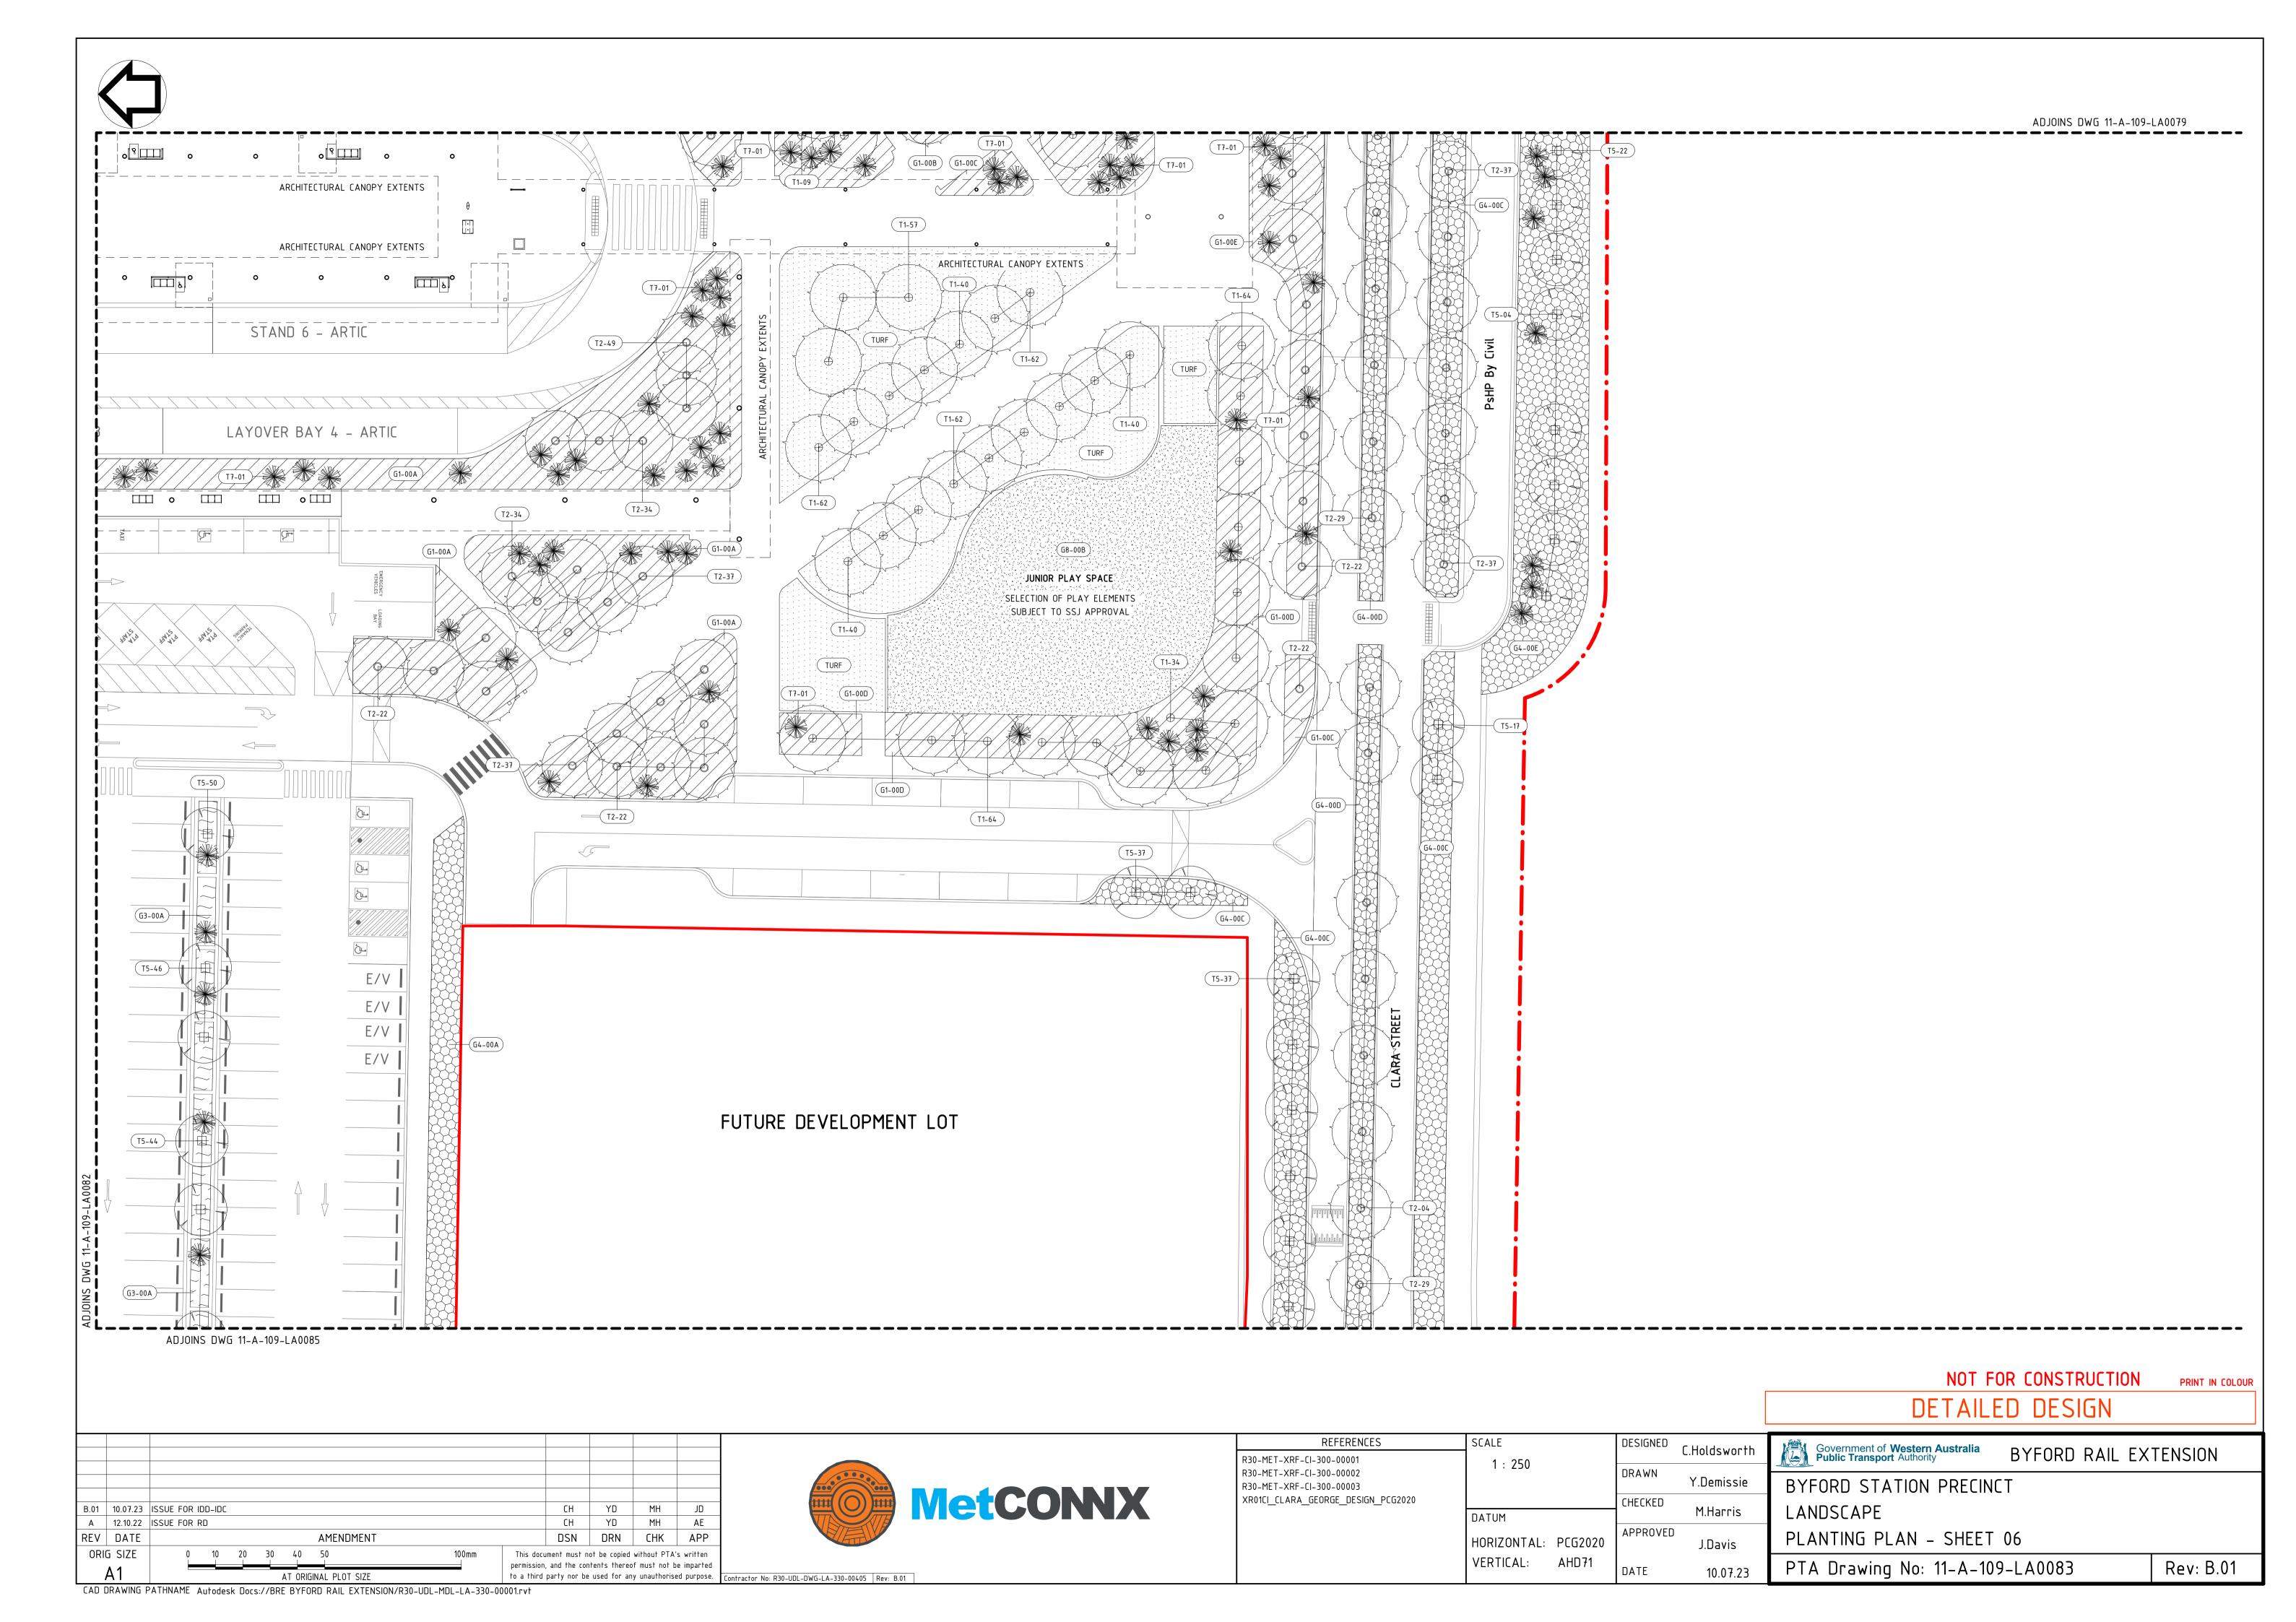


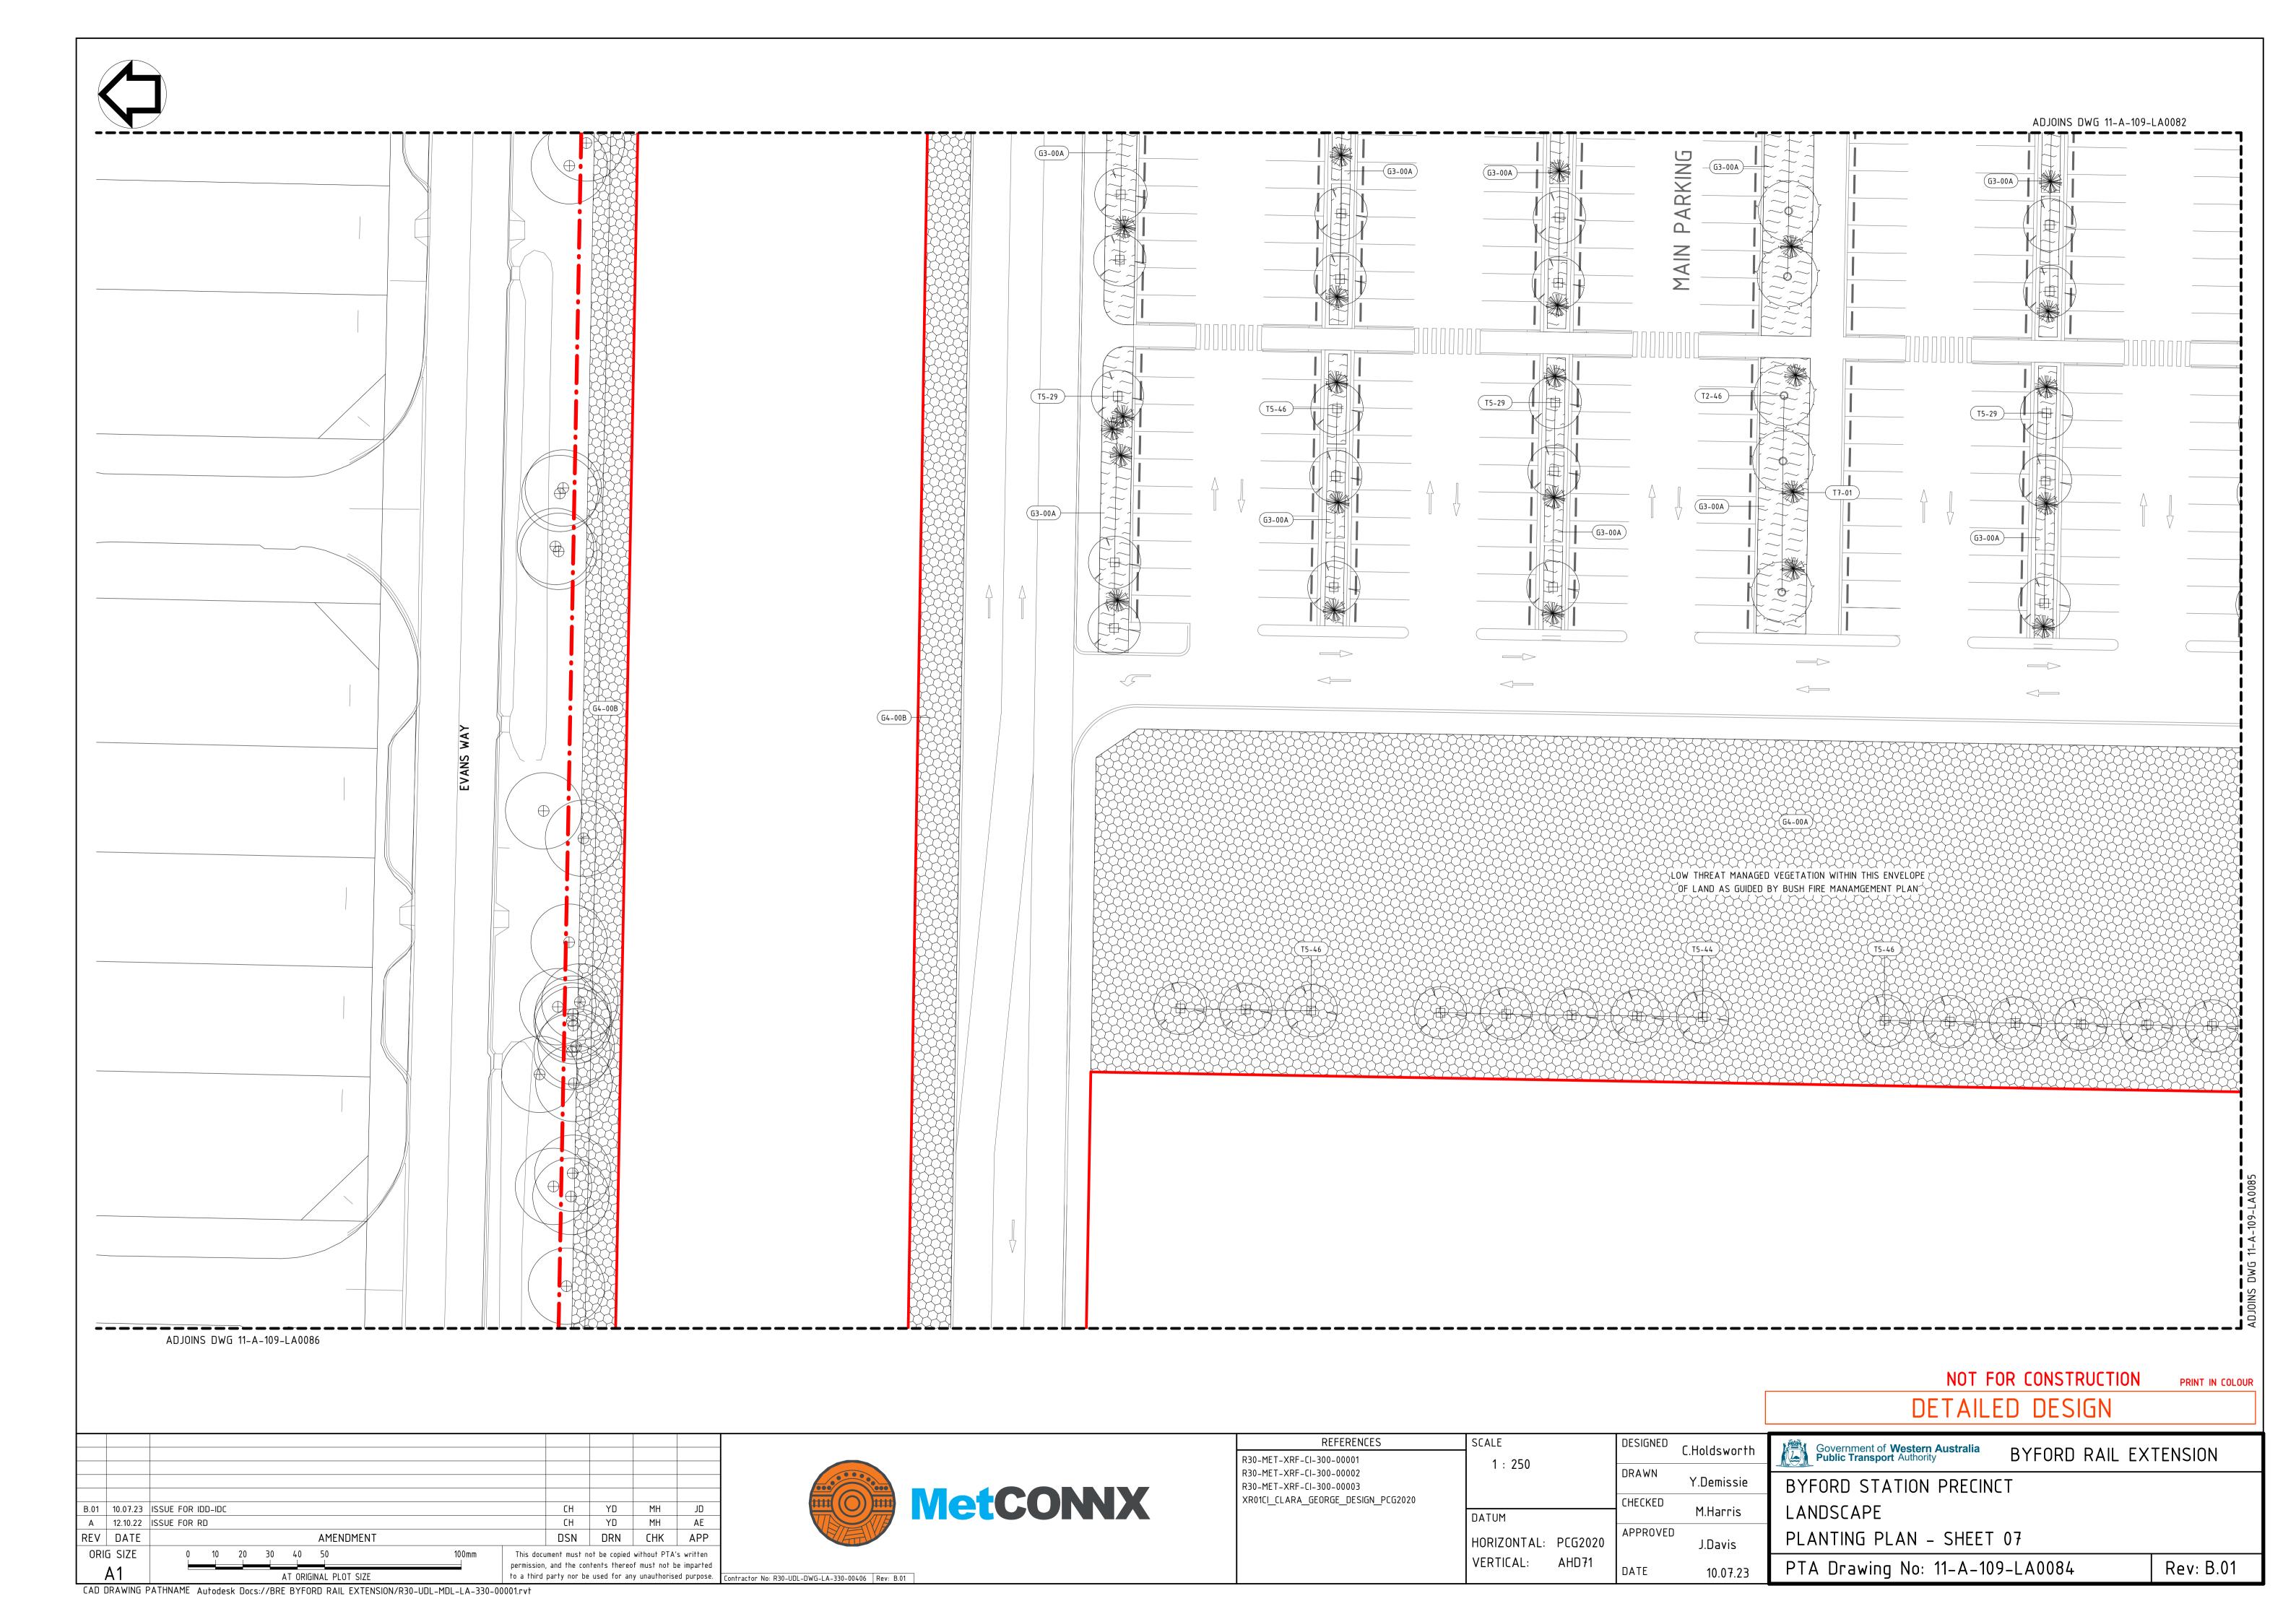


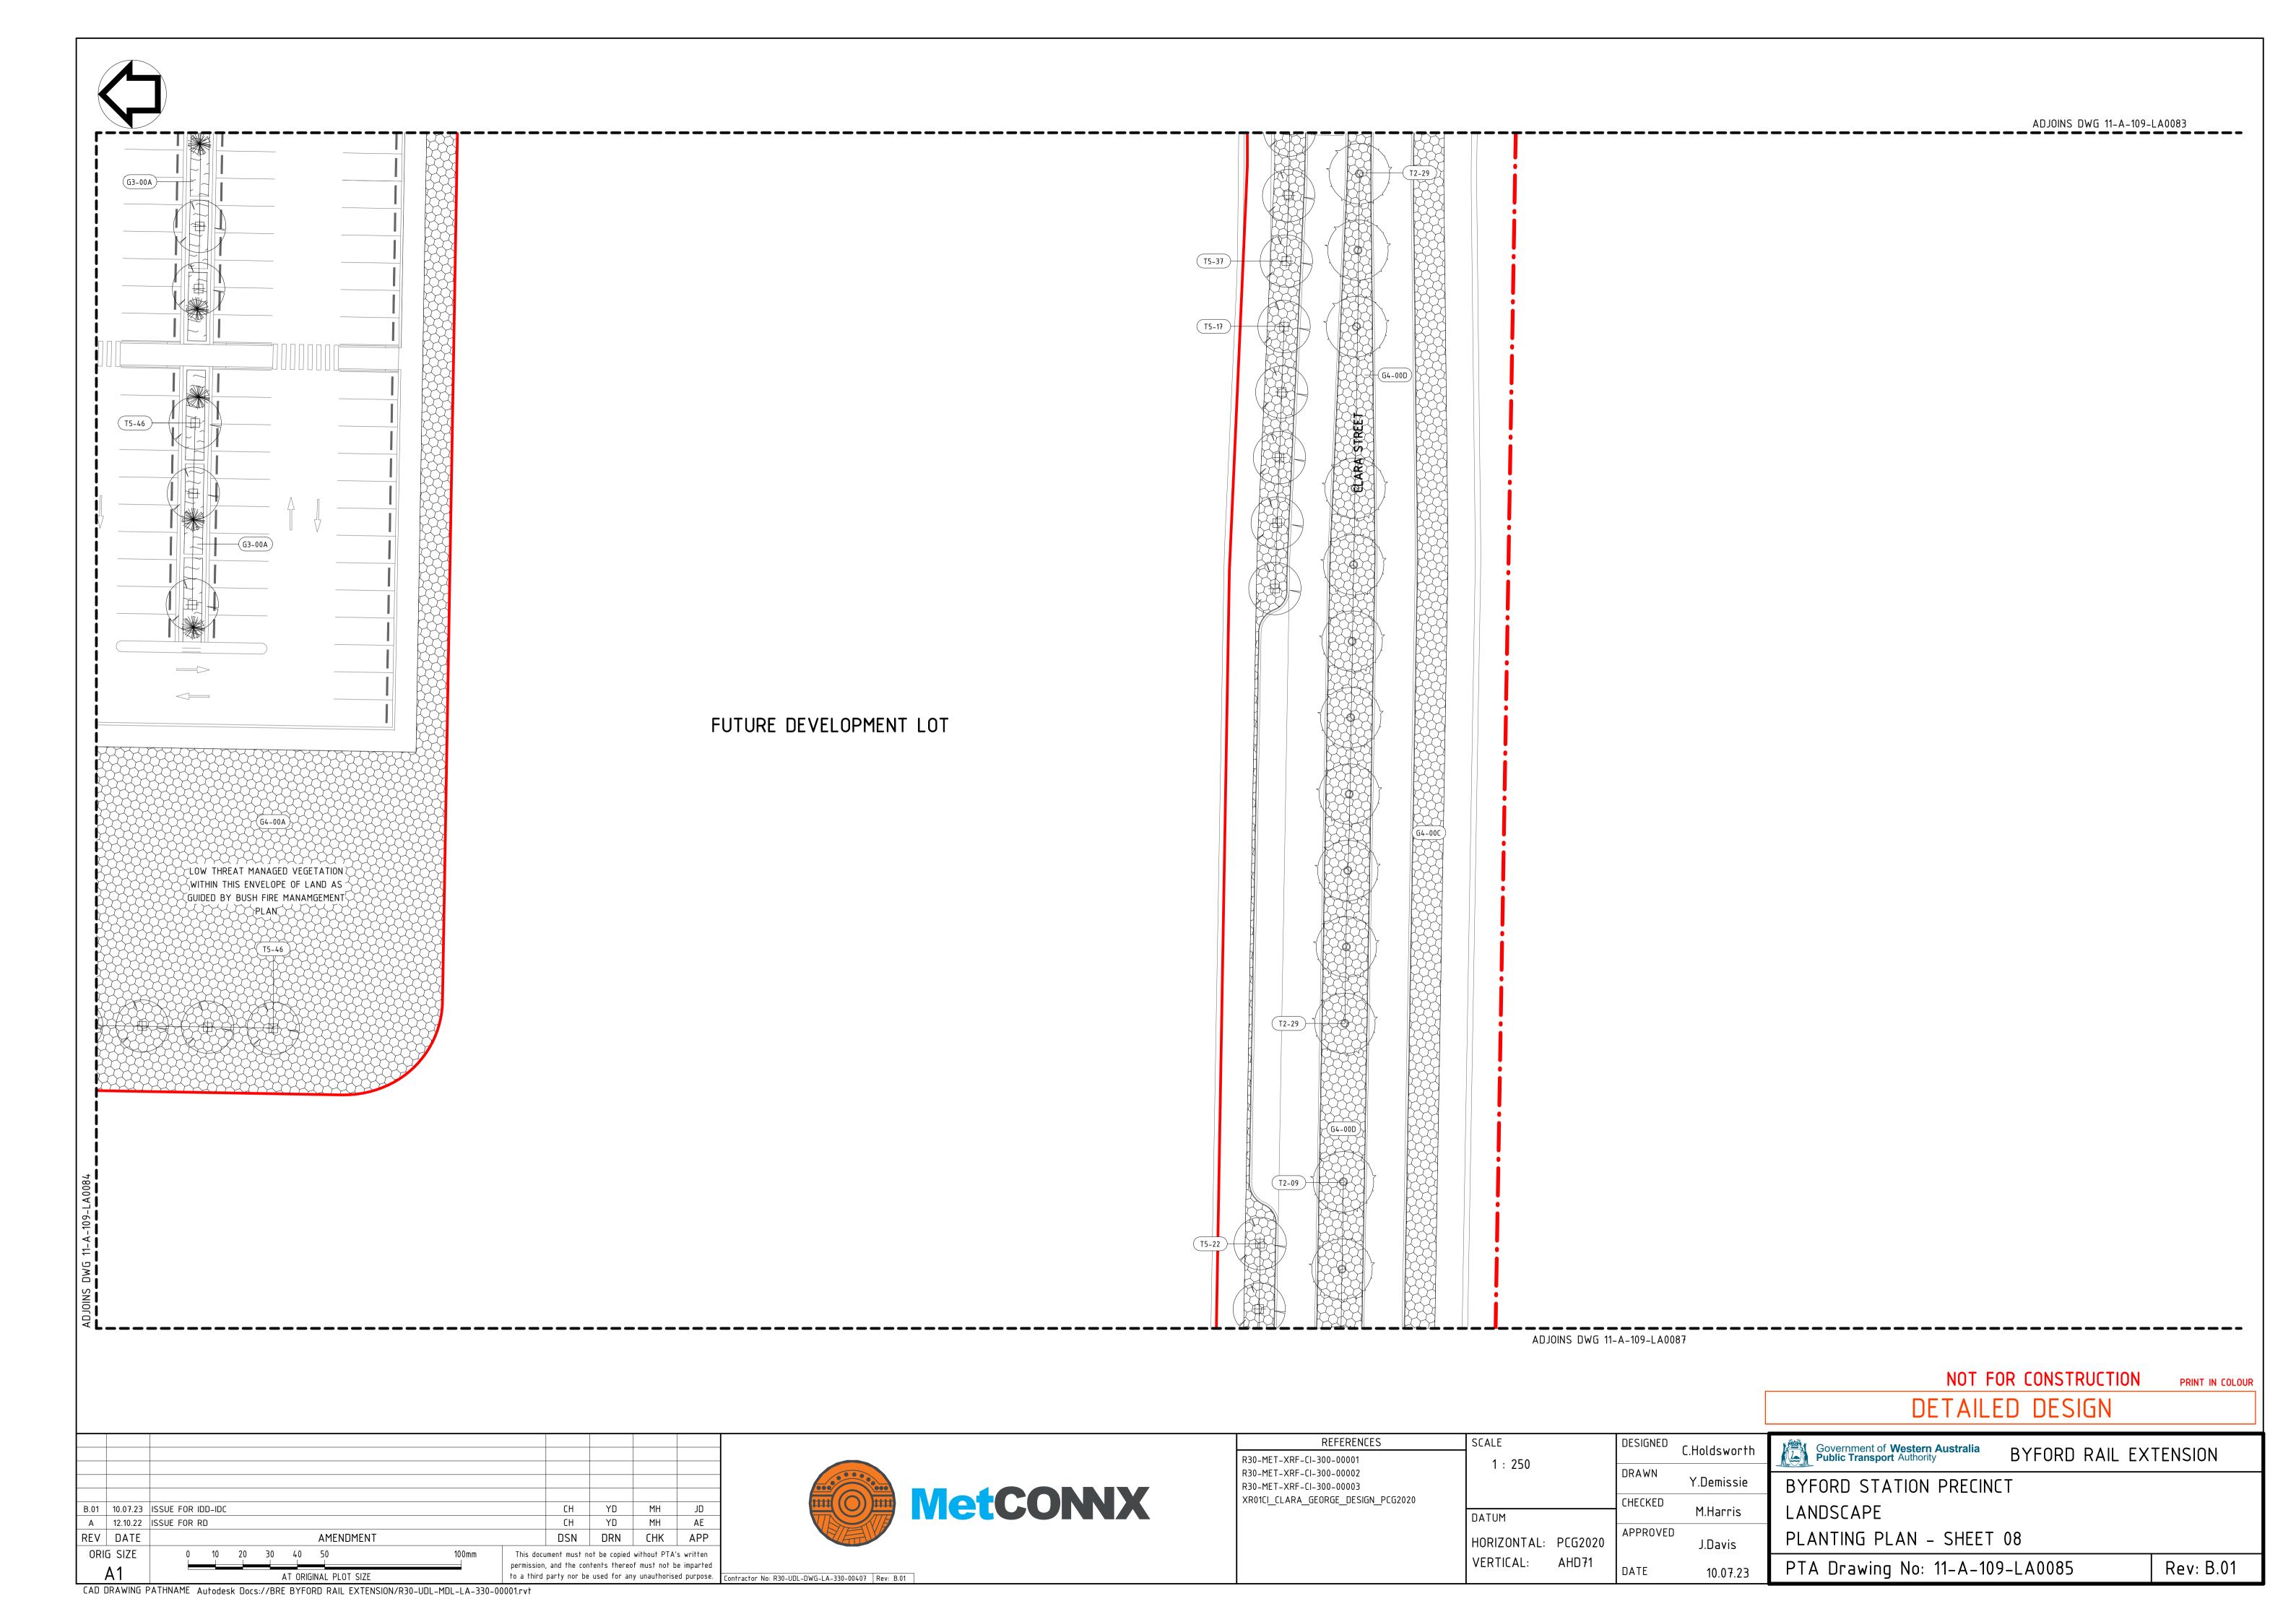


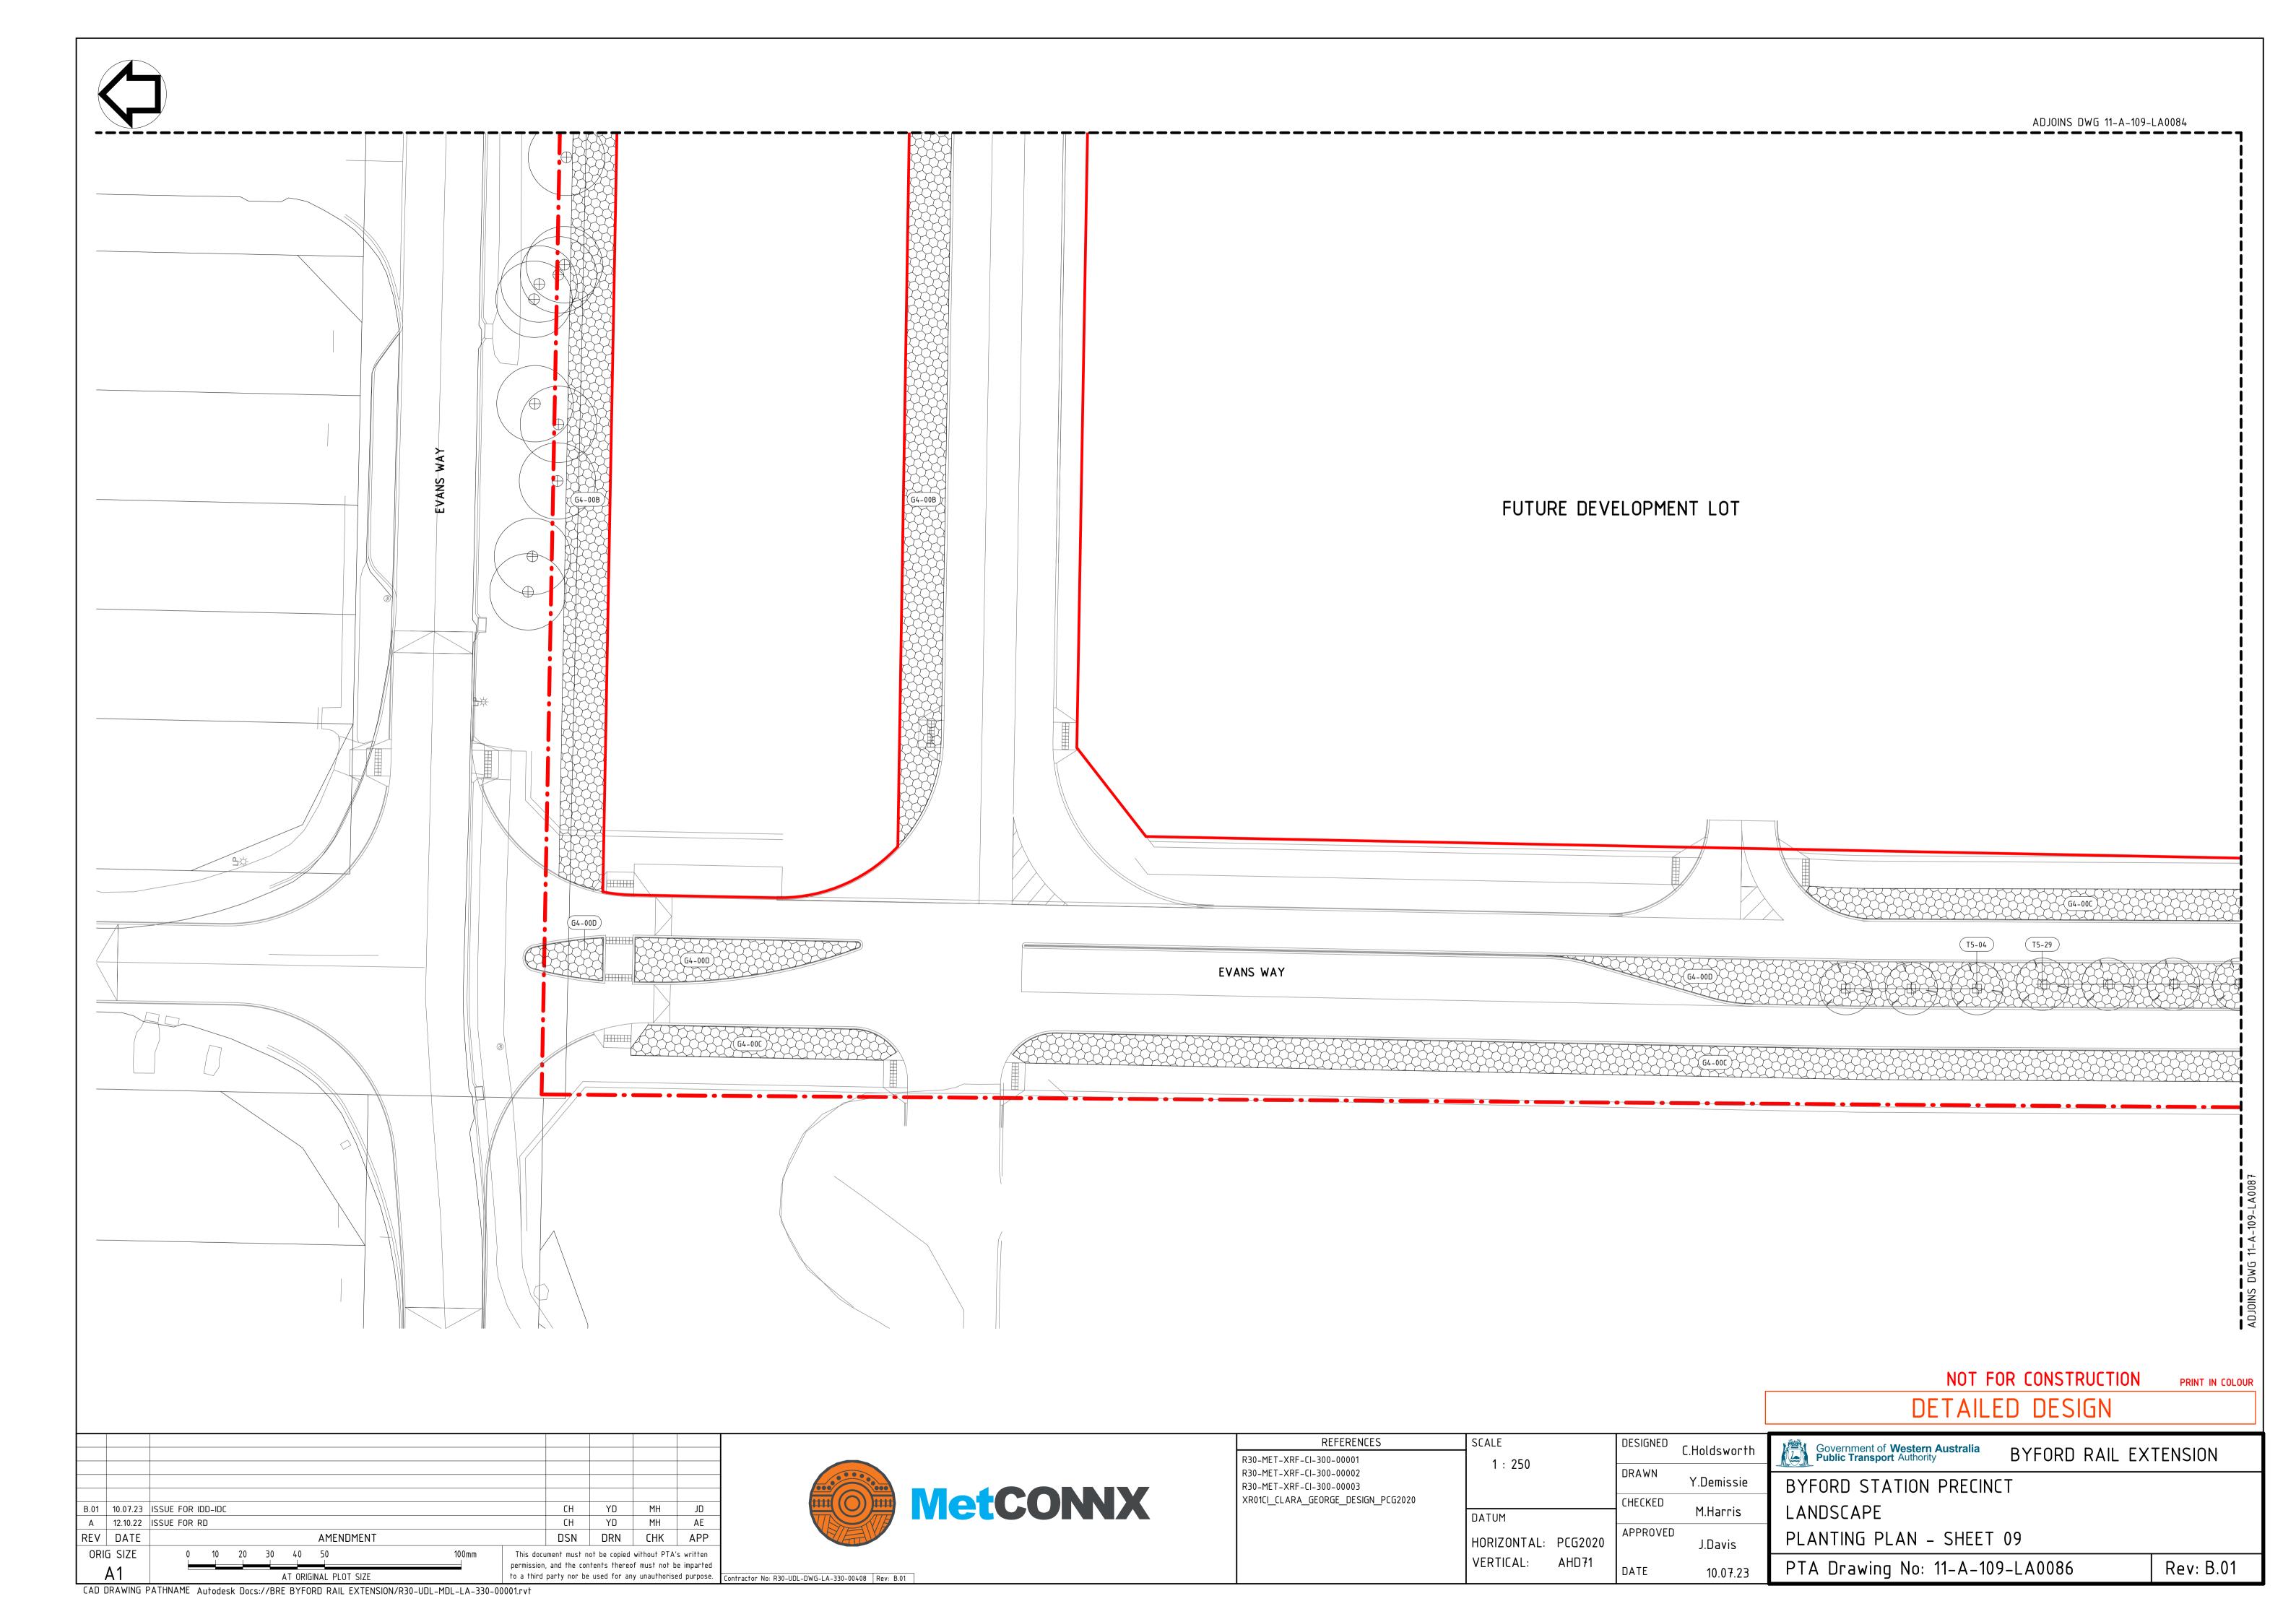


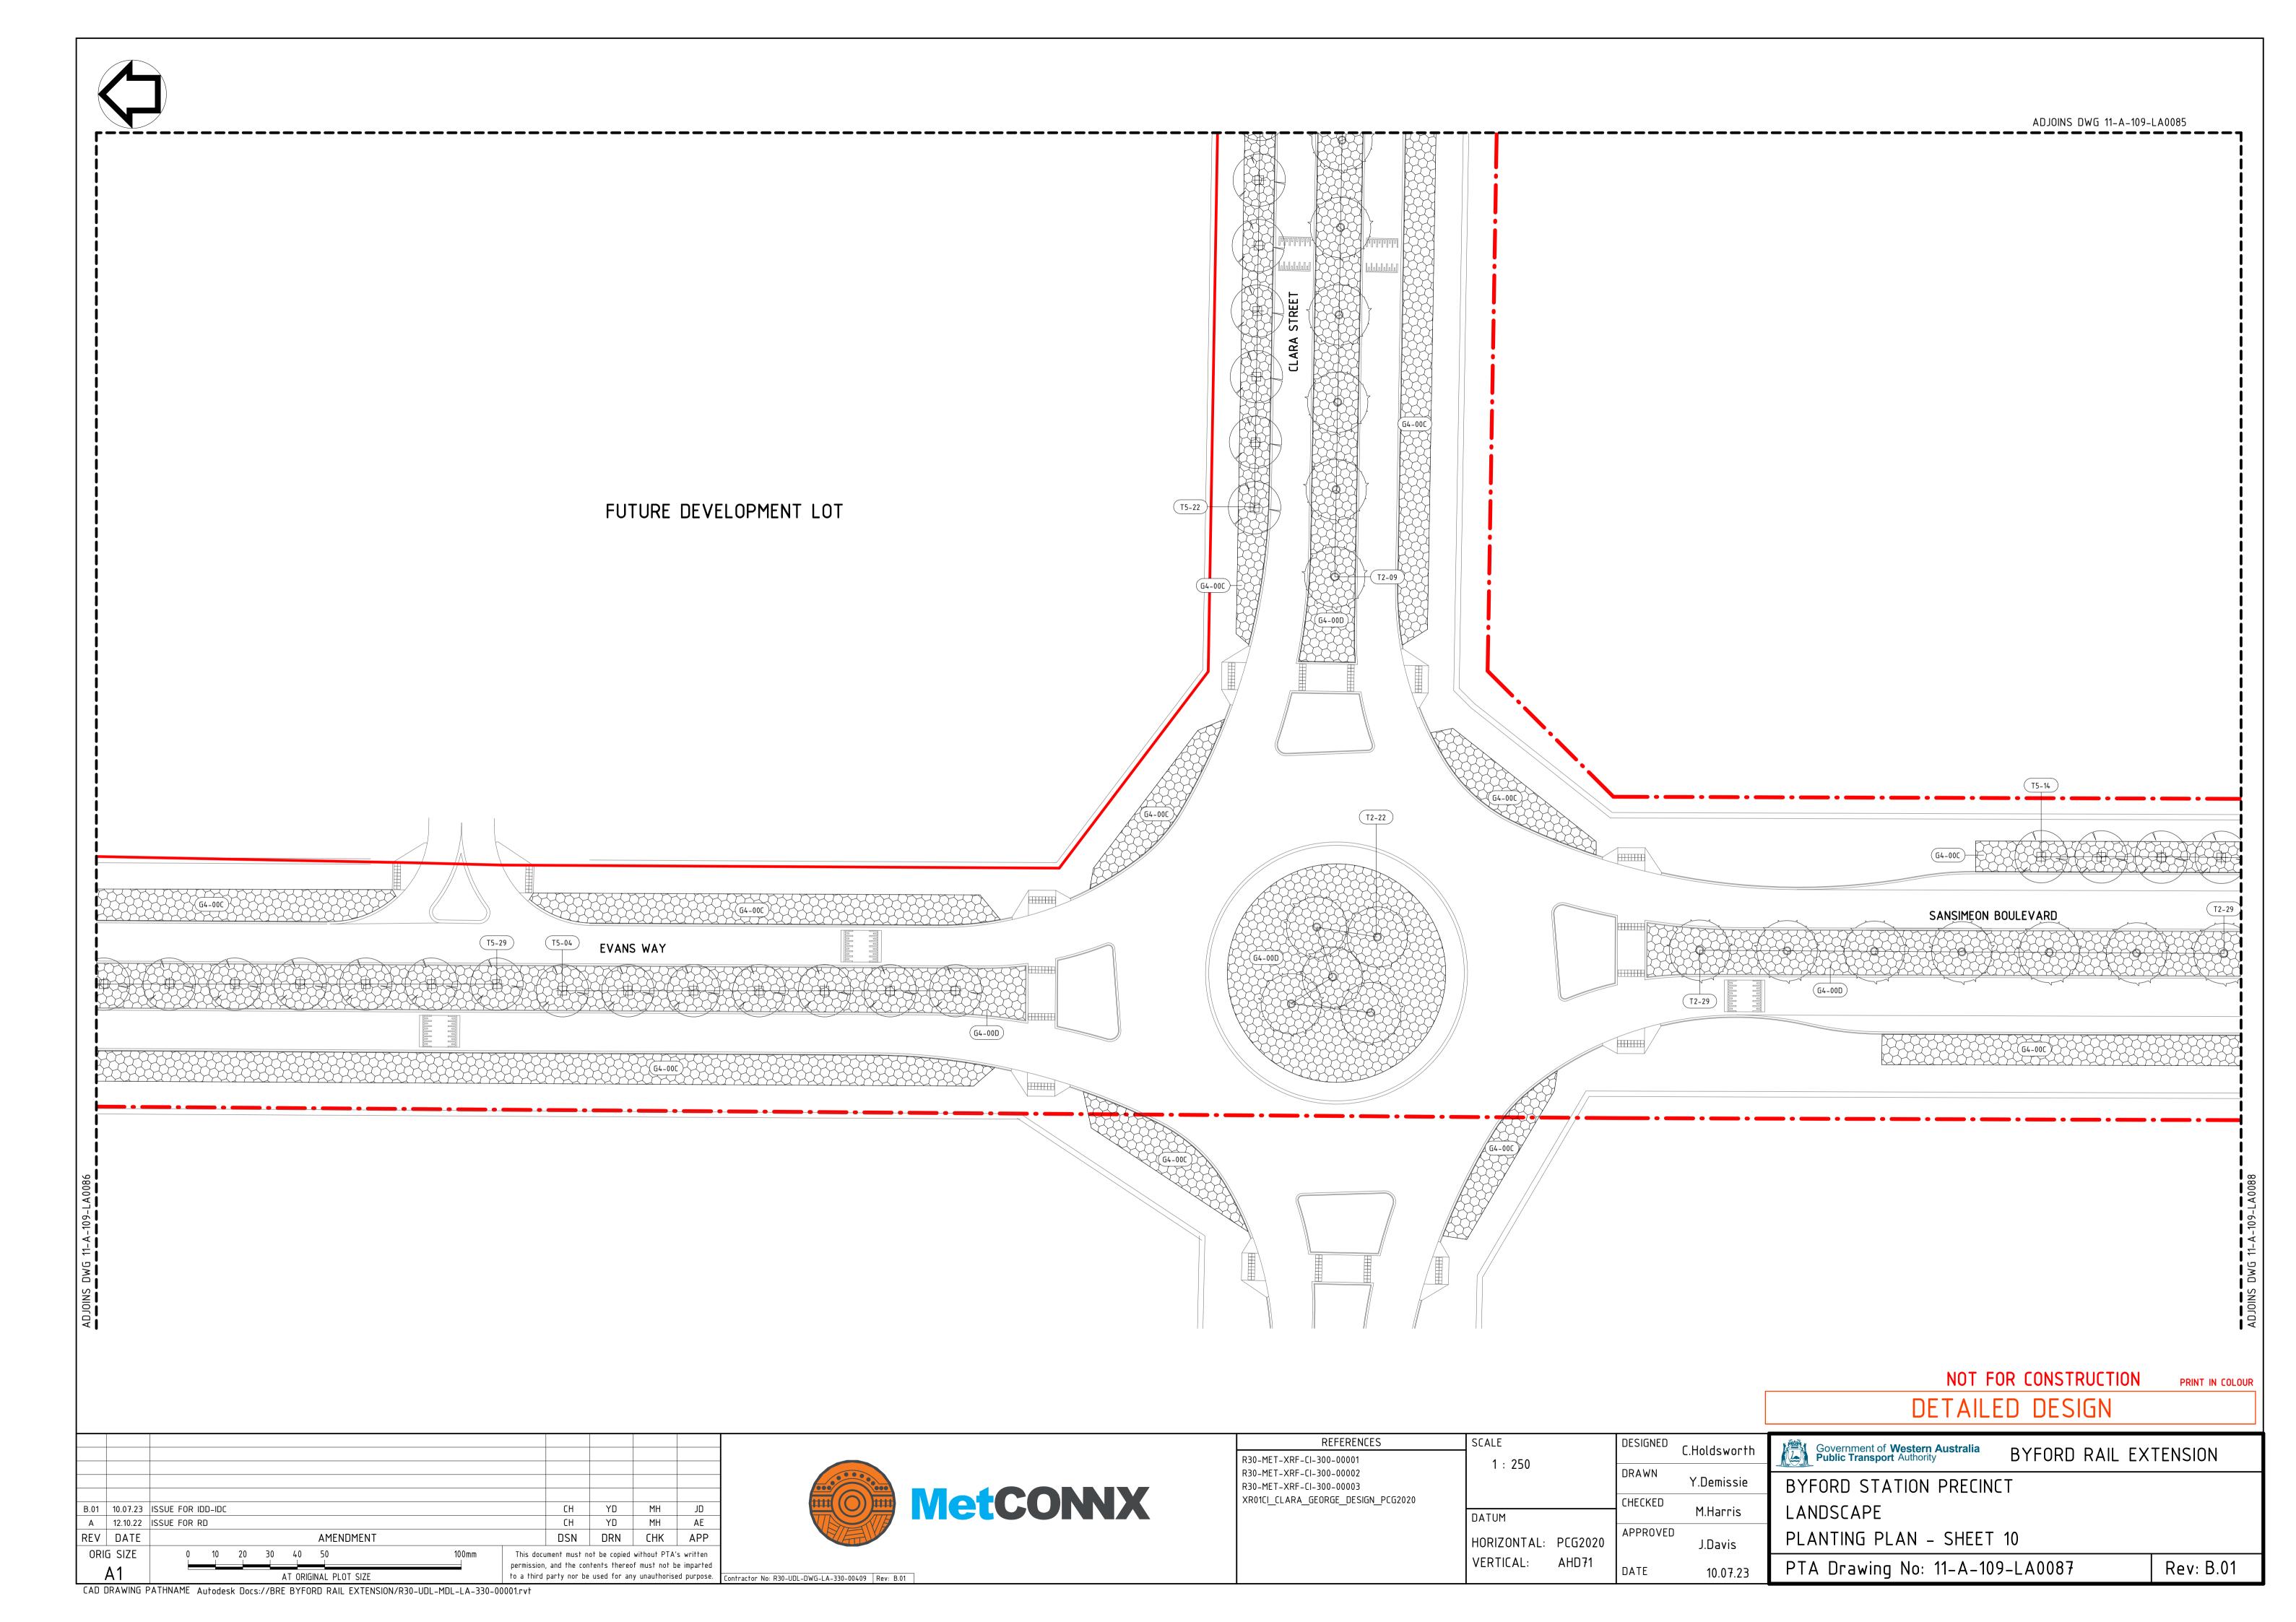


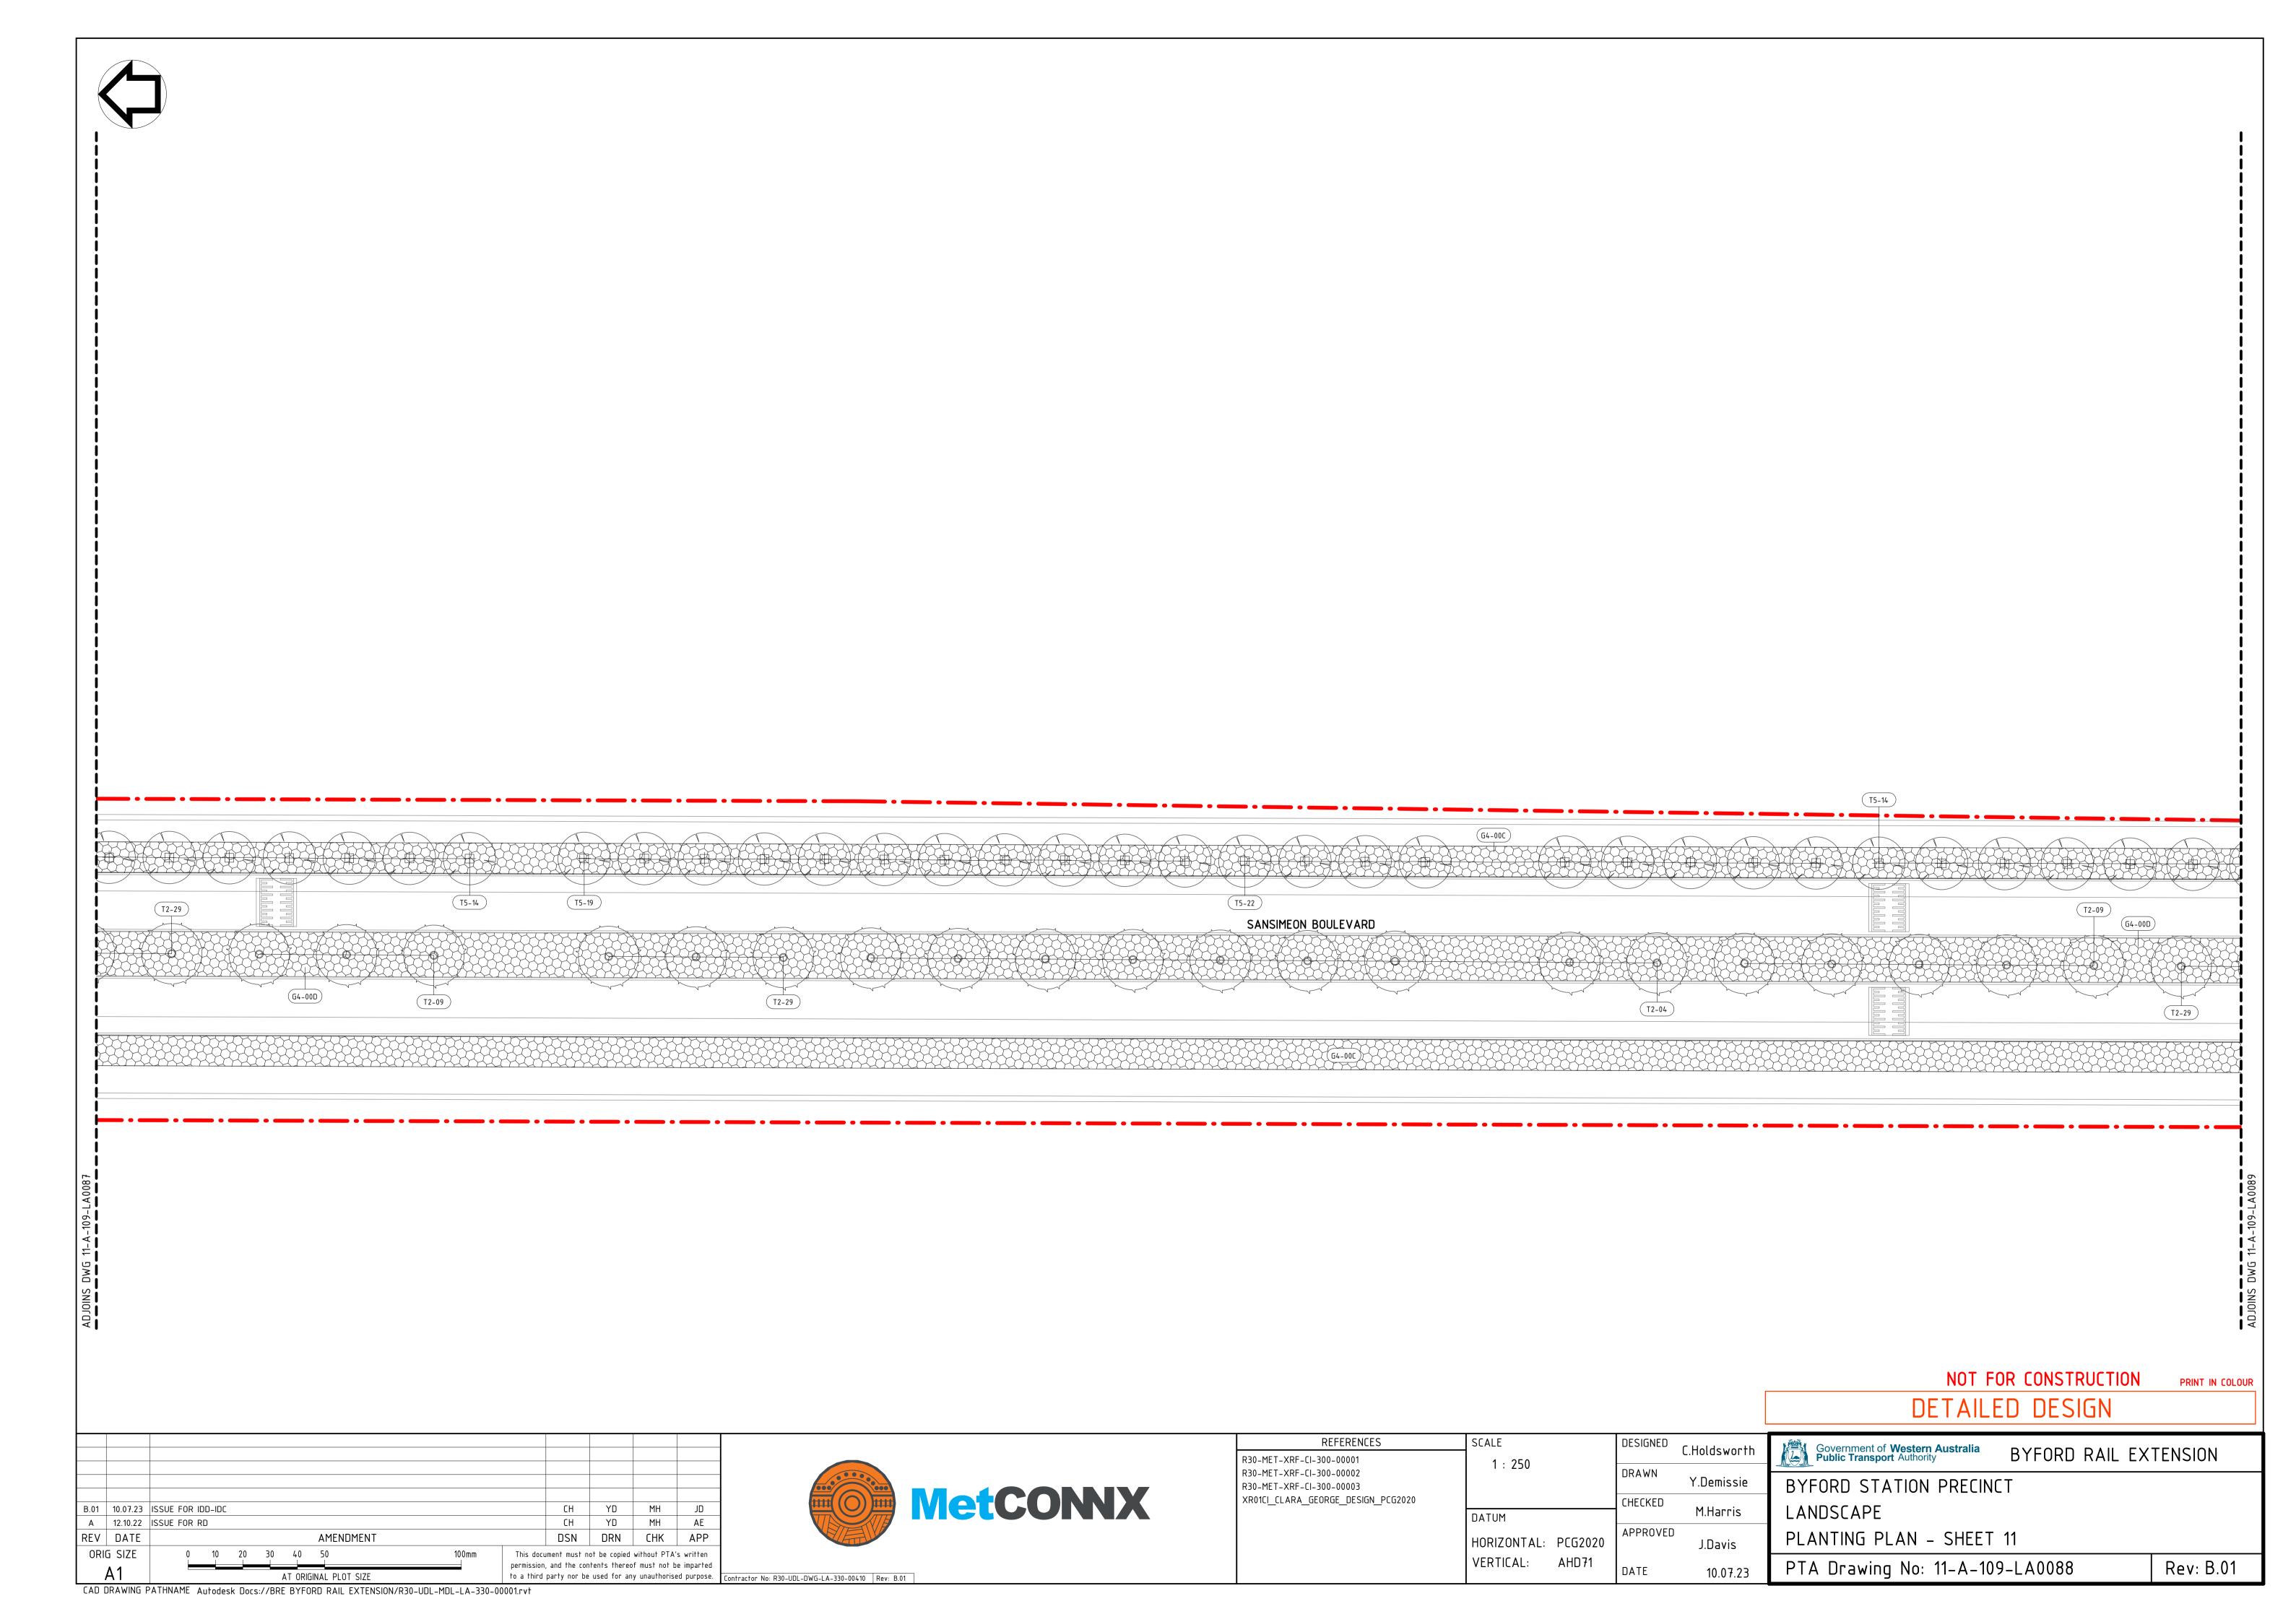


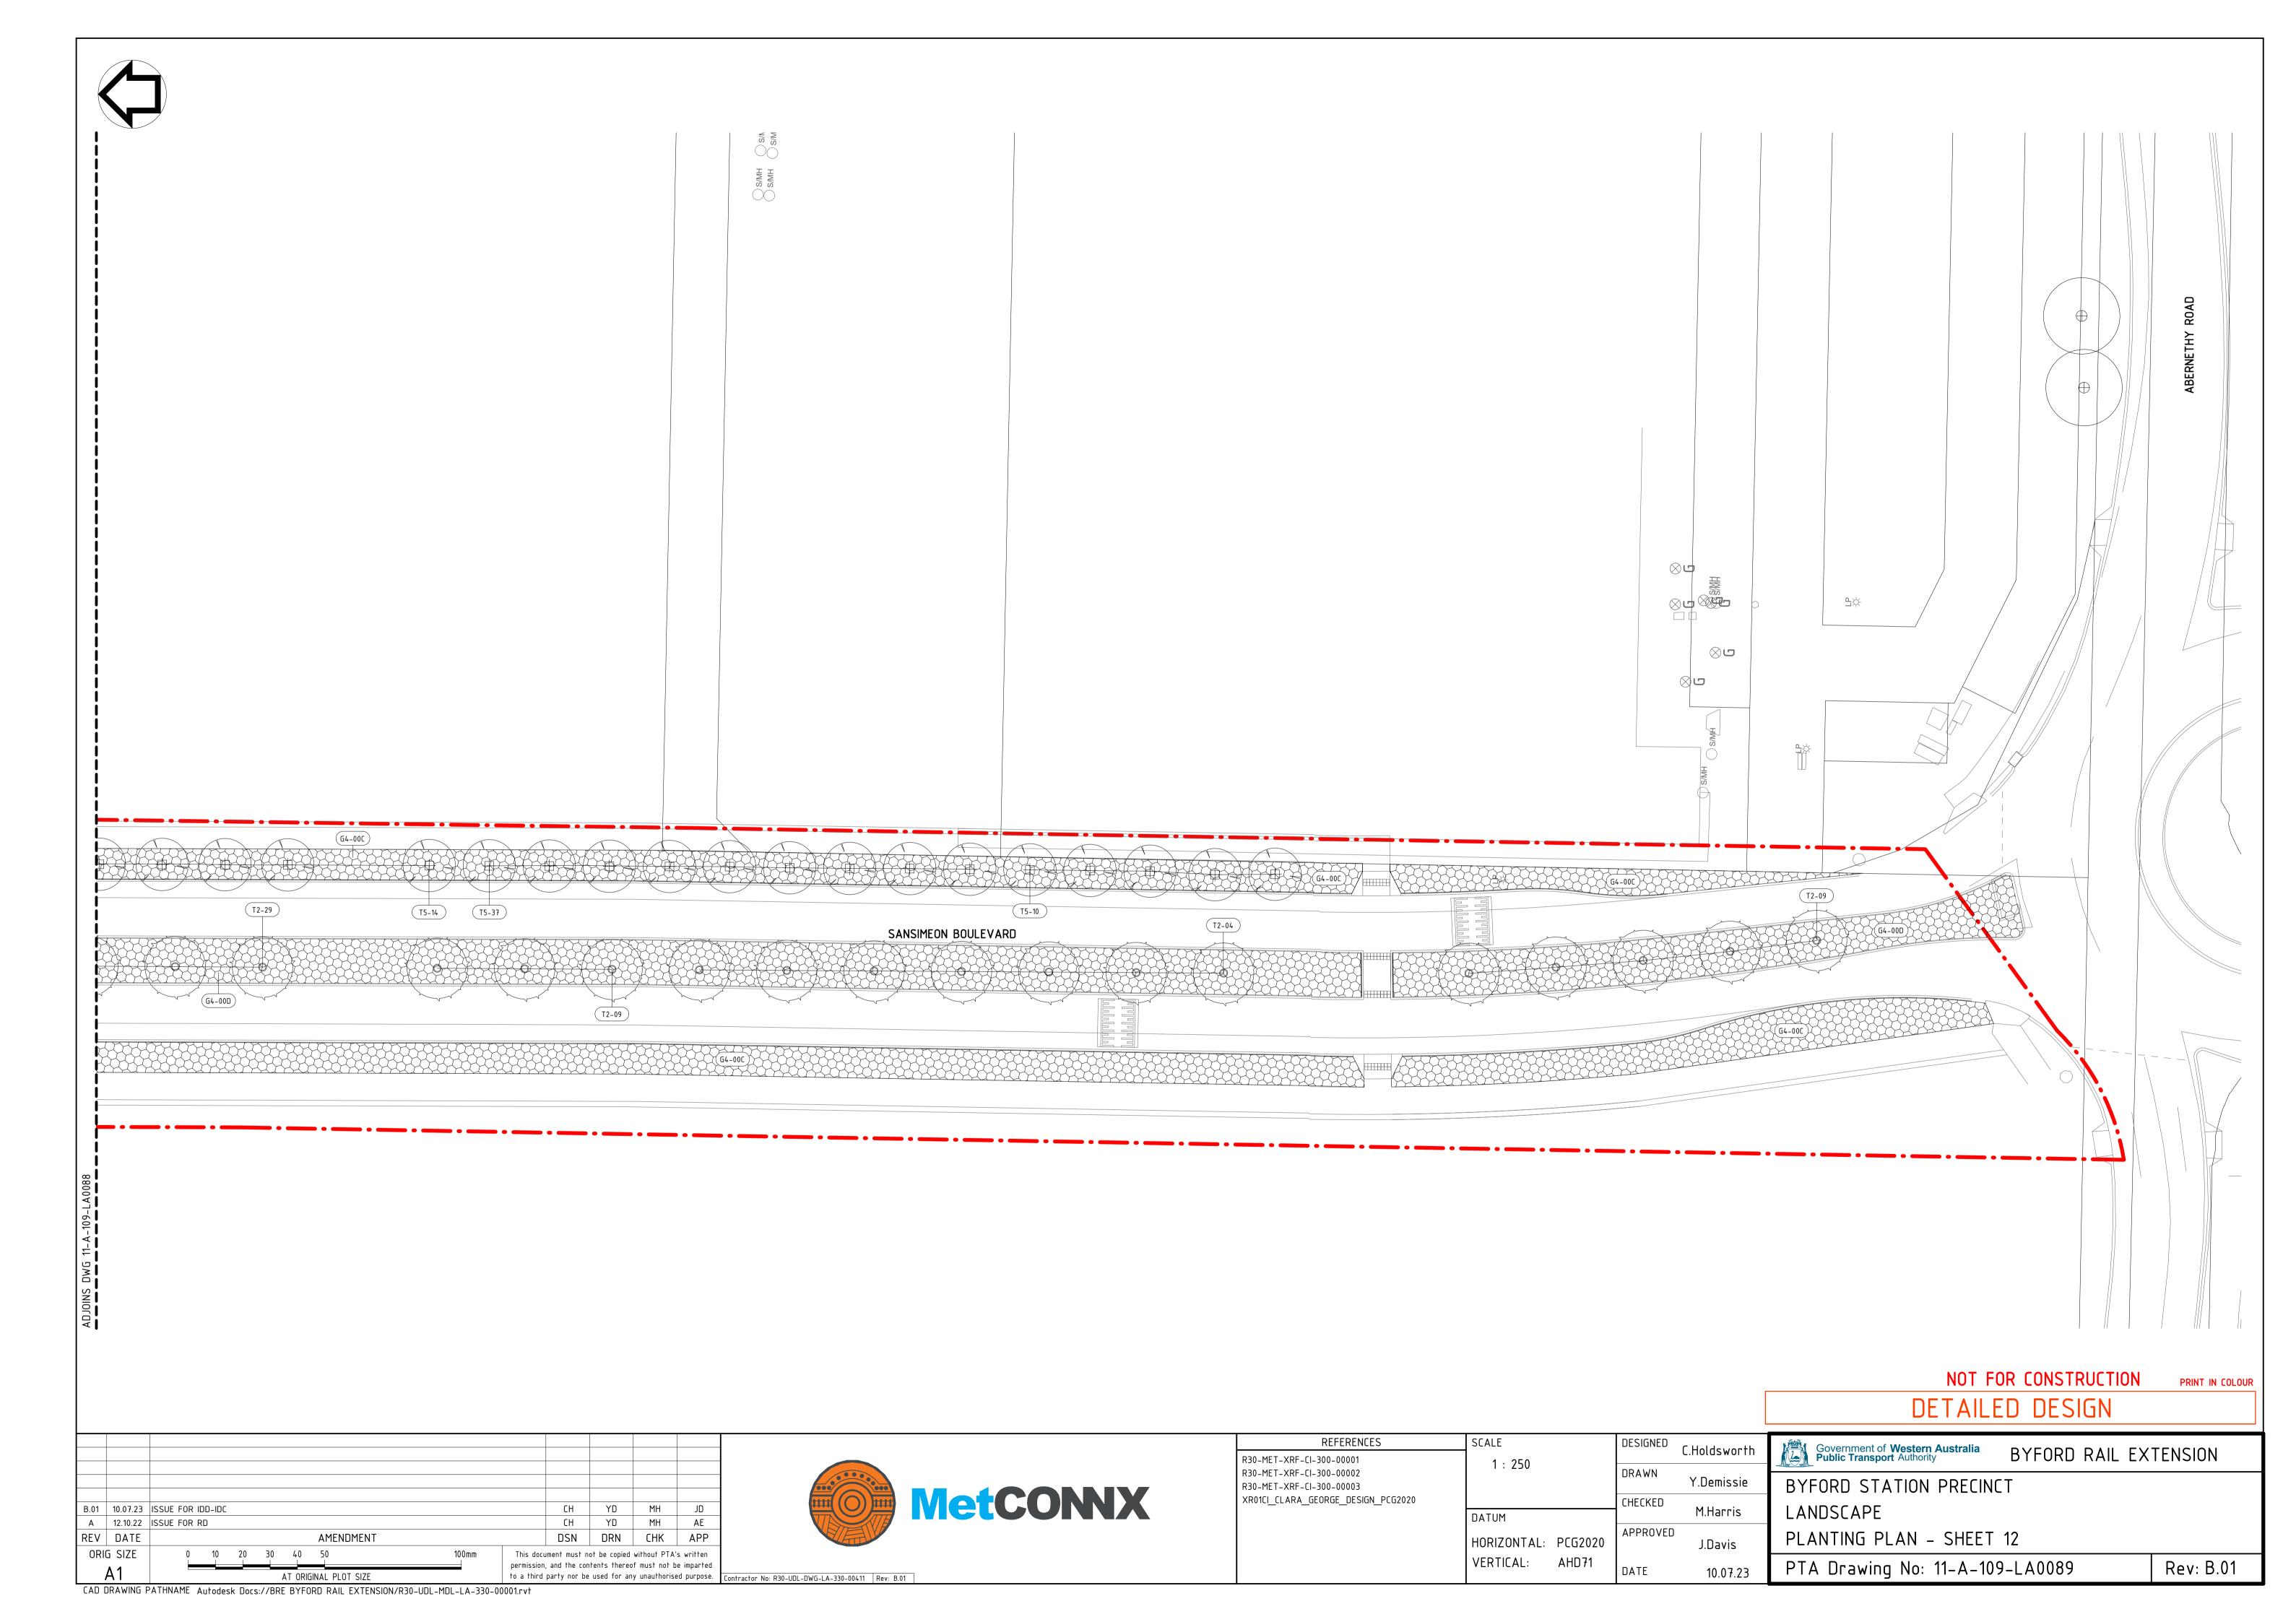


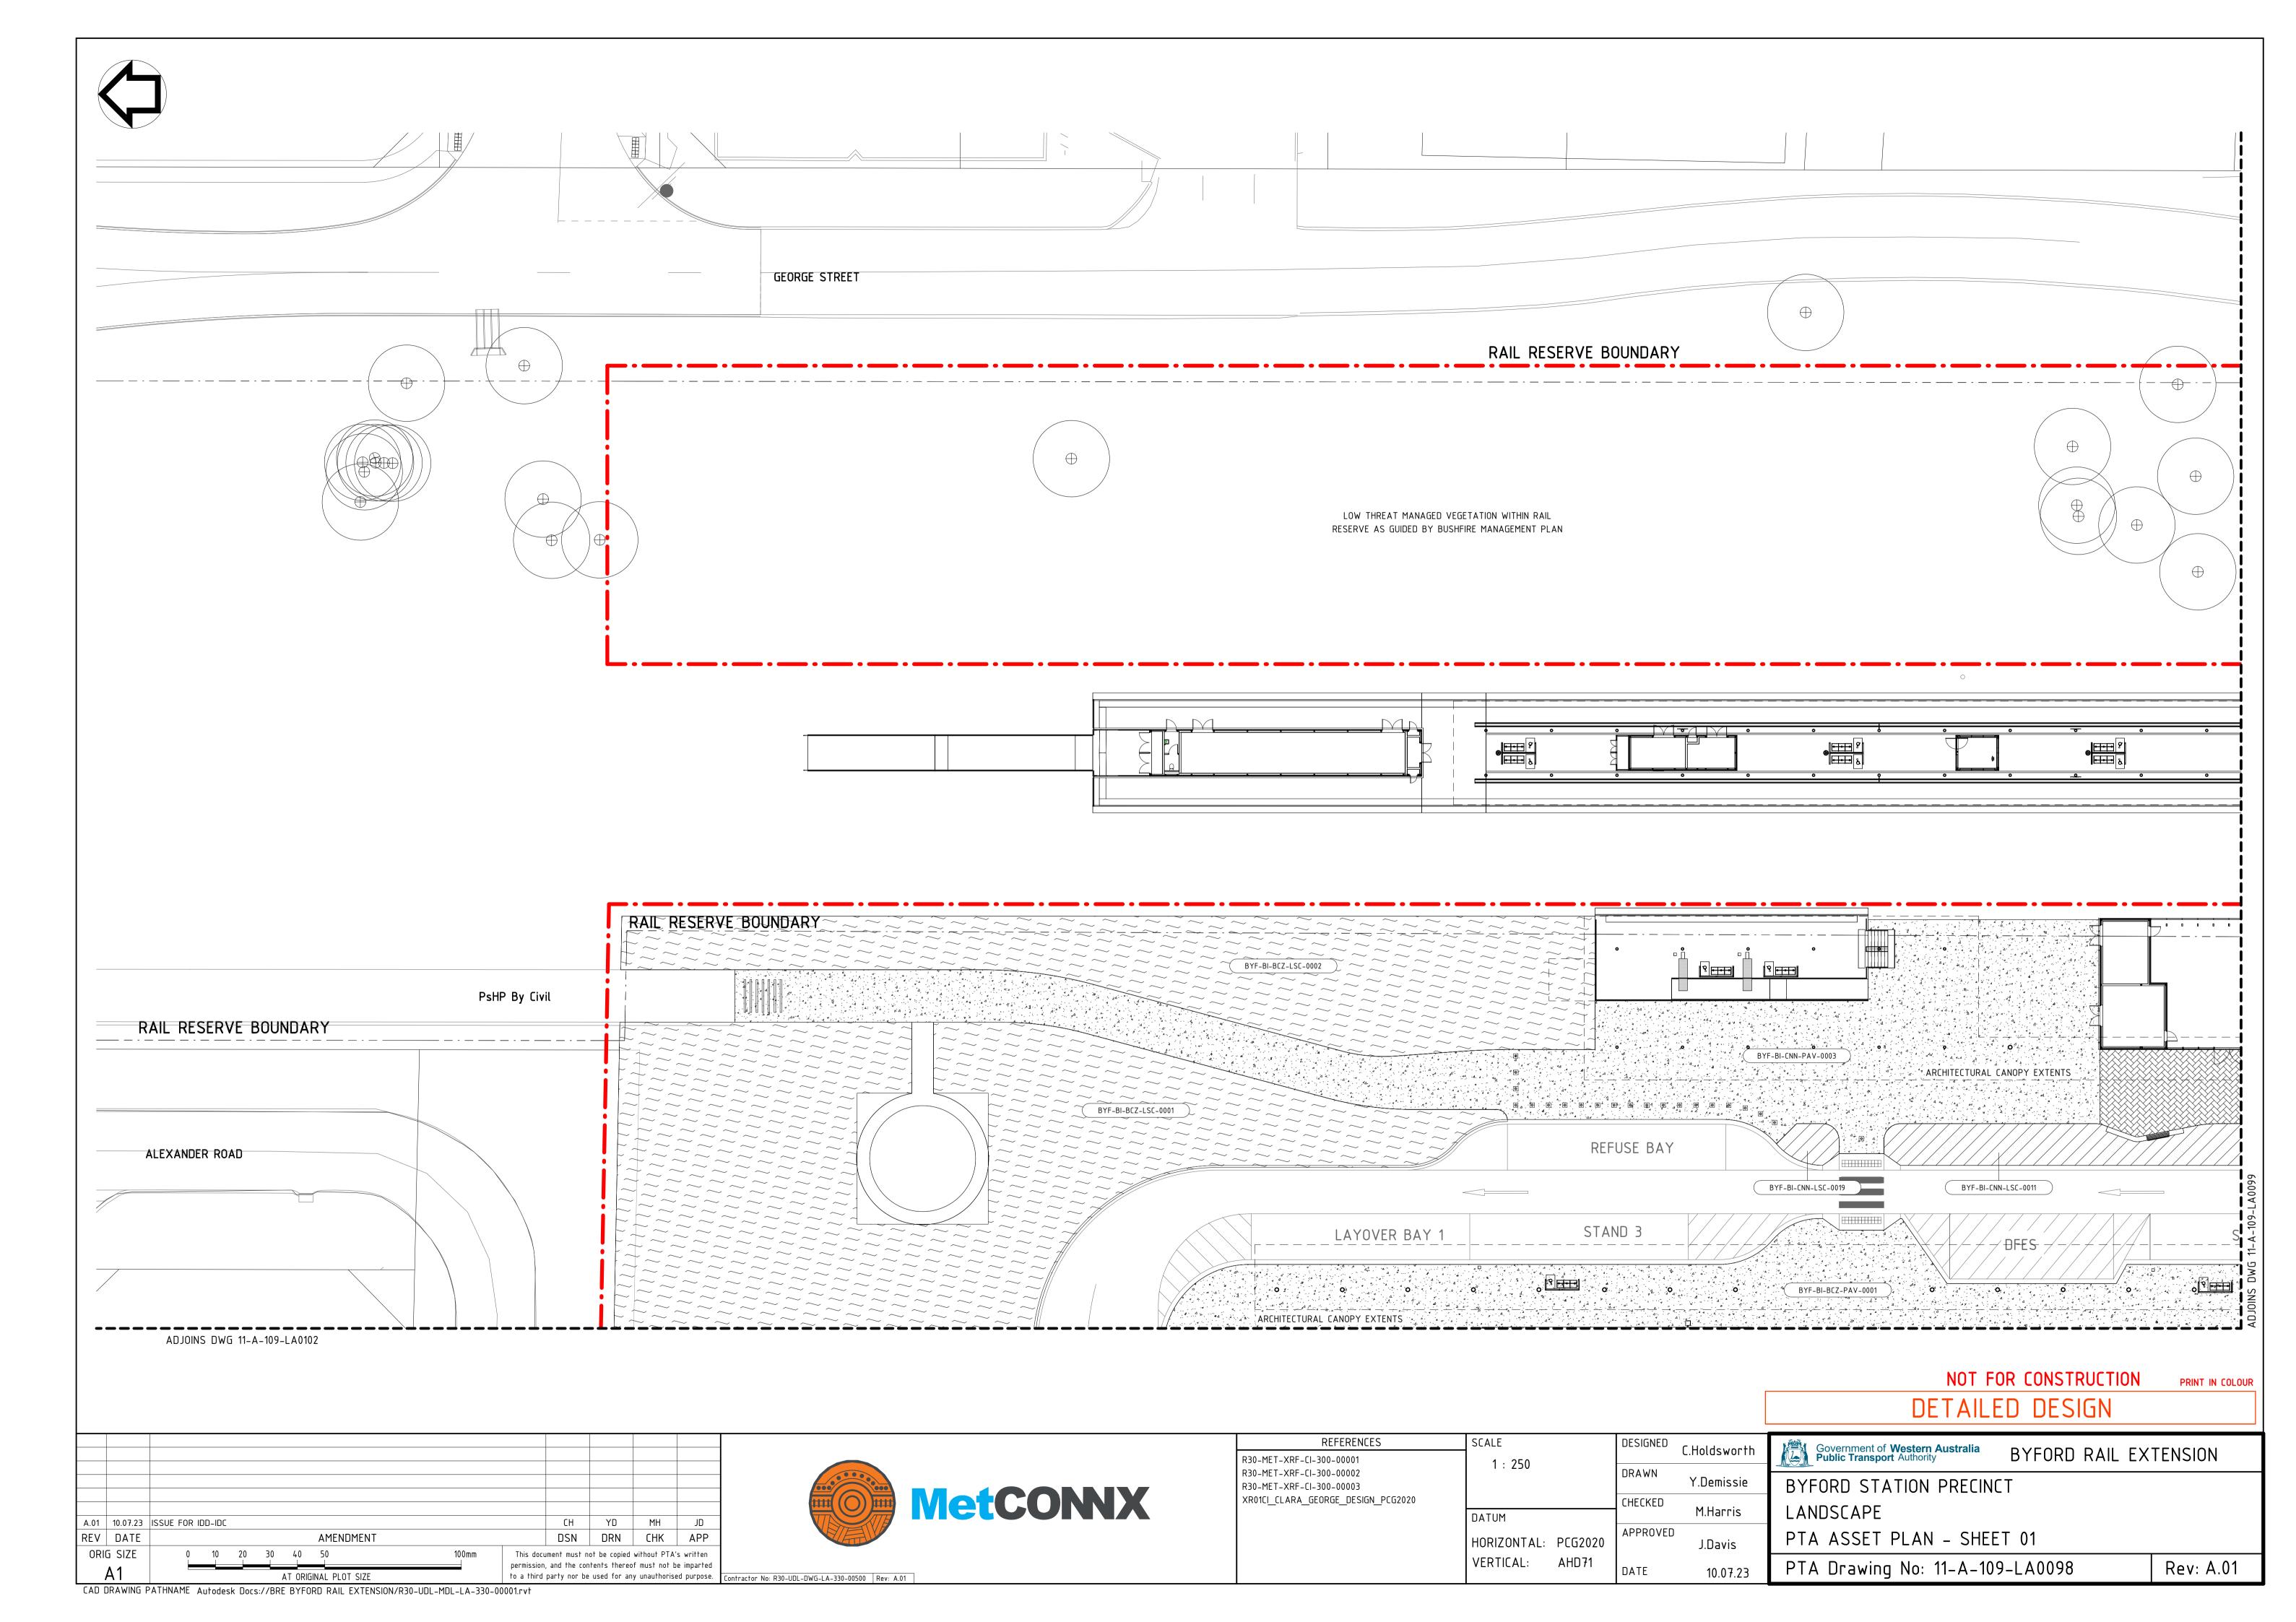


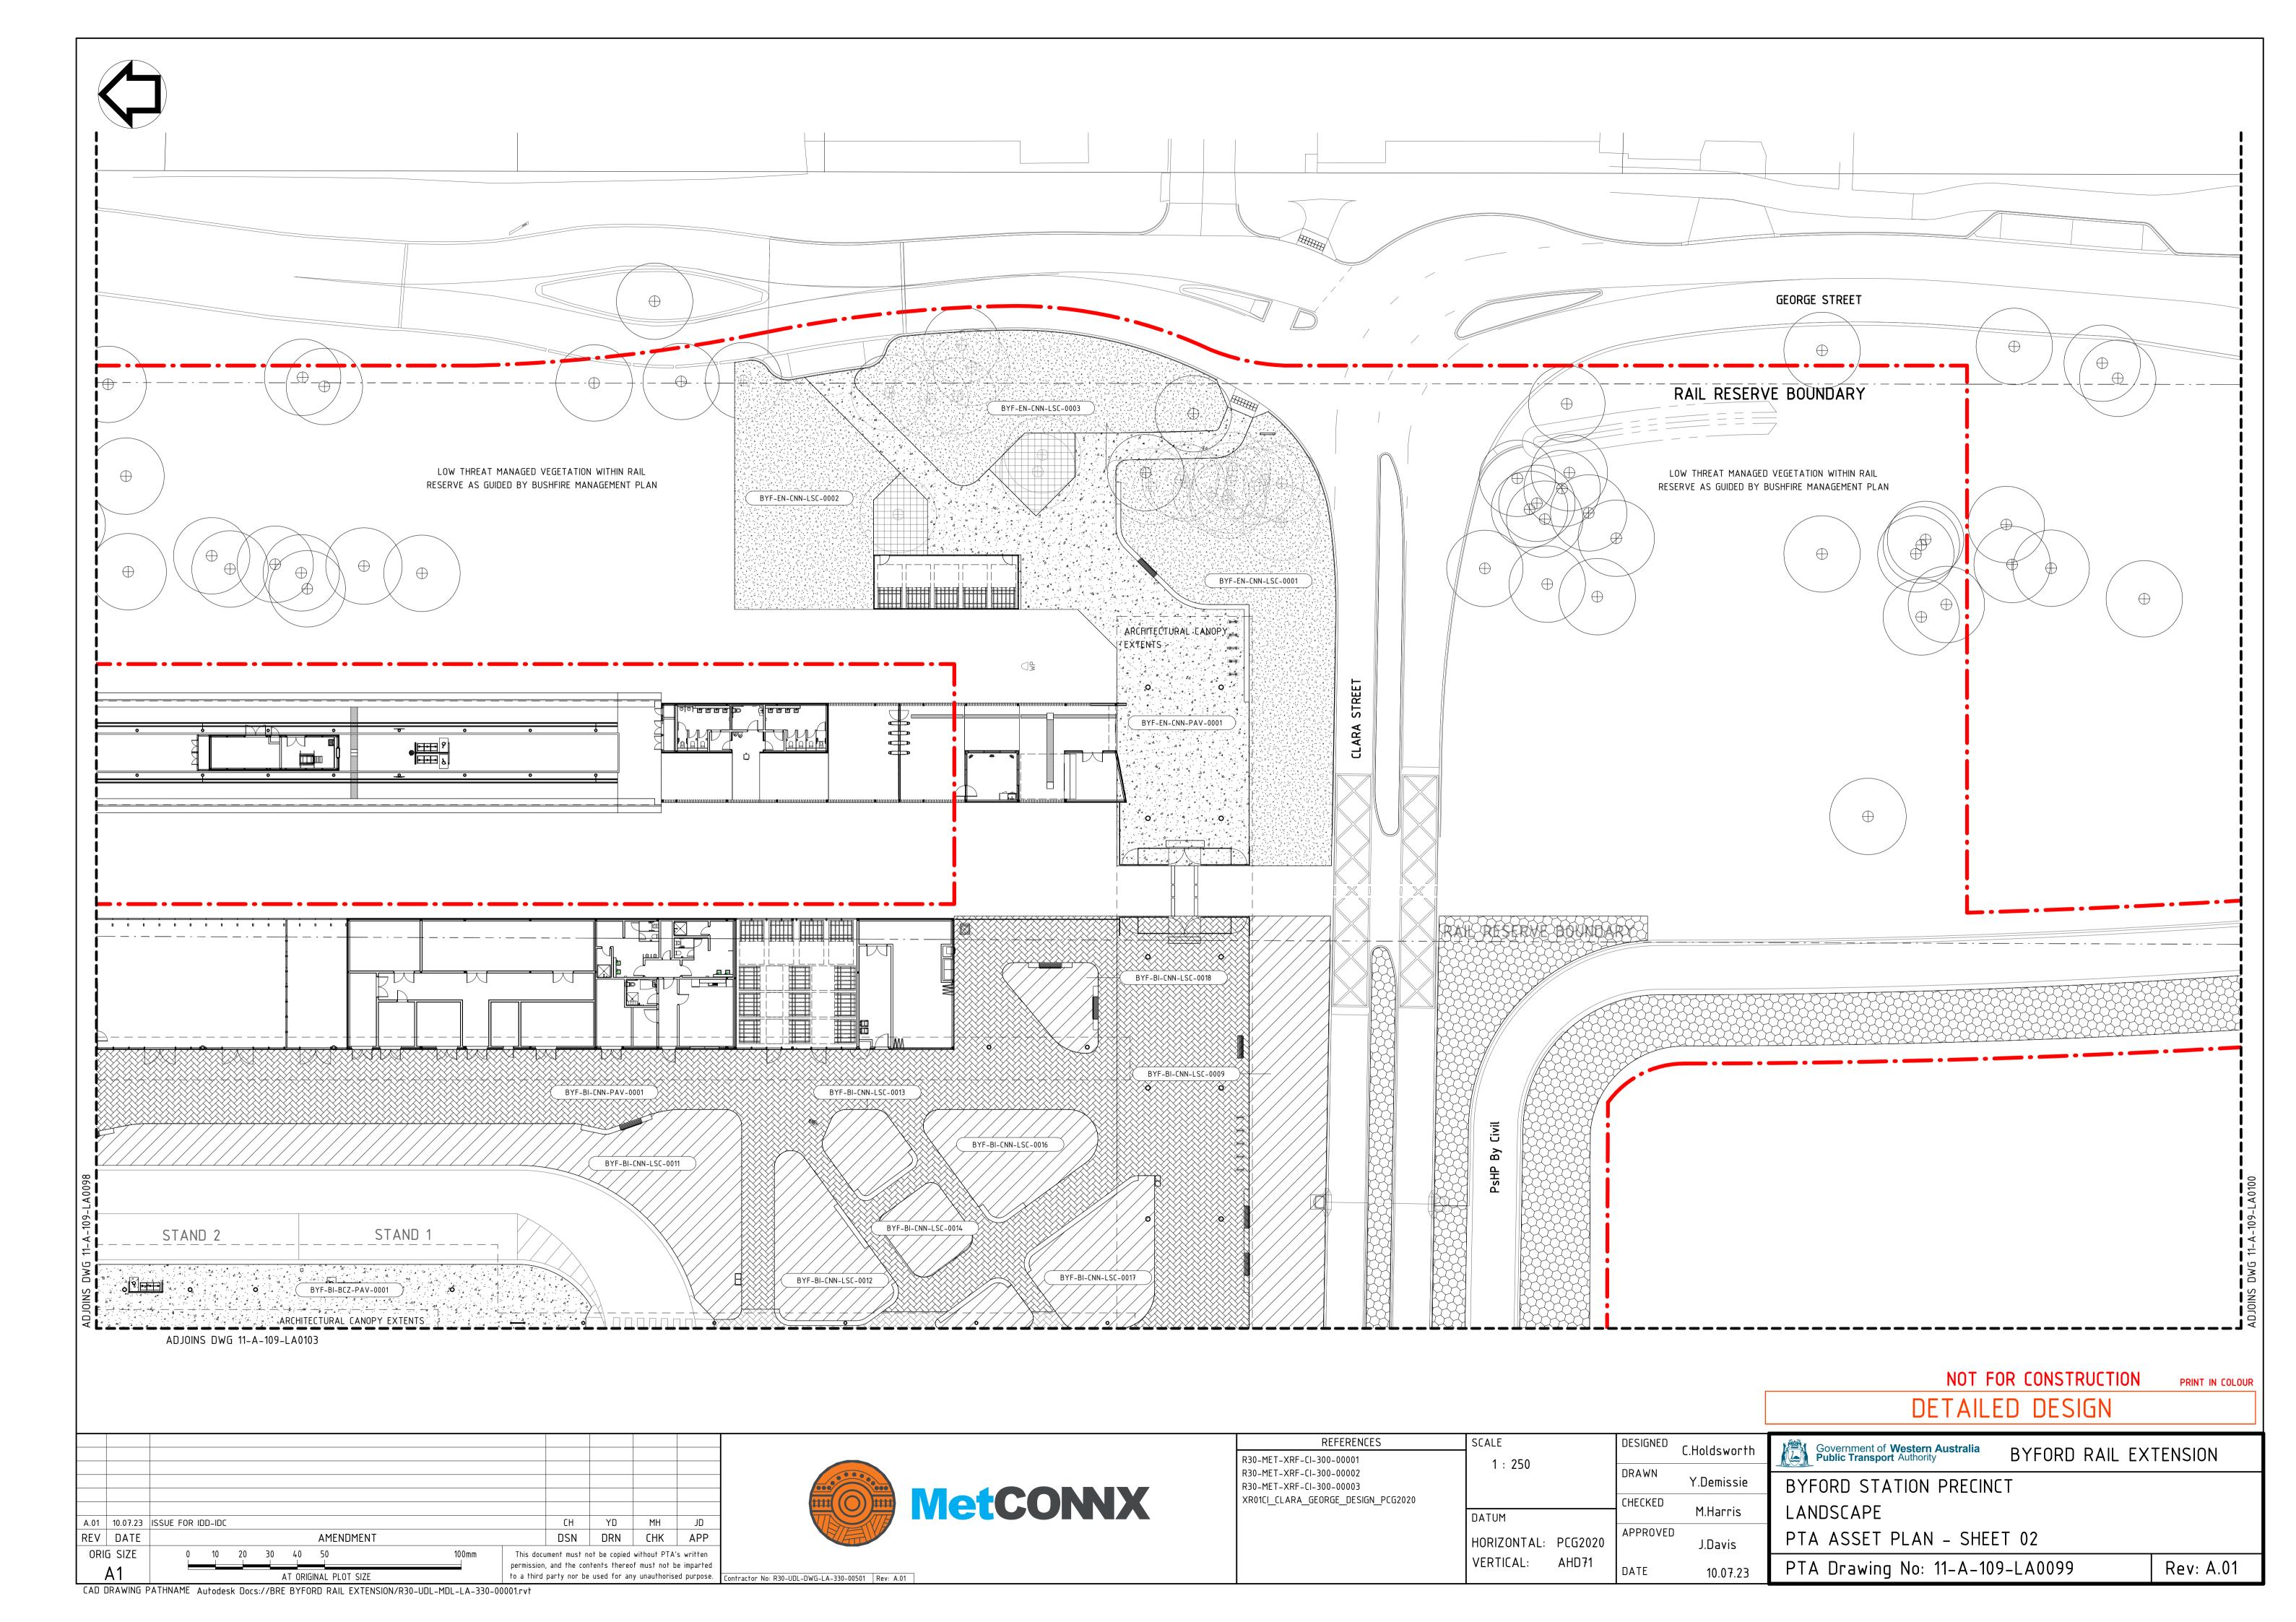


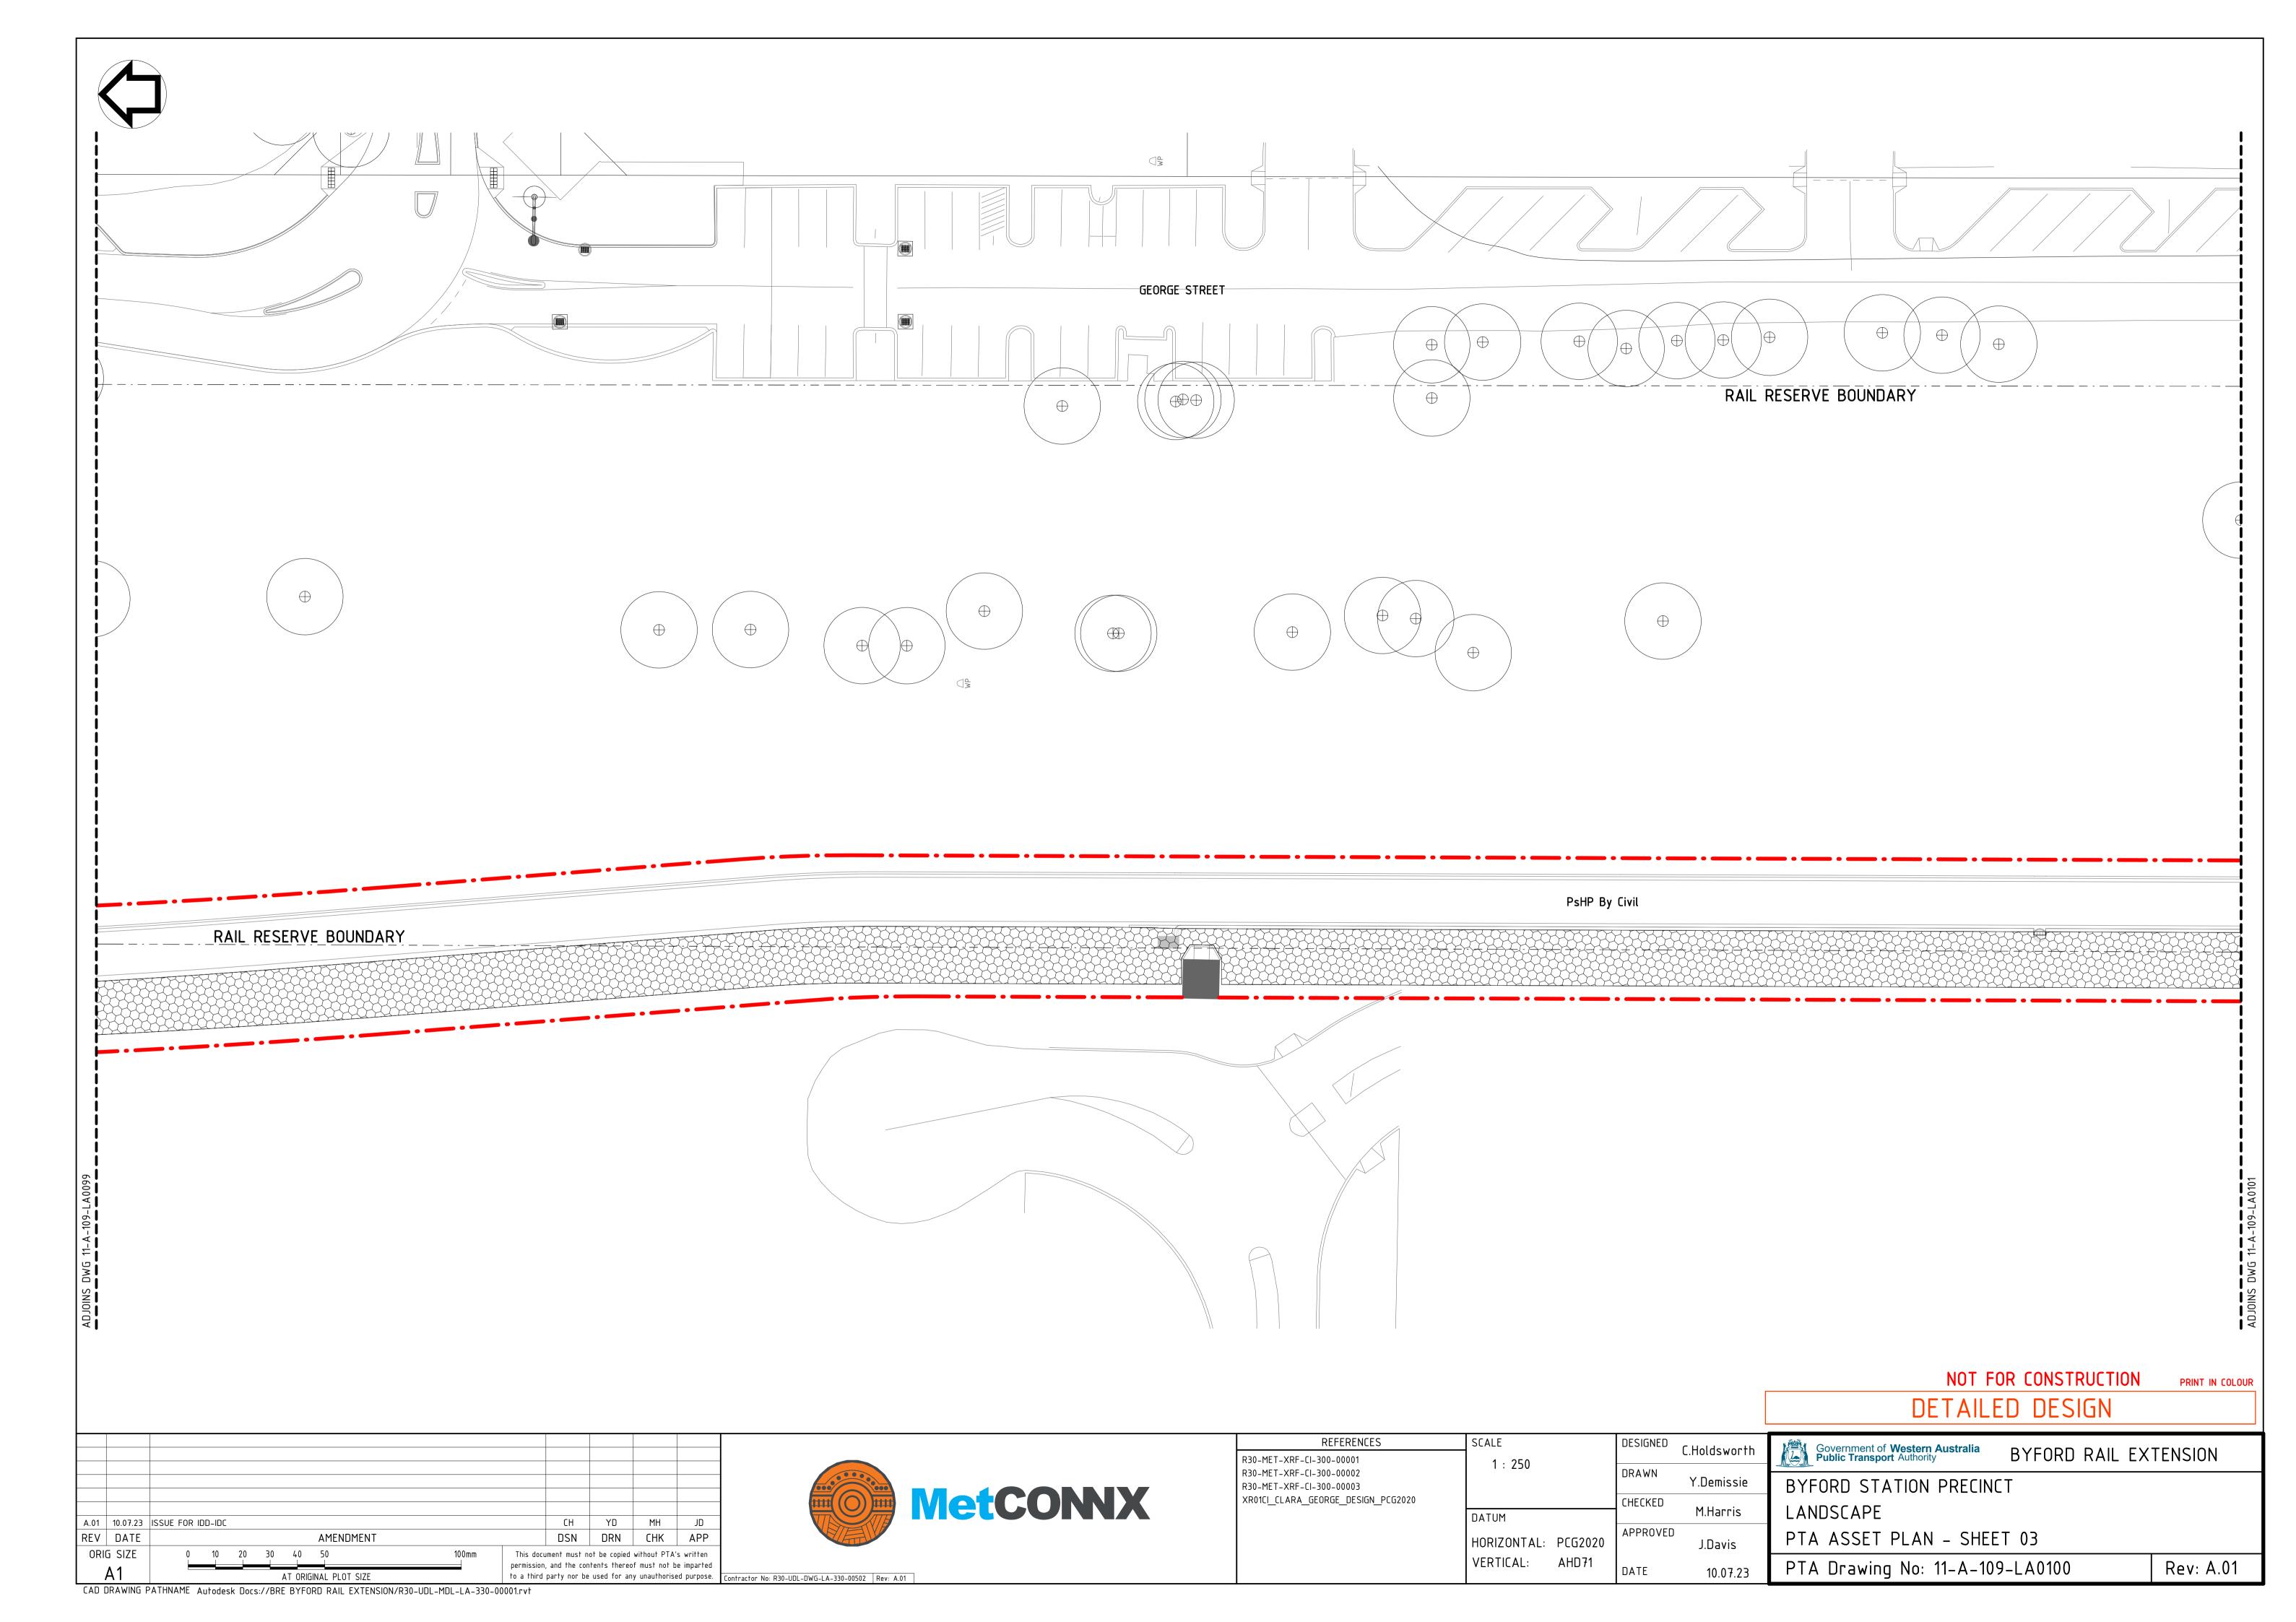


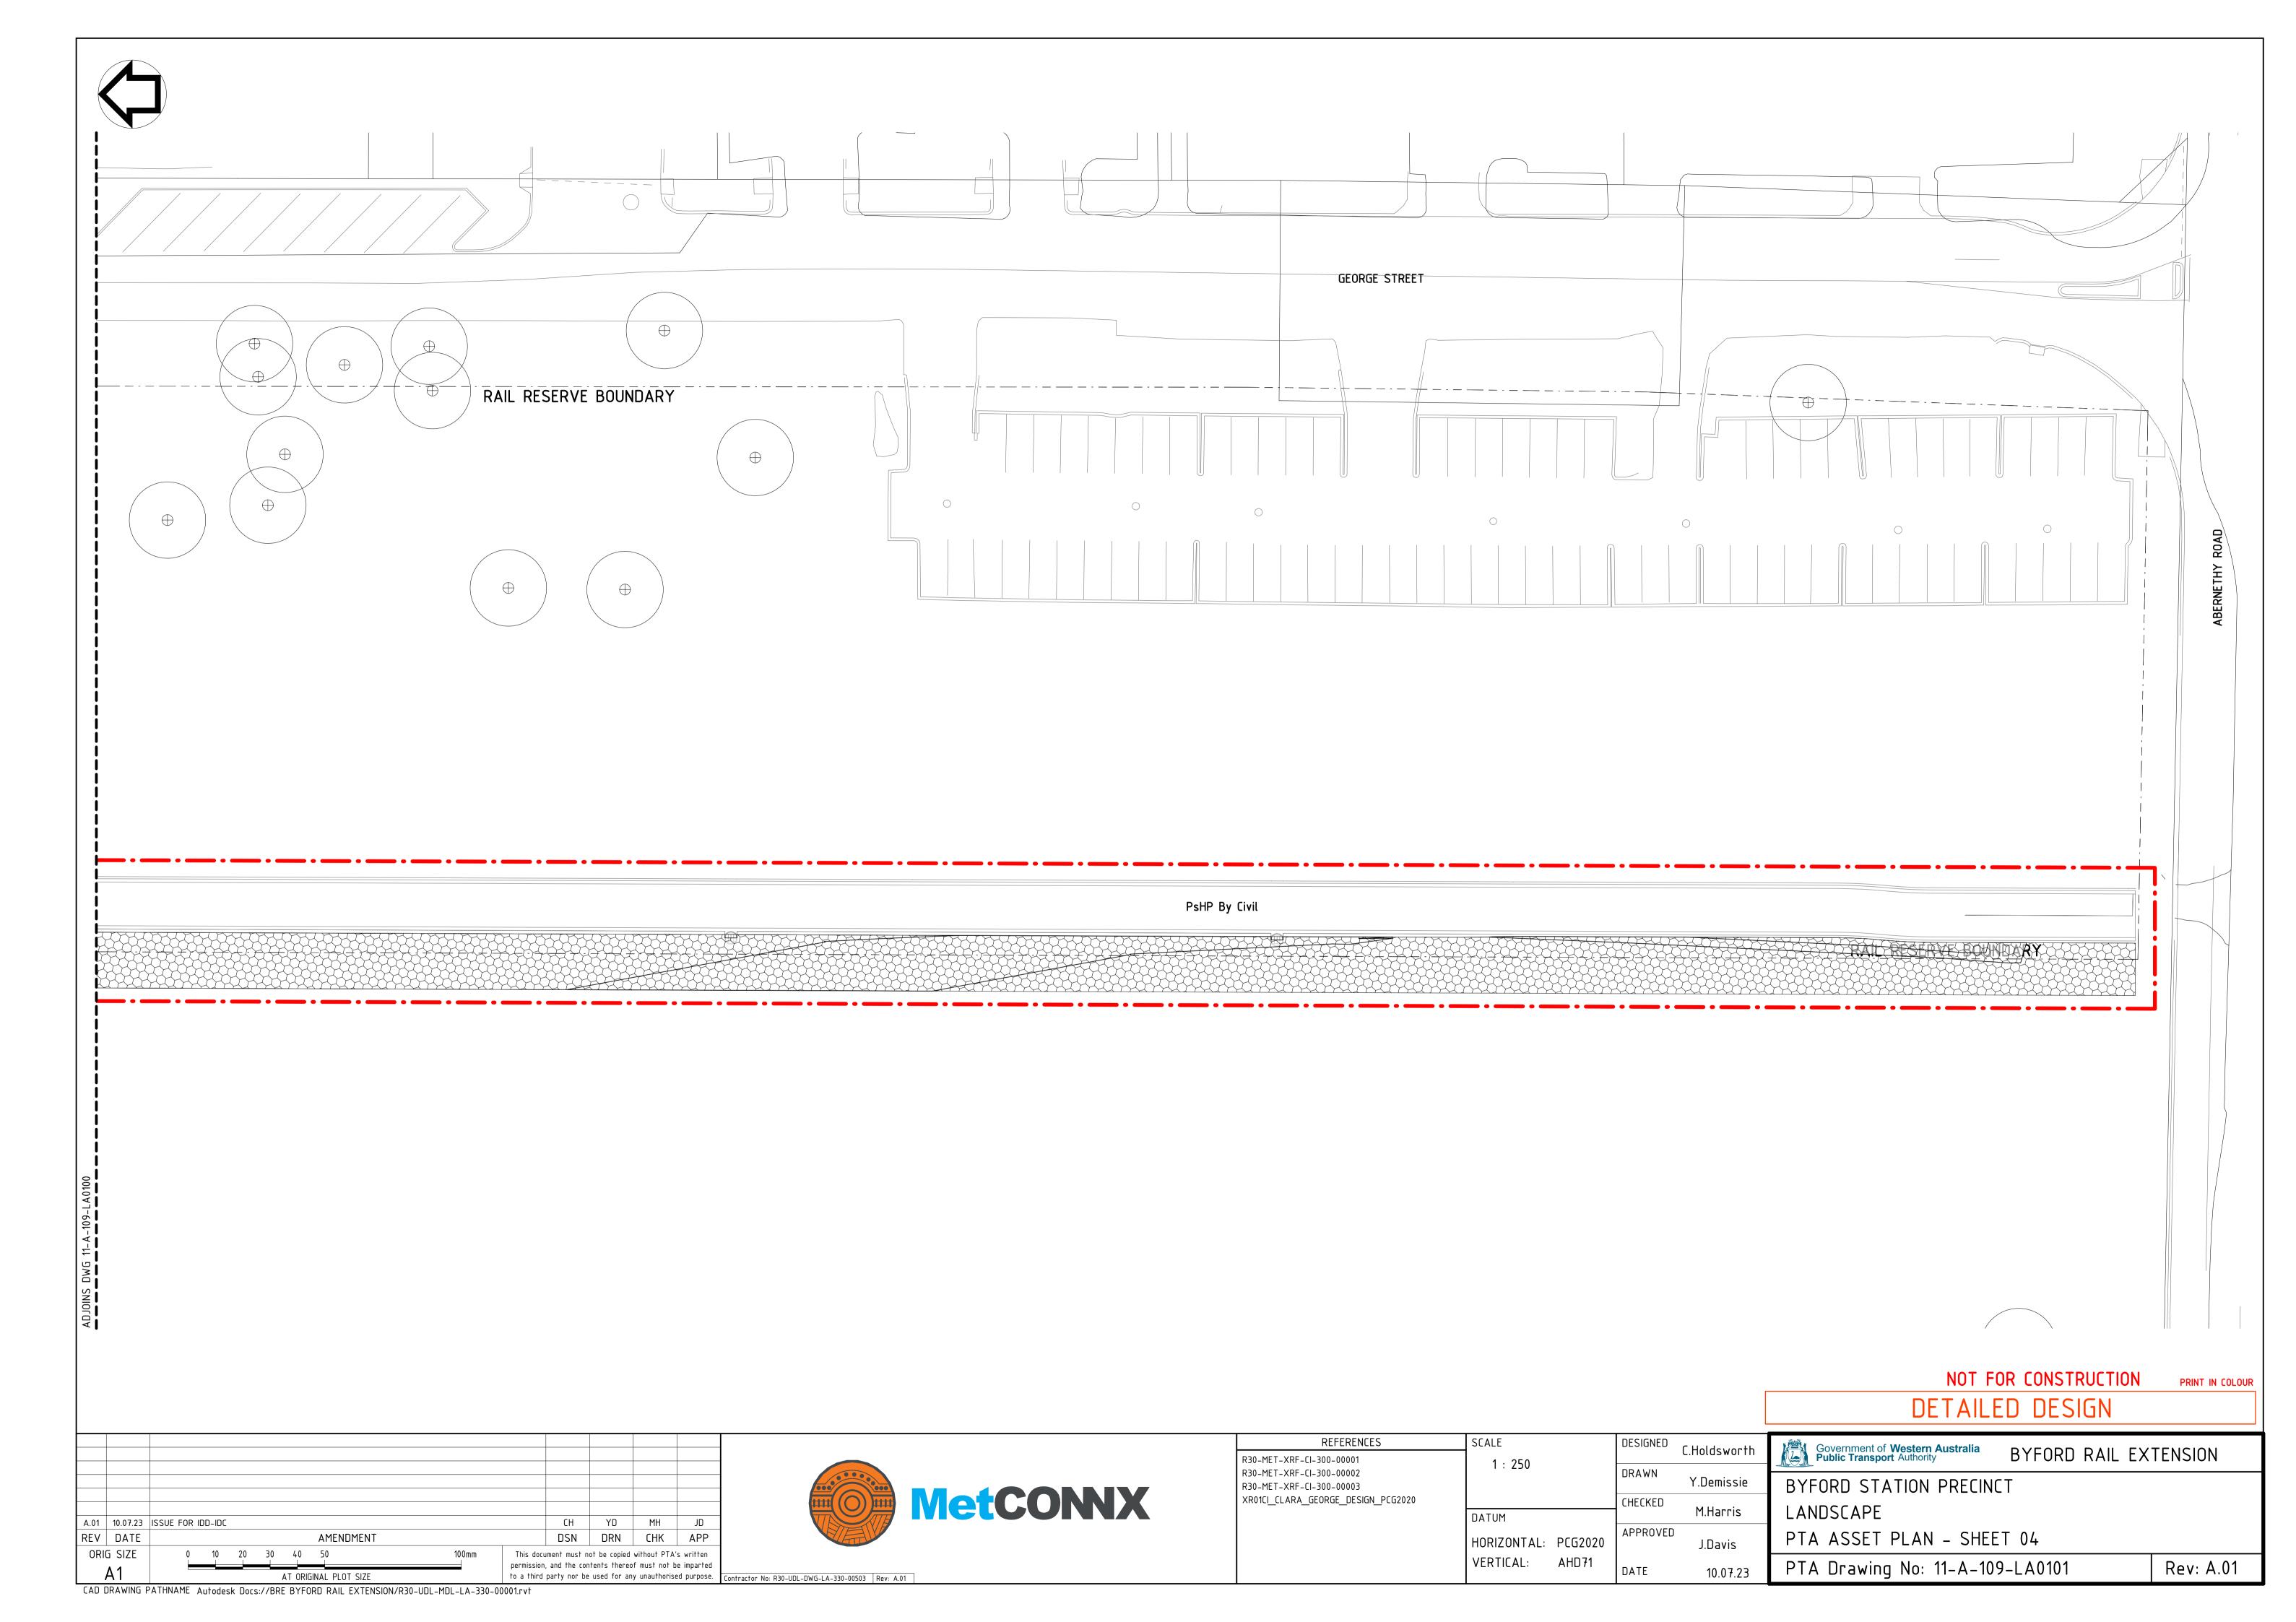


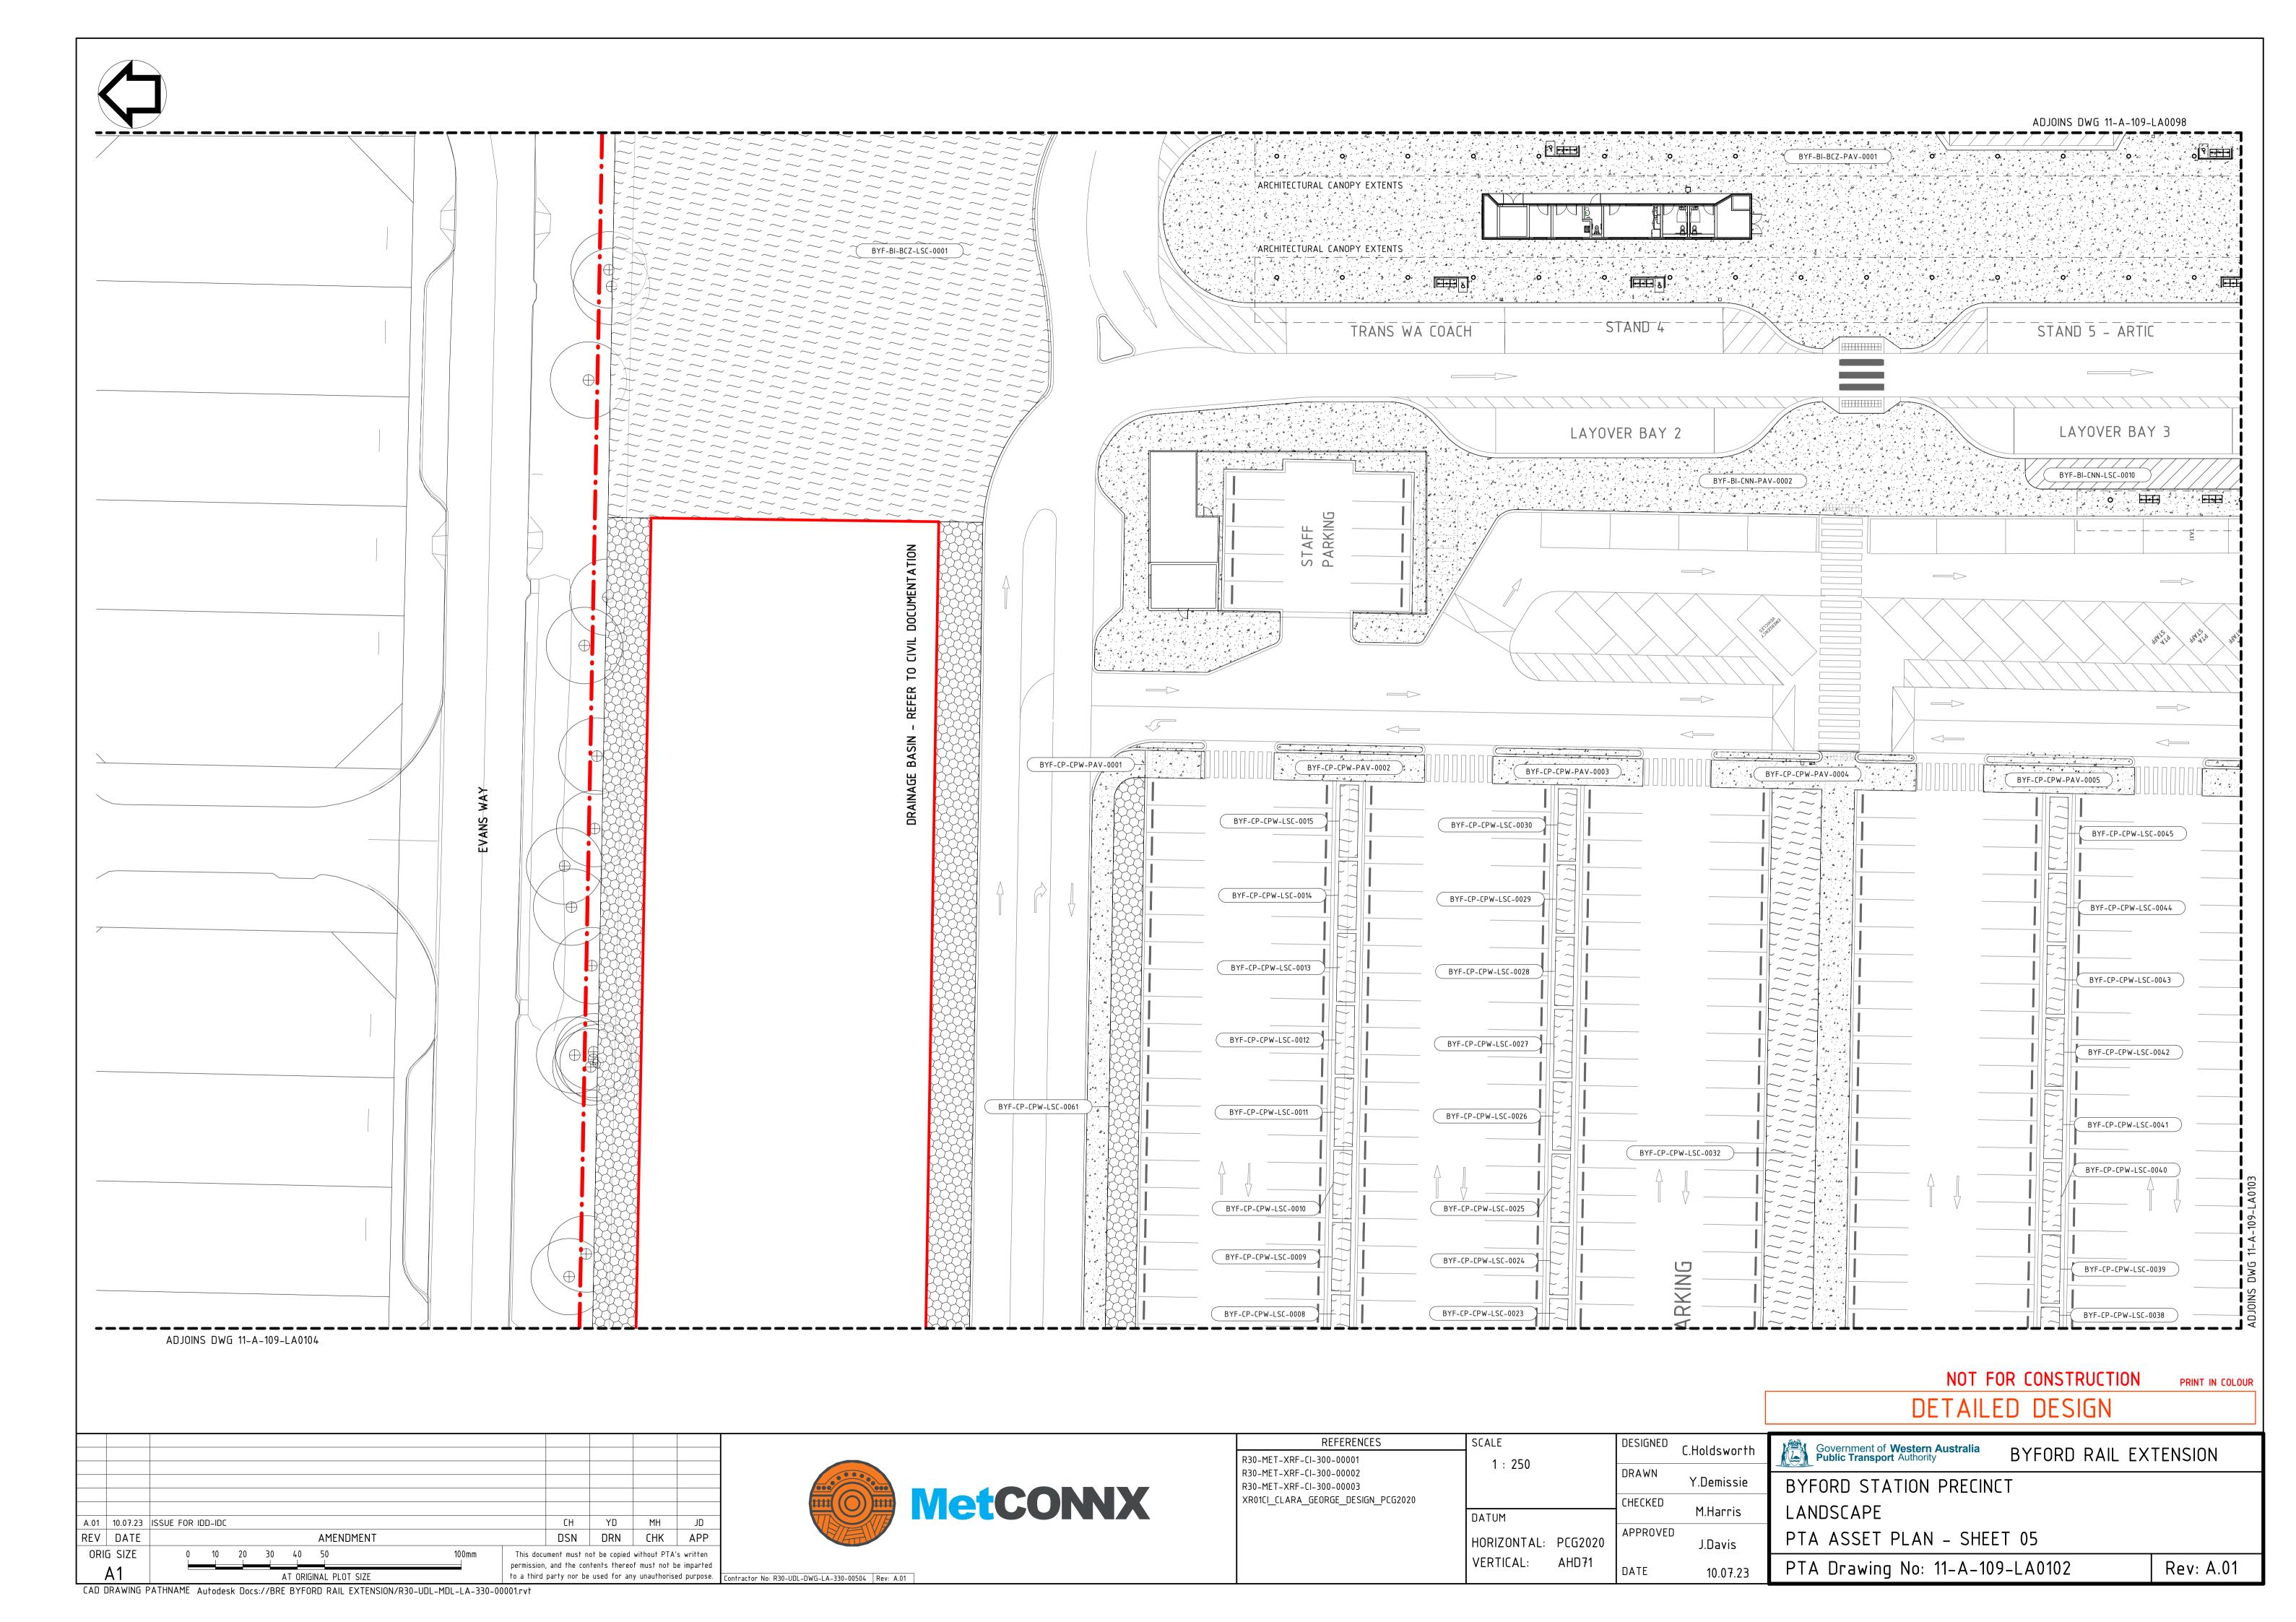


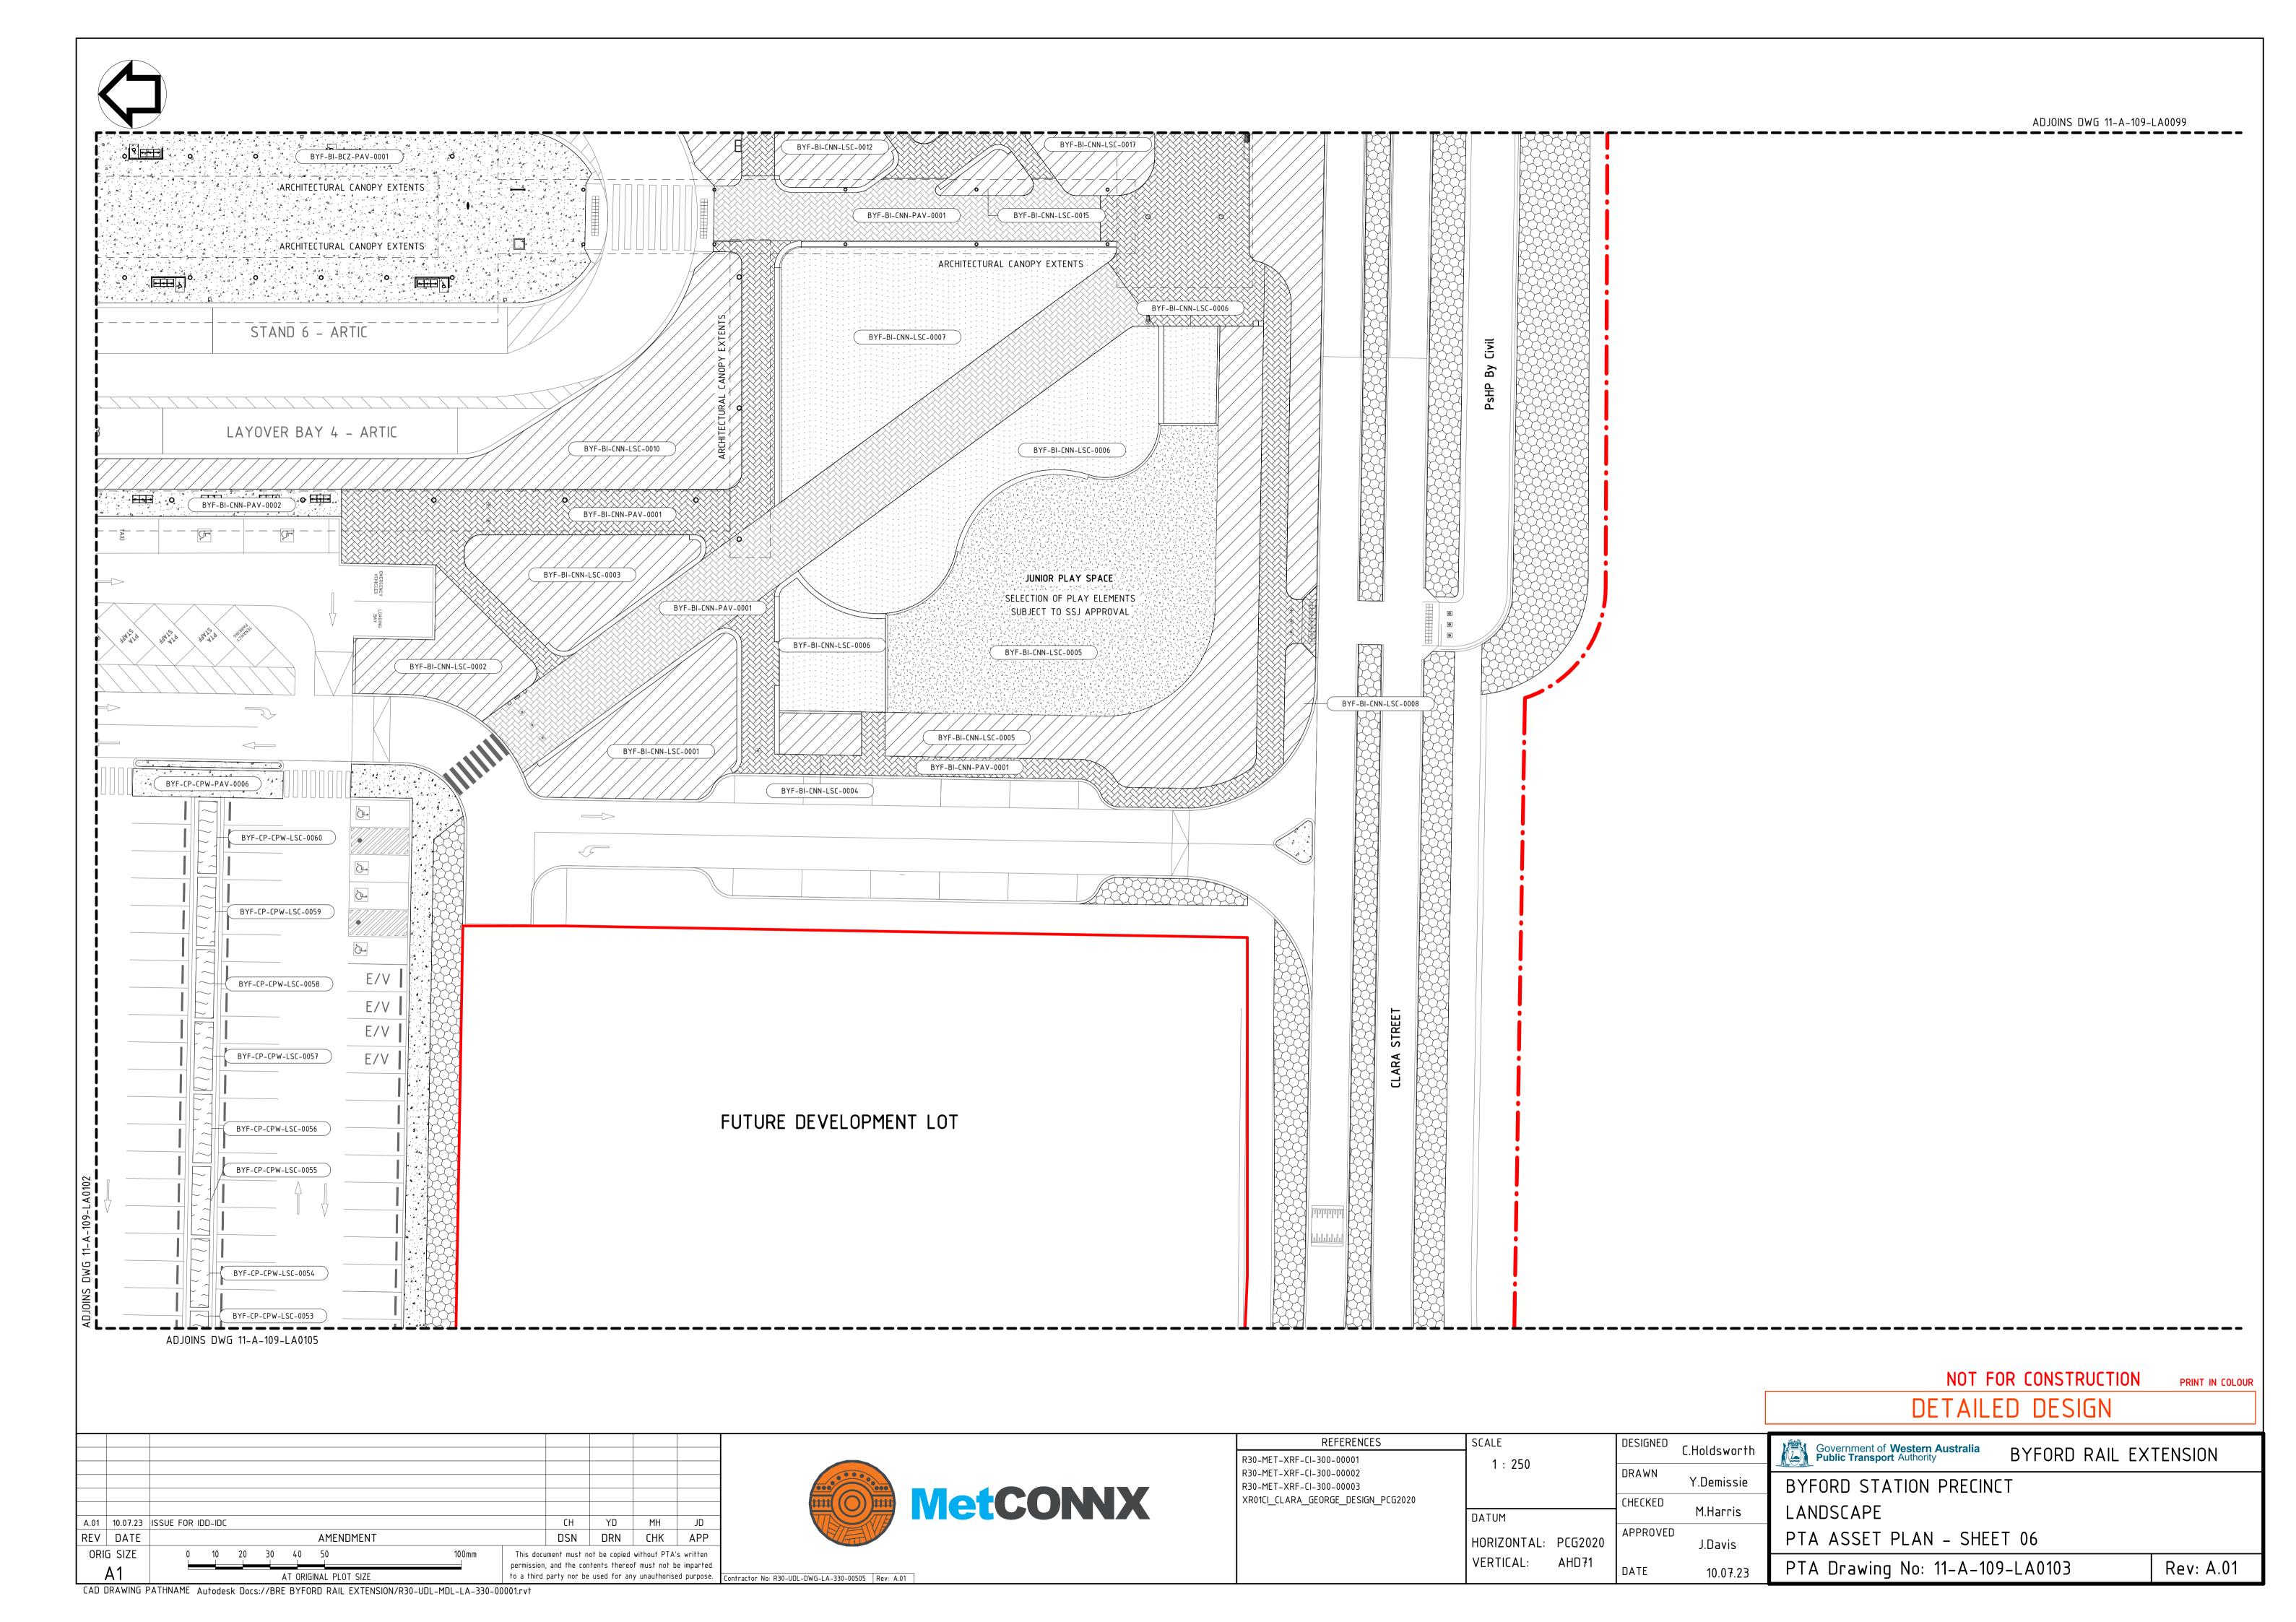


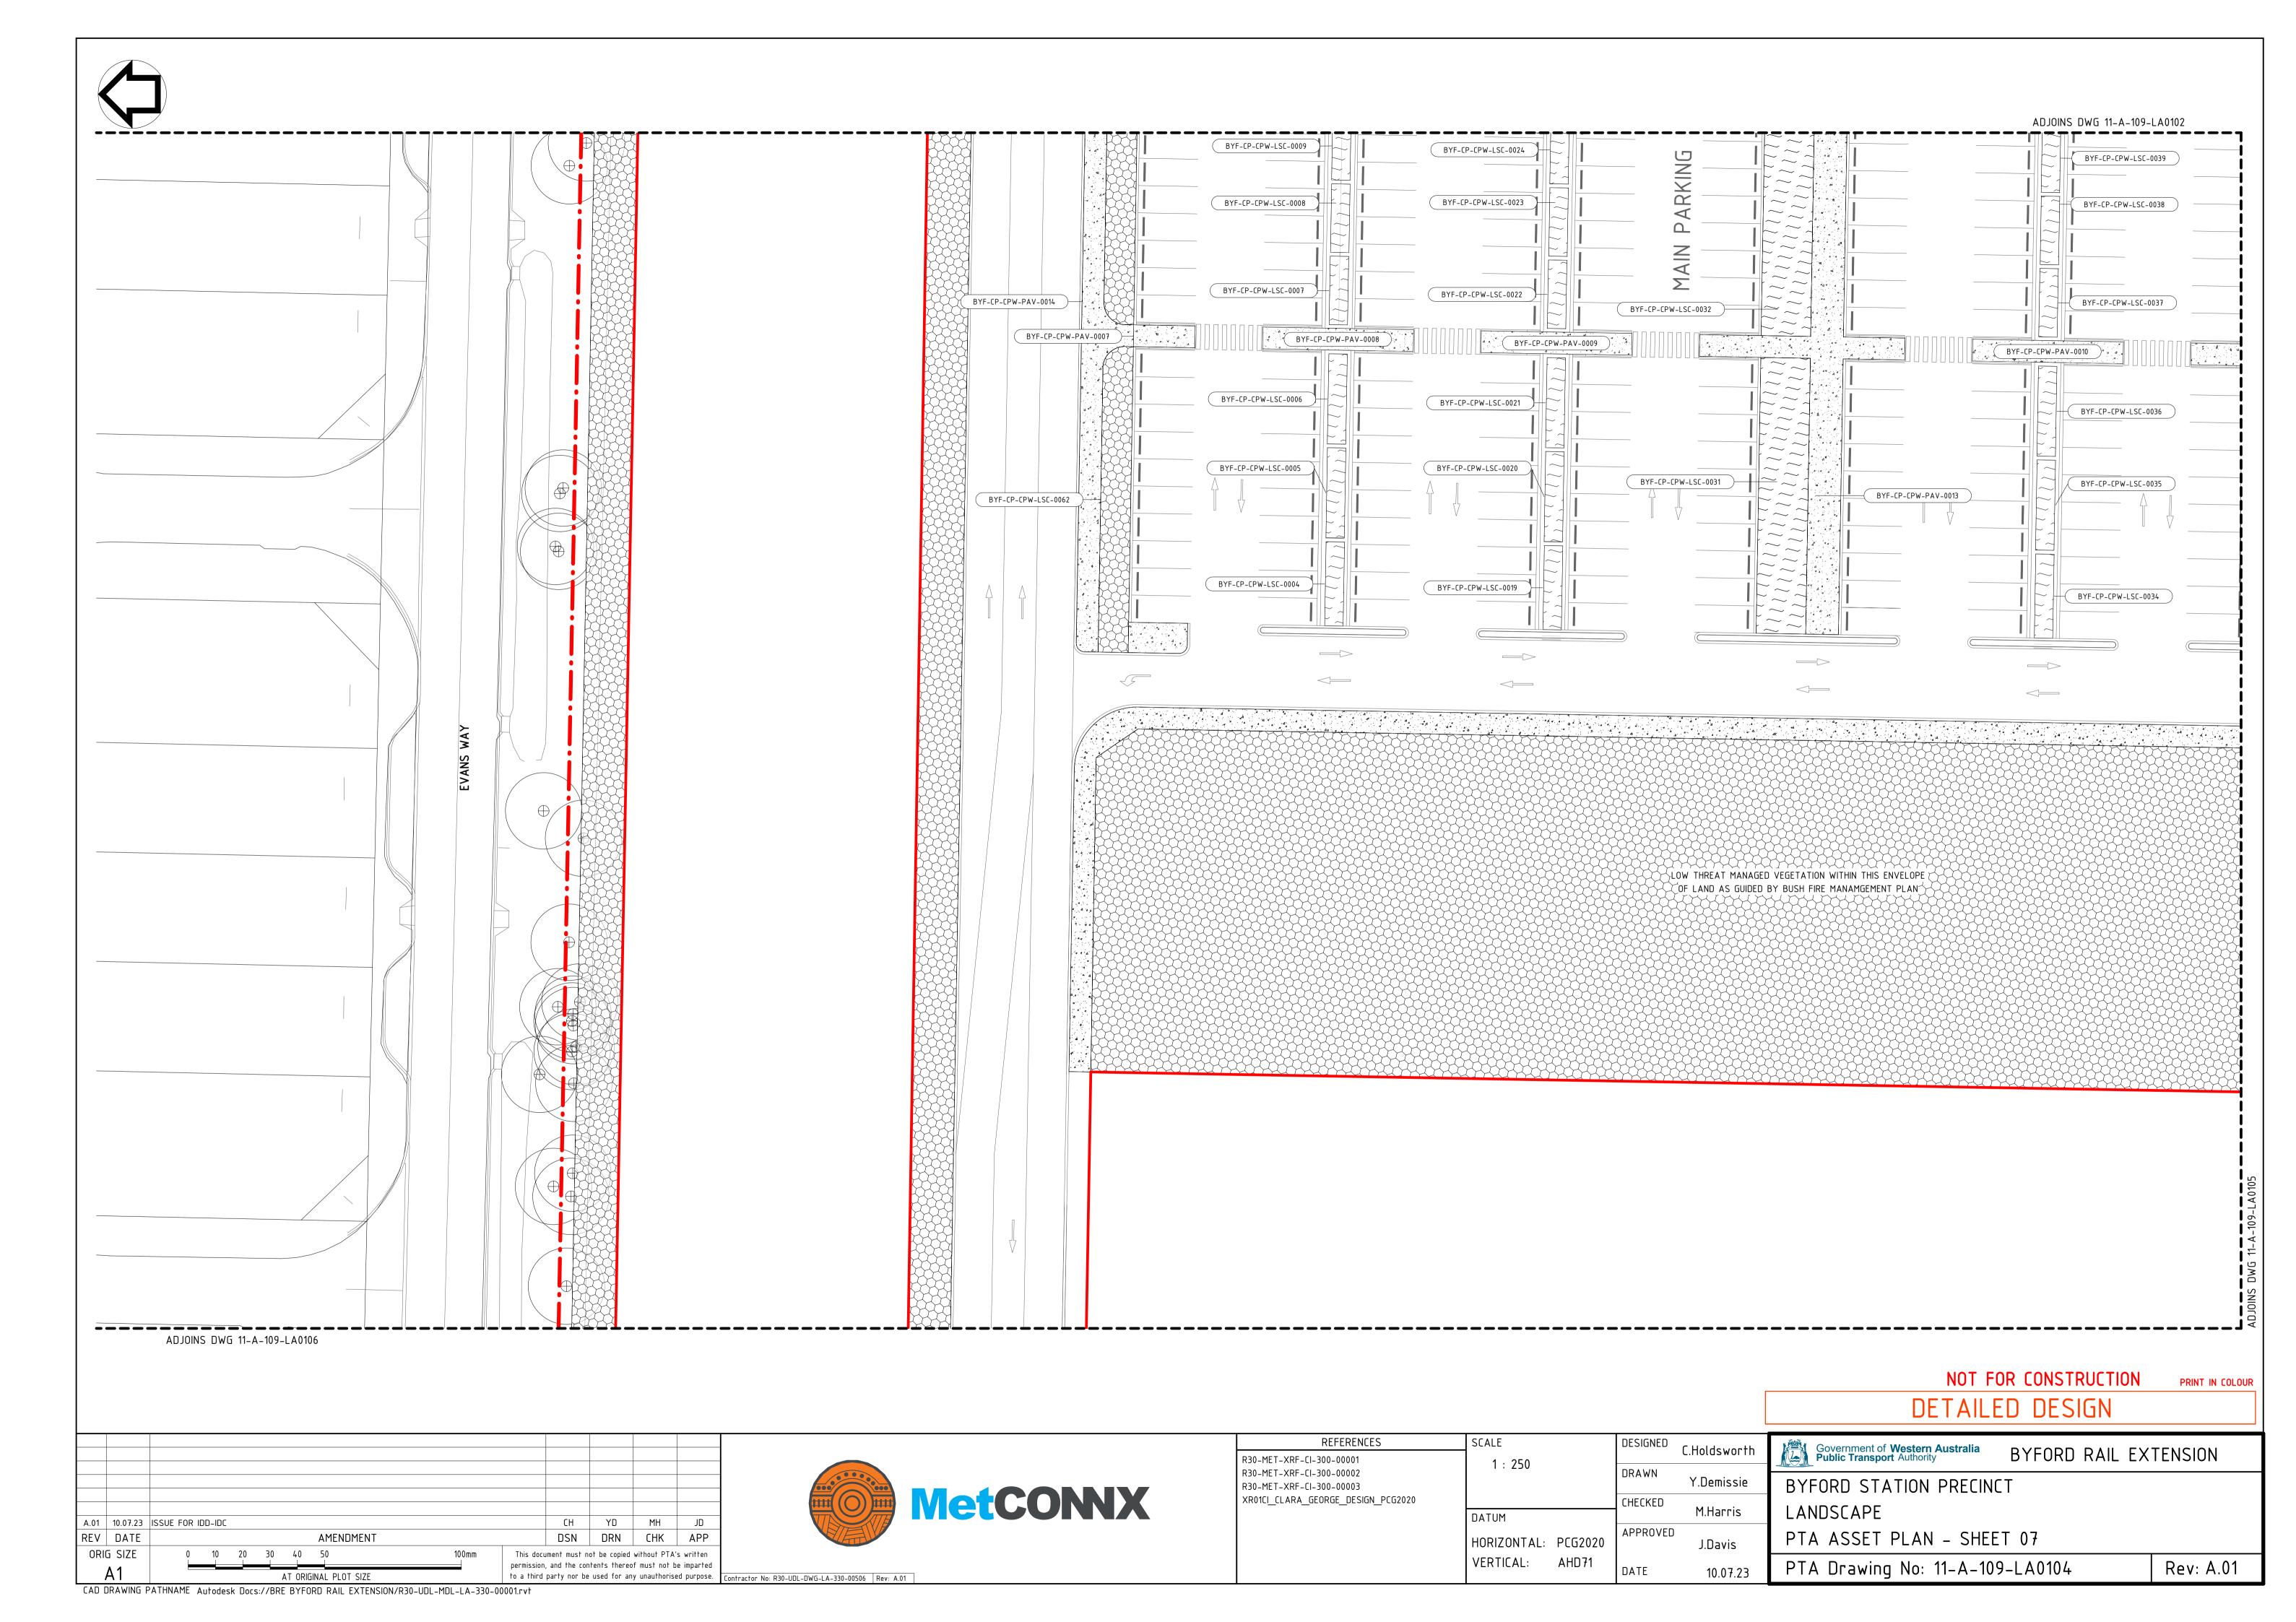


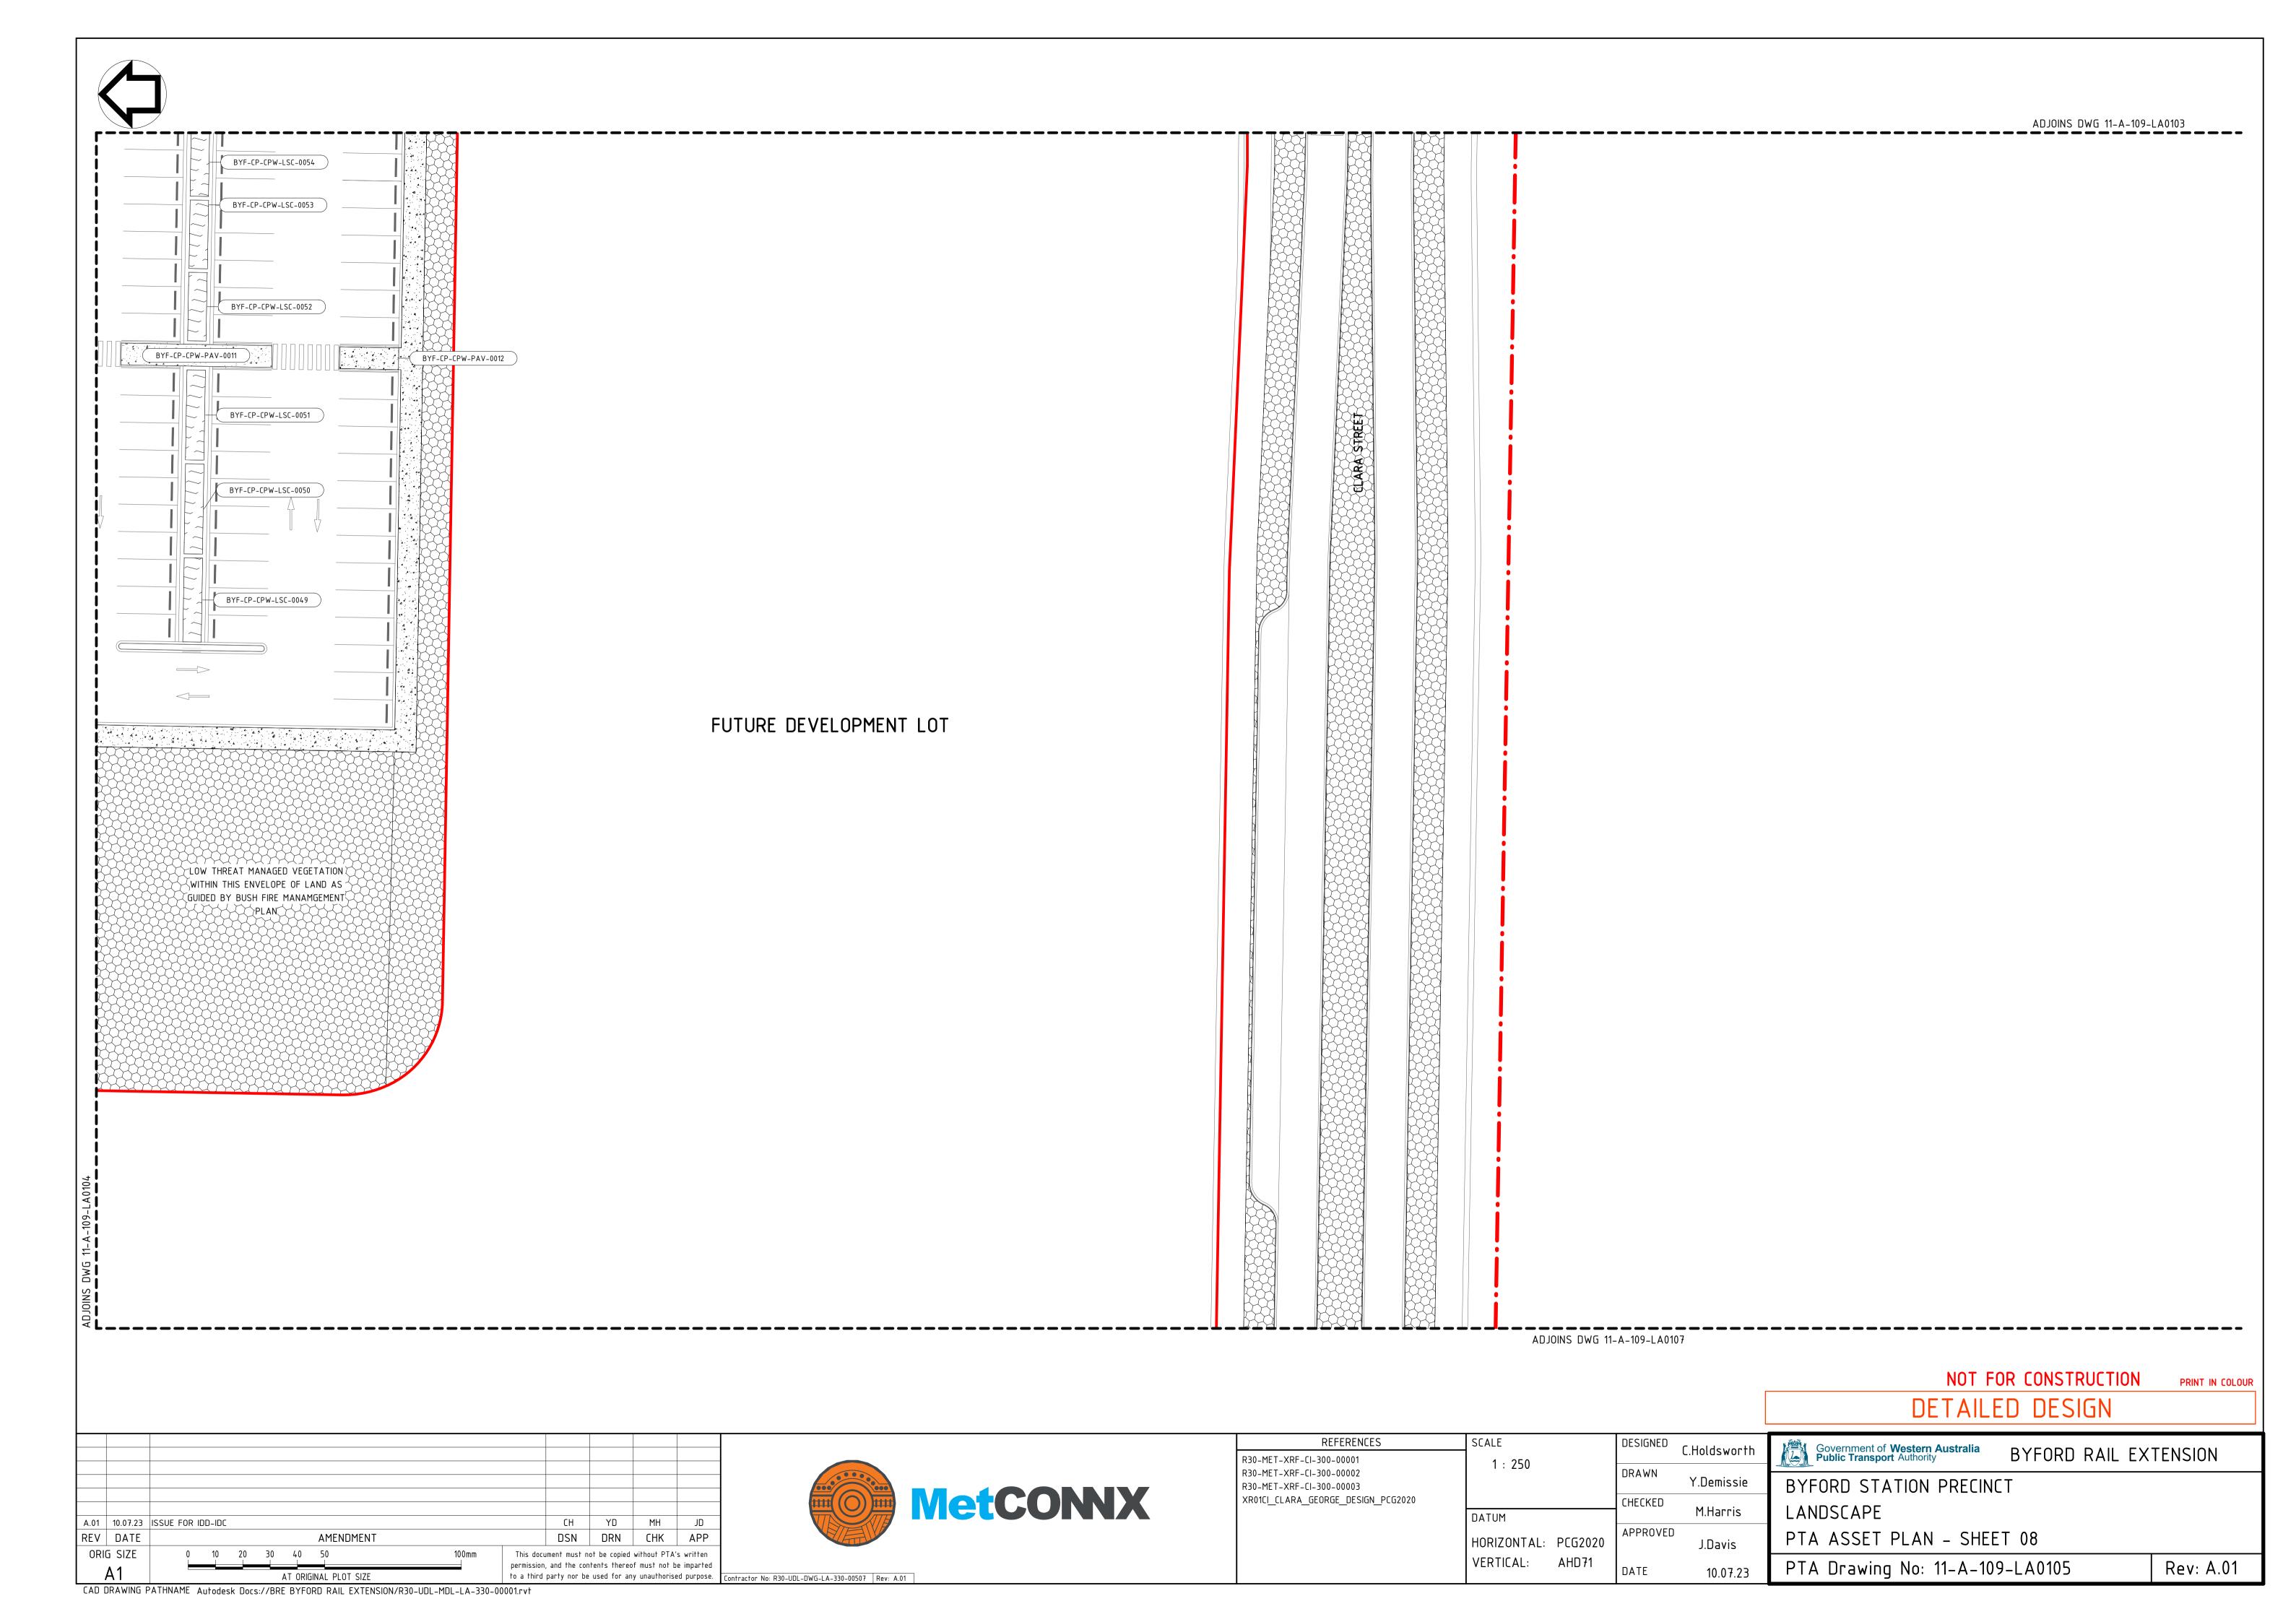

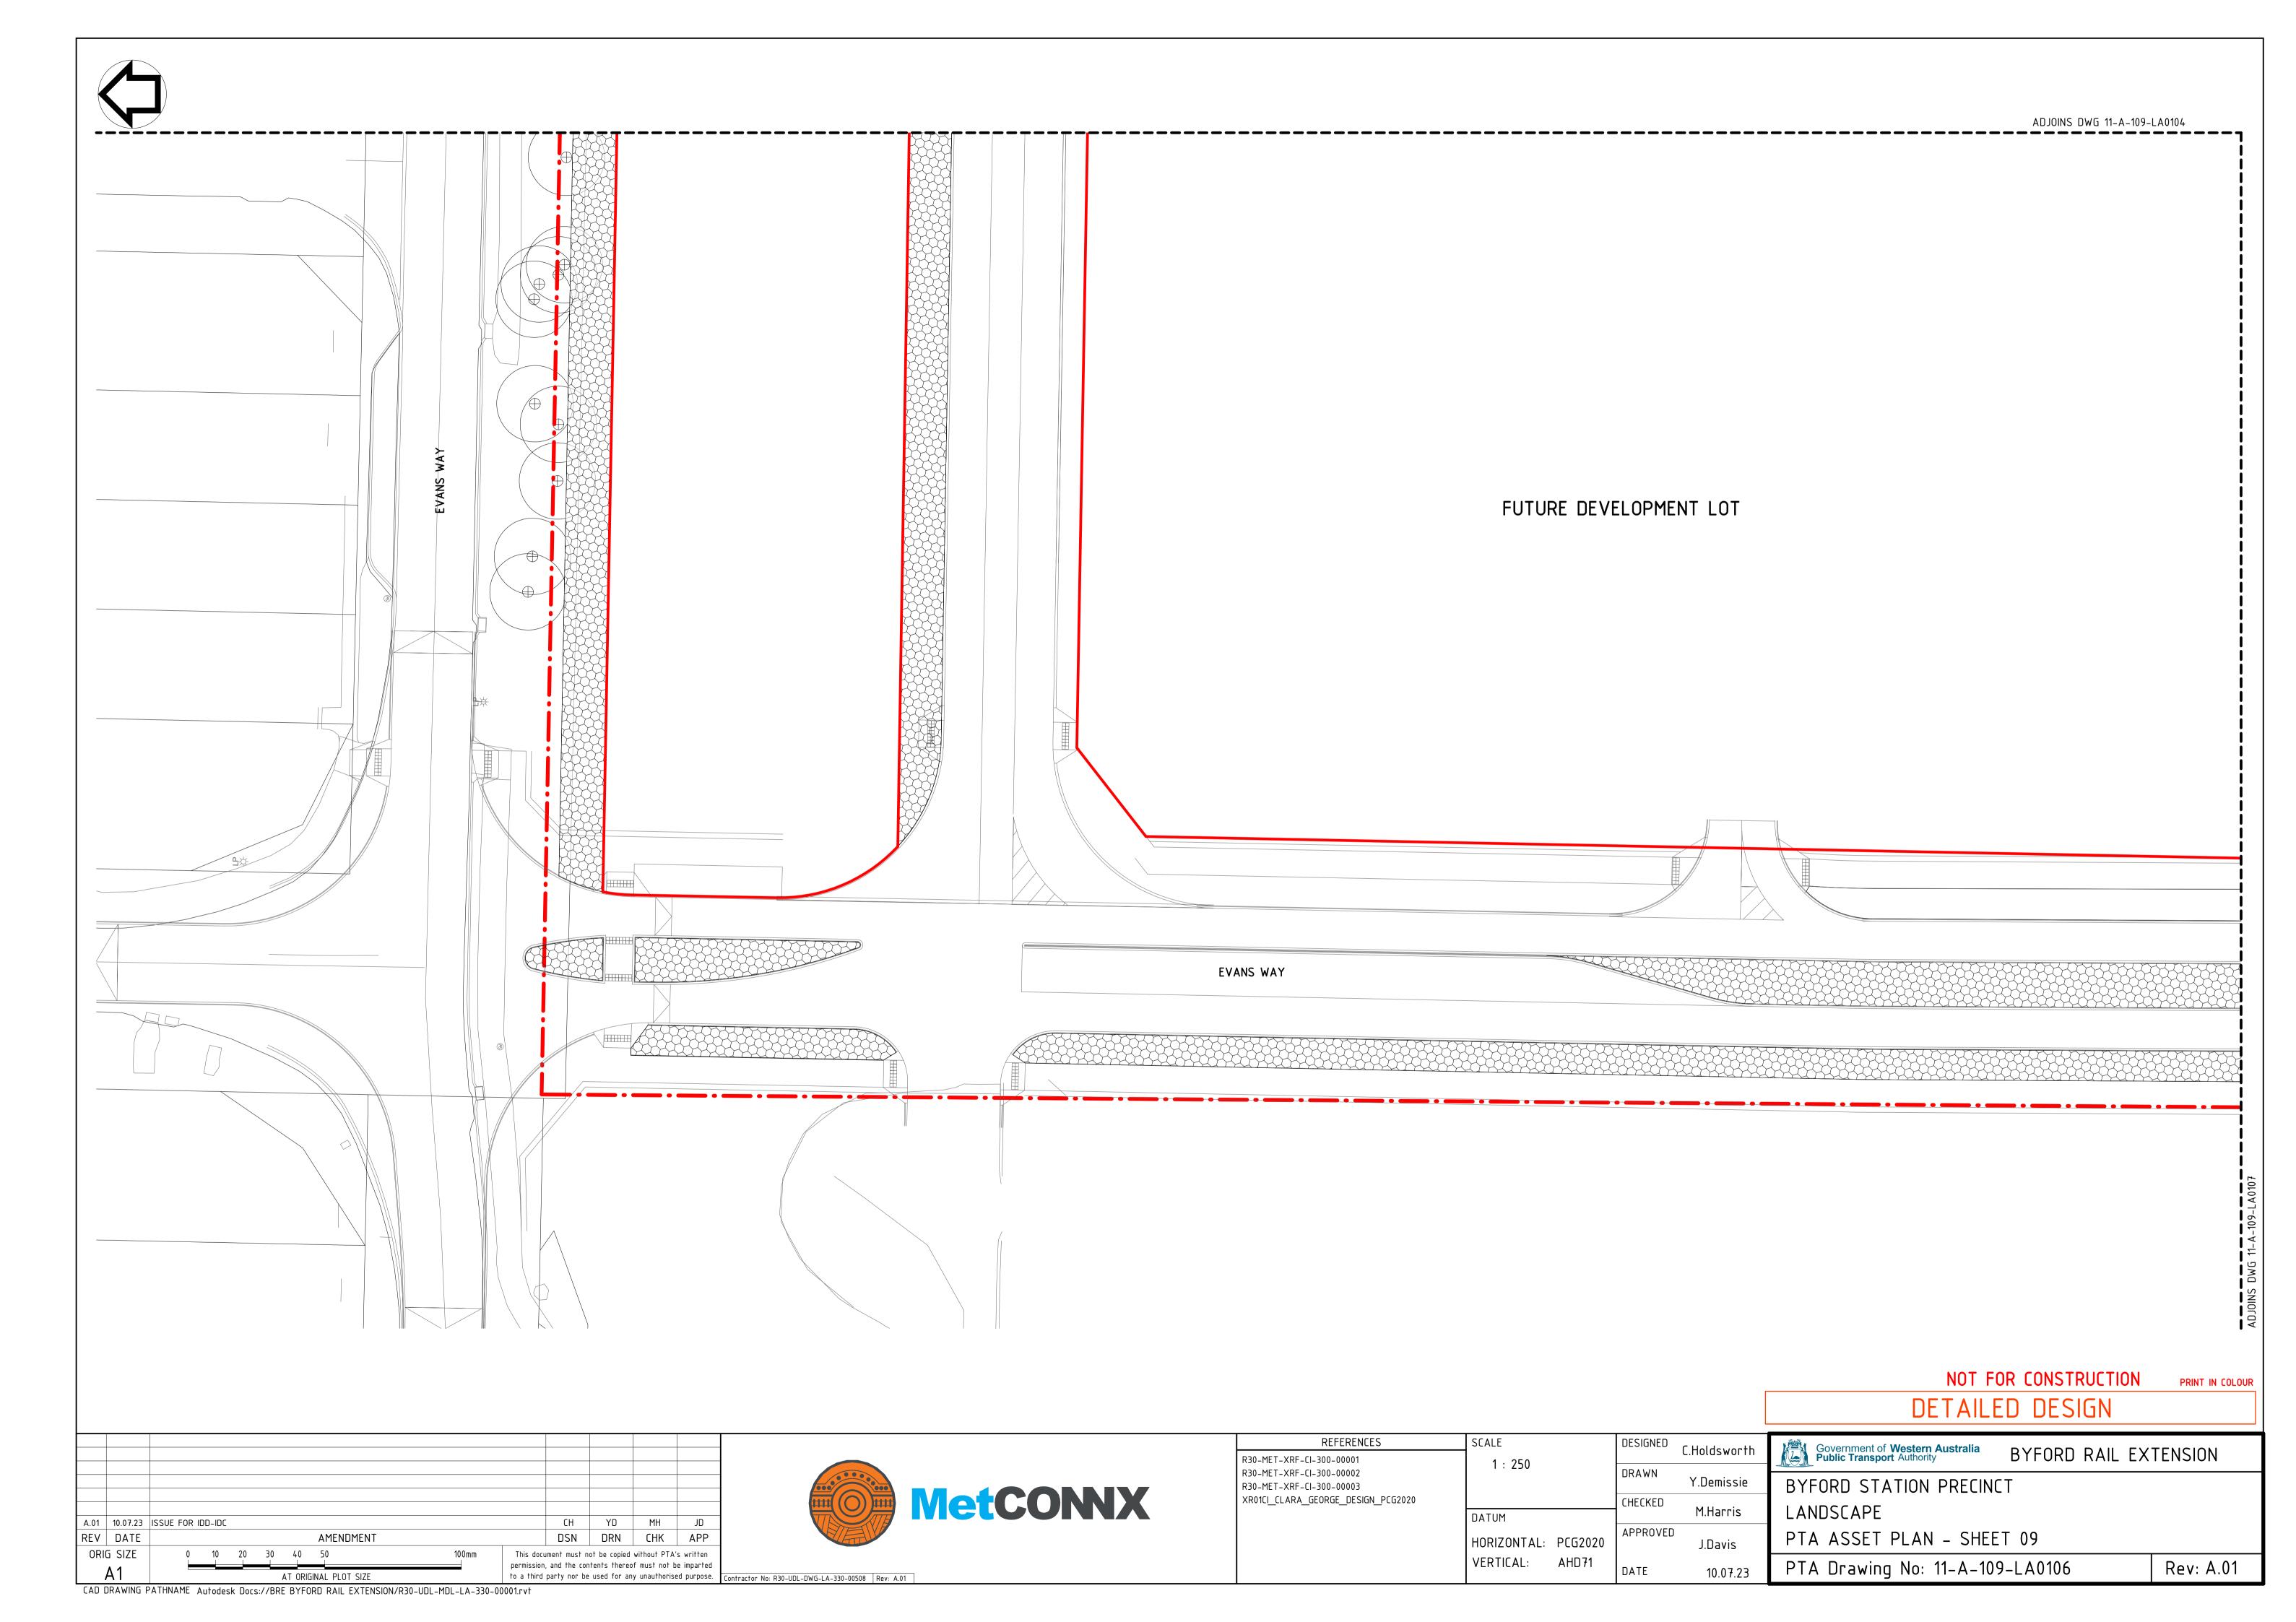

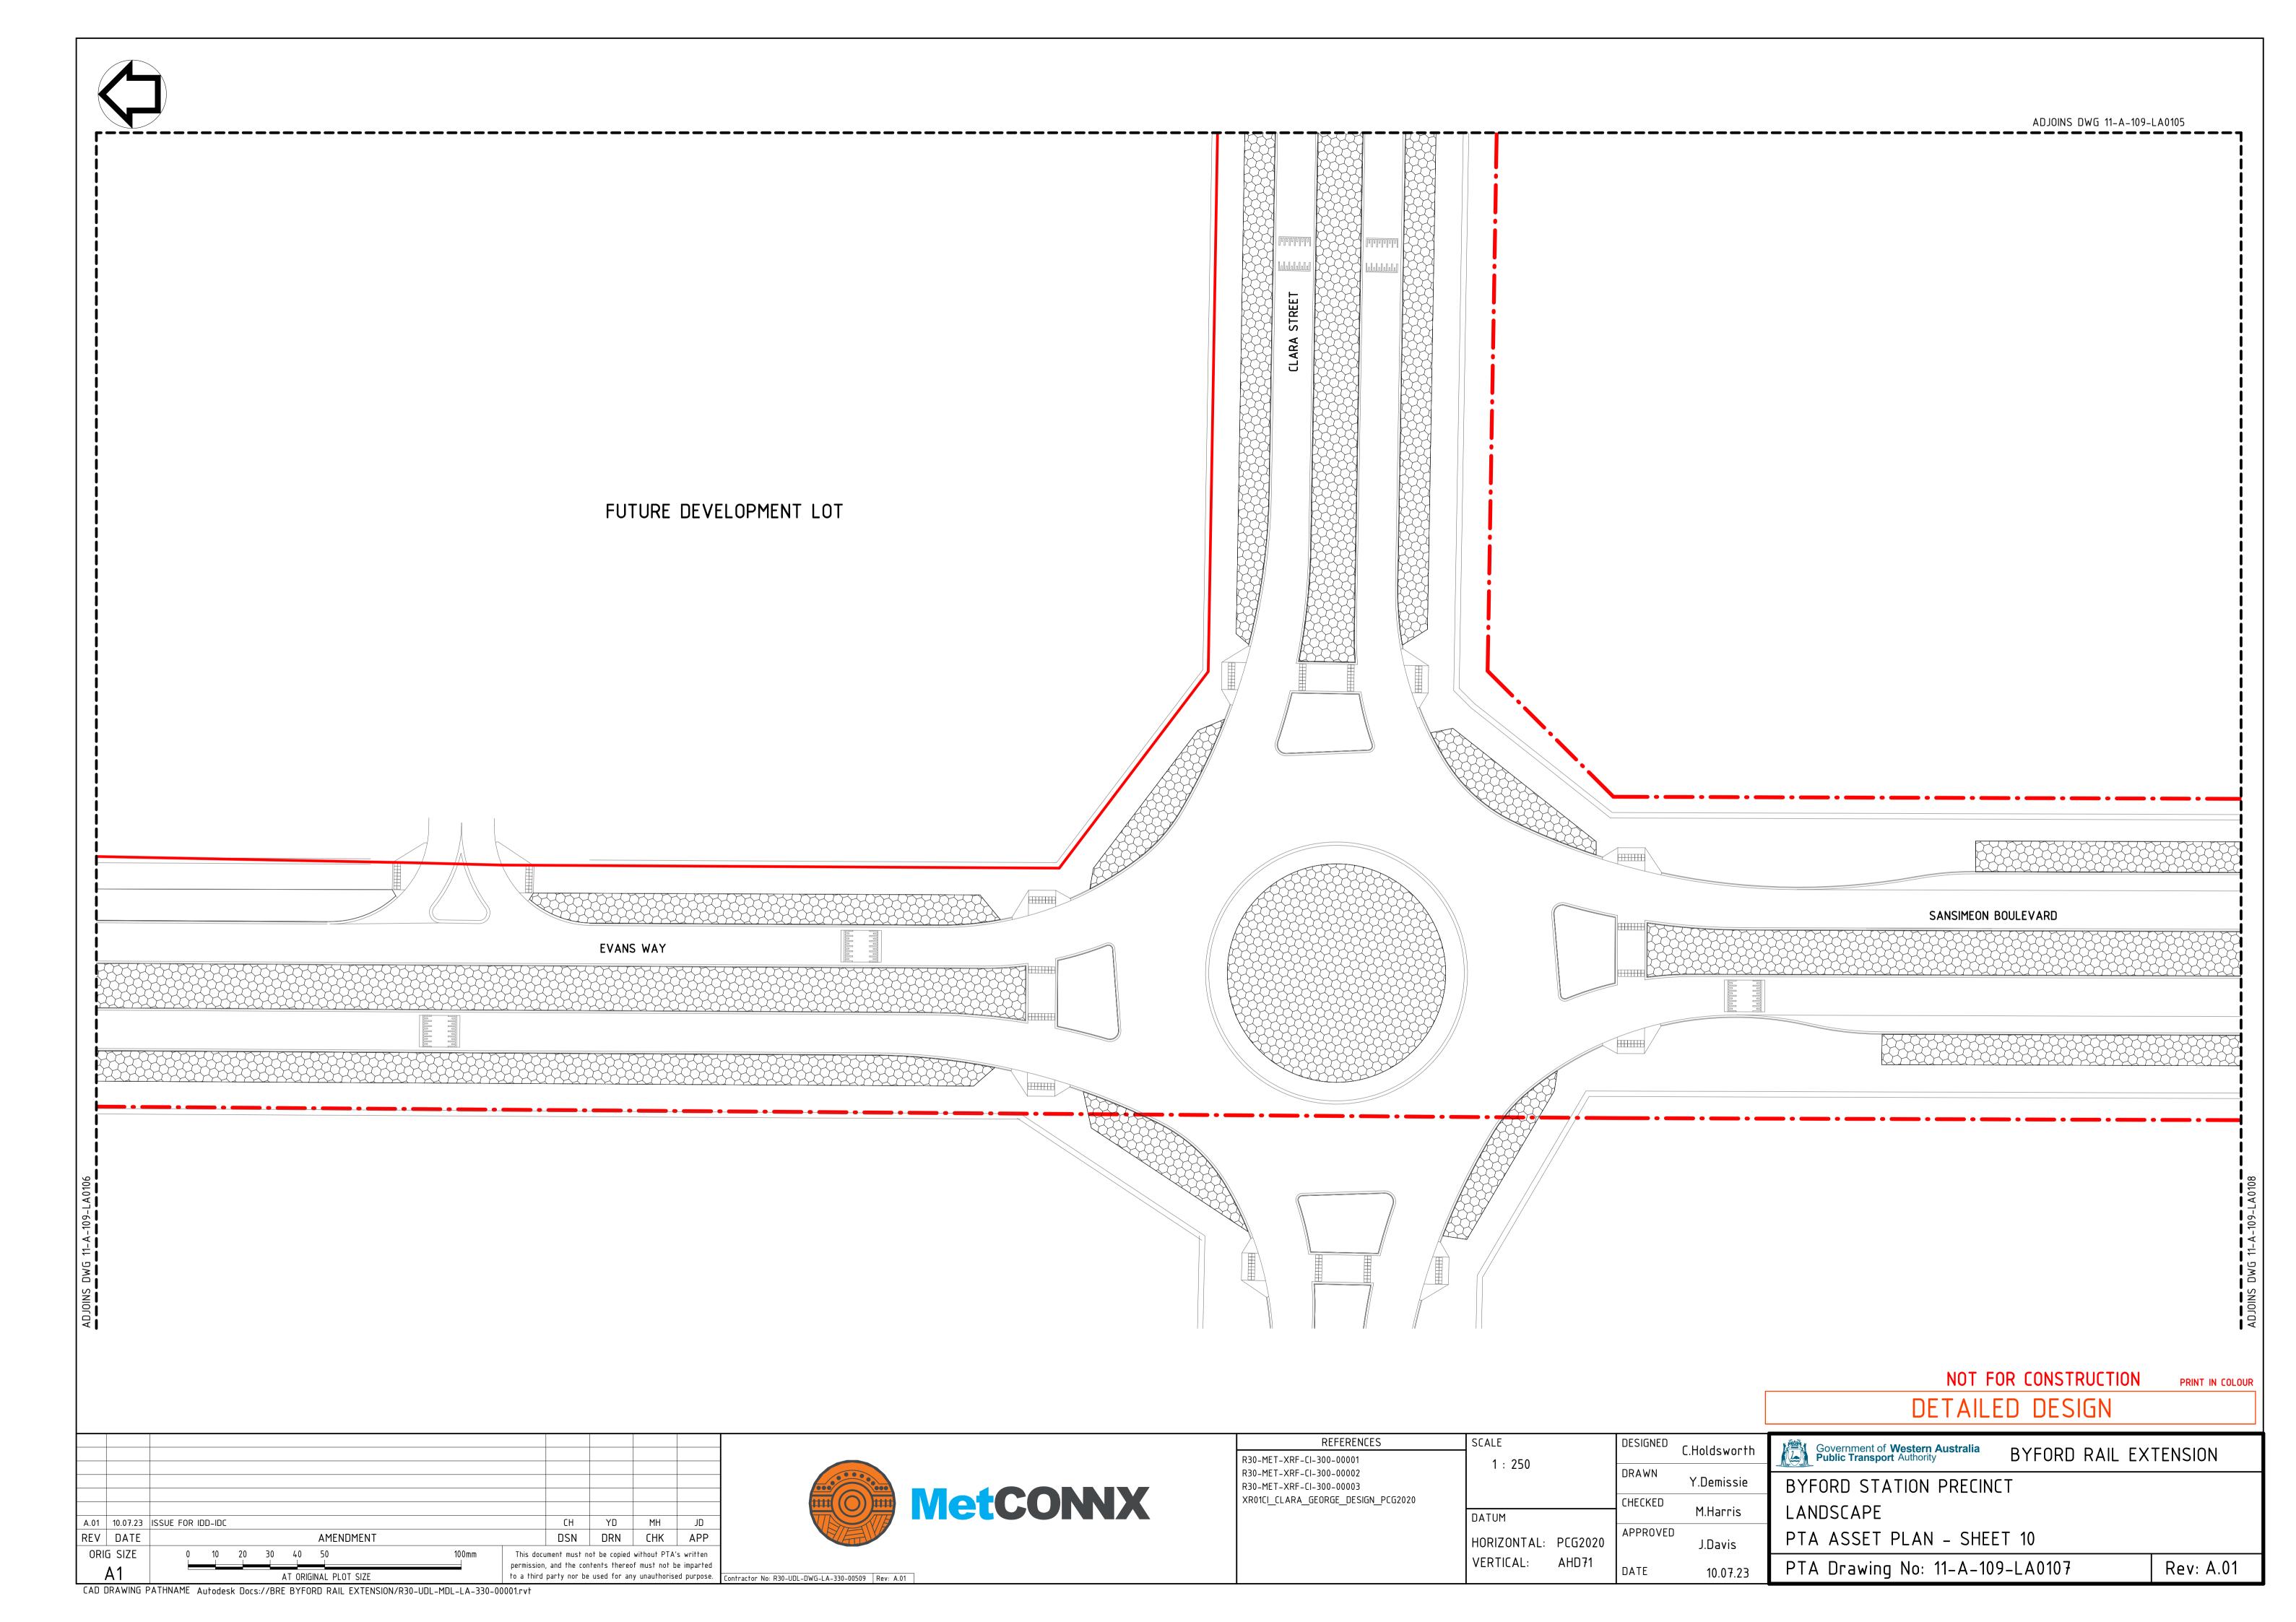

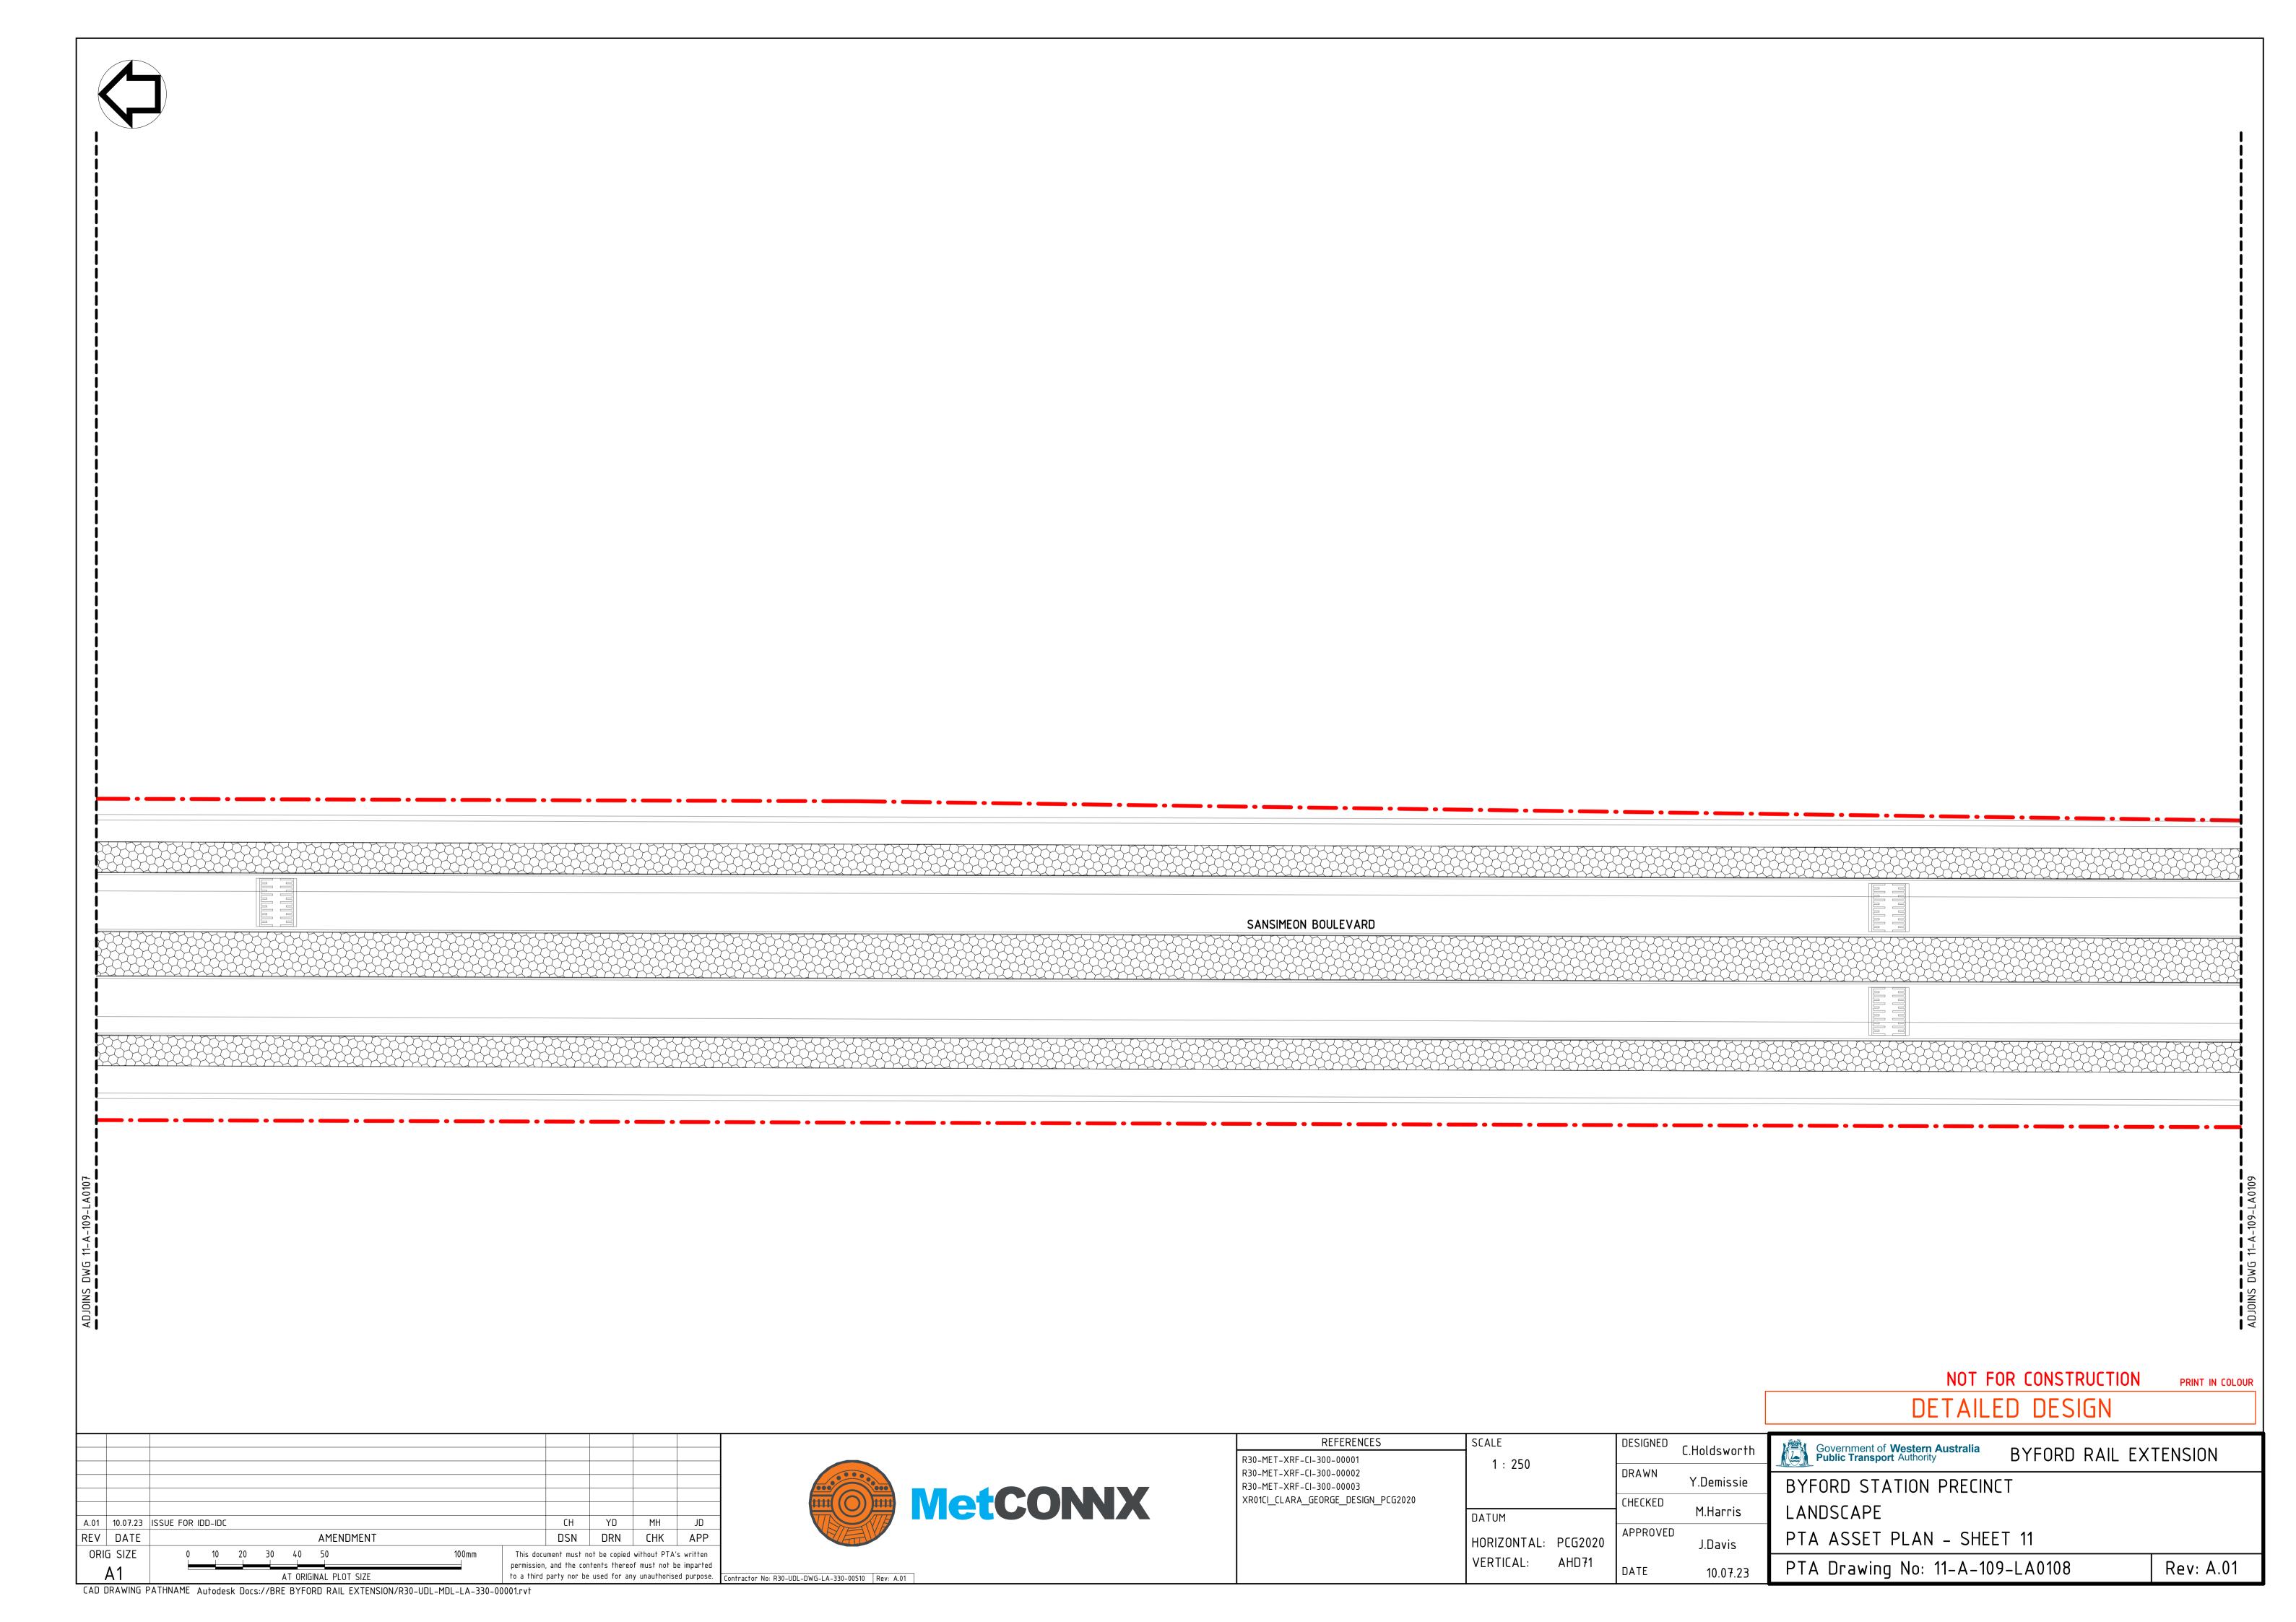

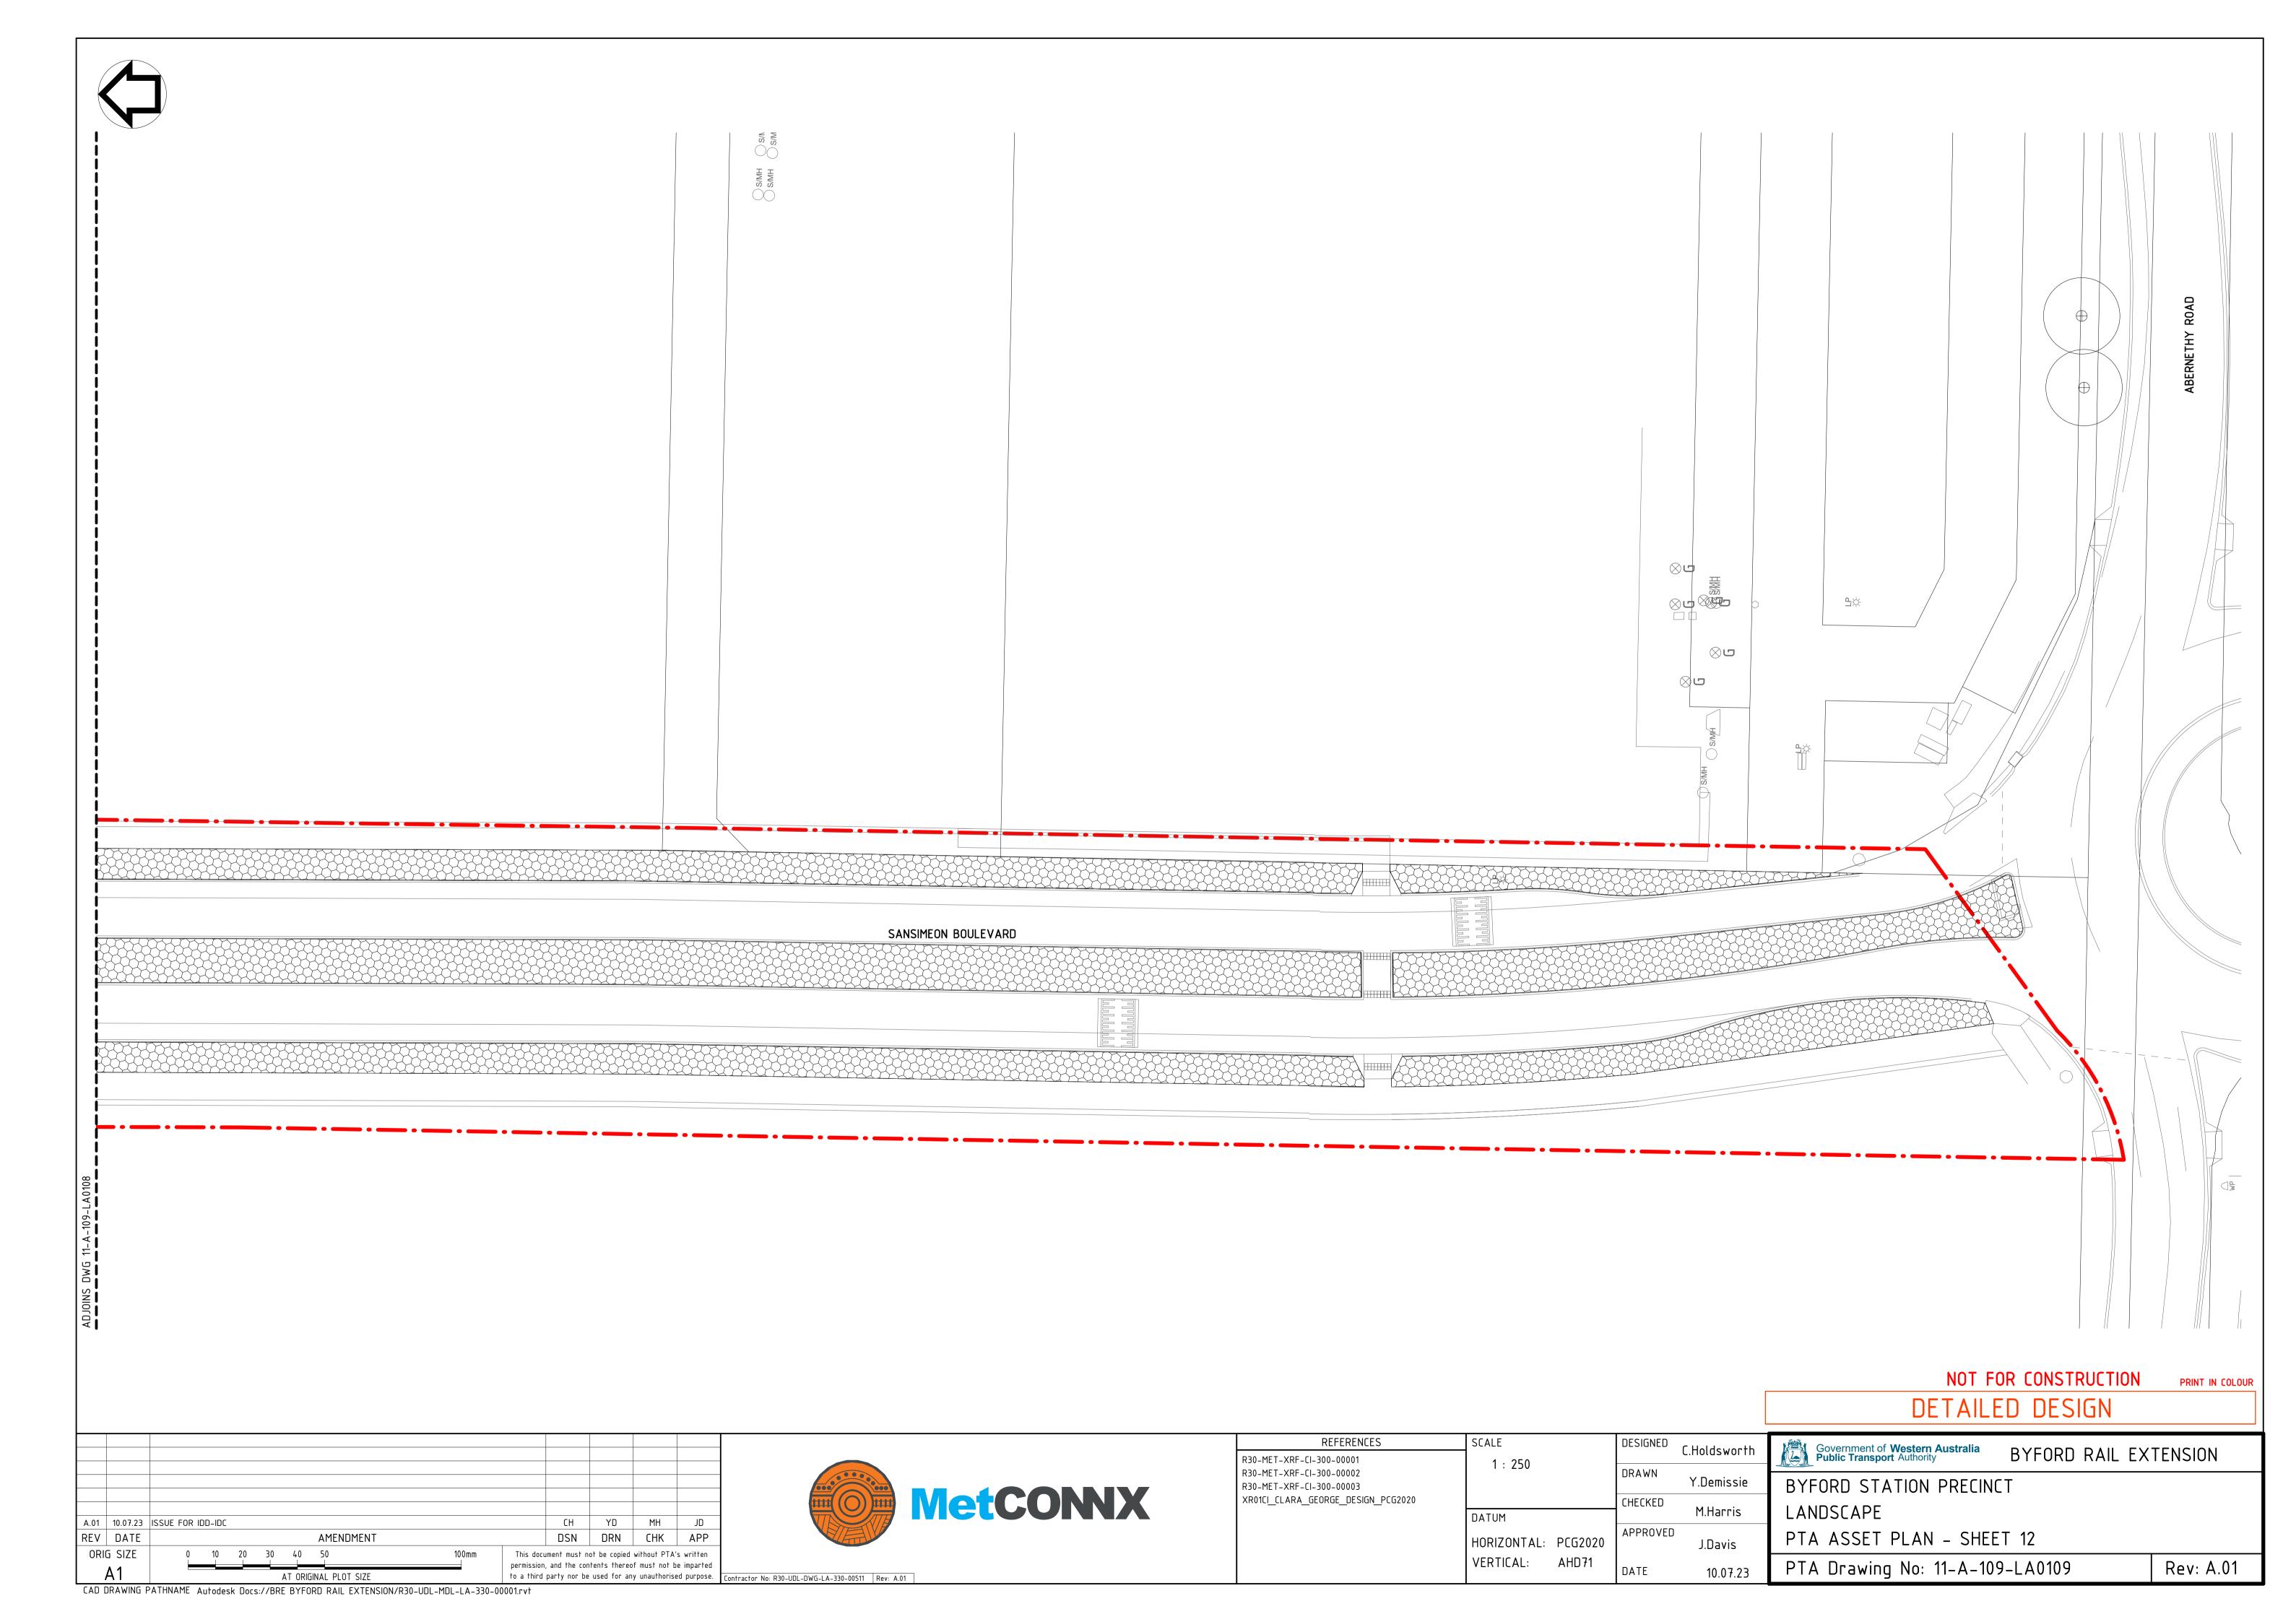

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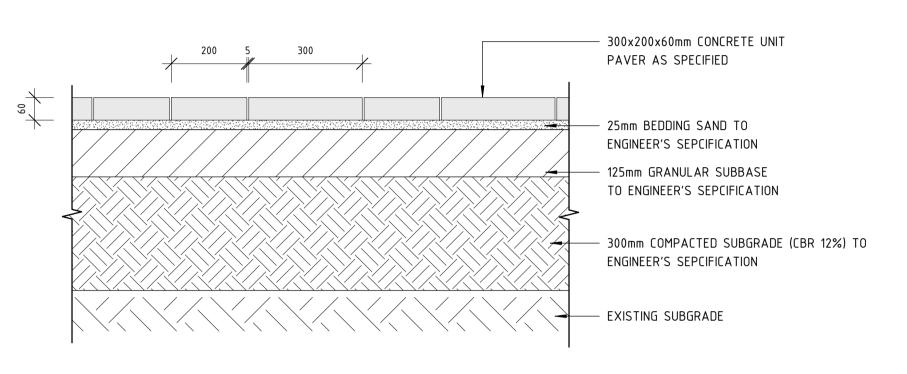
INDICATIVE PIXELATED PAVING DESIGN INTENT. DETAIL PLAN TO FOLLOW




CONCRETE UNIT PAVER (P2-01A) DESIGN INTENT

1: 10

MIN 2.5% FALL AWAY FROM ALL STRUCTURES




2 CONCRETE UNIT PAVER (P2-01A)
1: 10

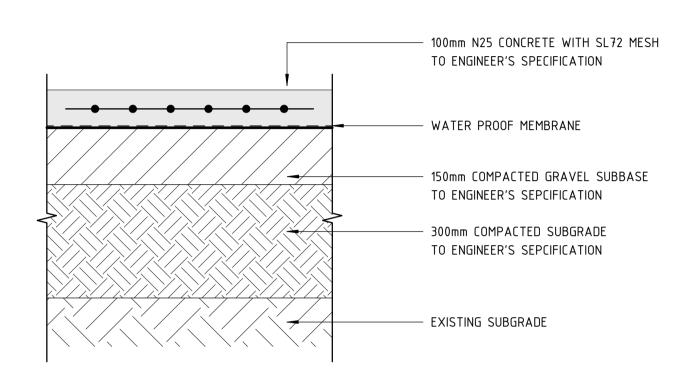


3 INSITU CONCRETE EXP. AGG (P1-01A)

1: 10

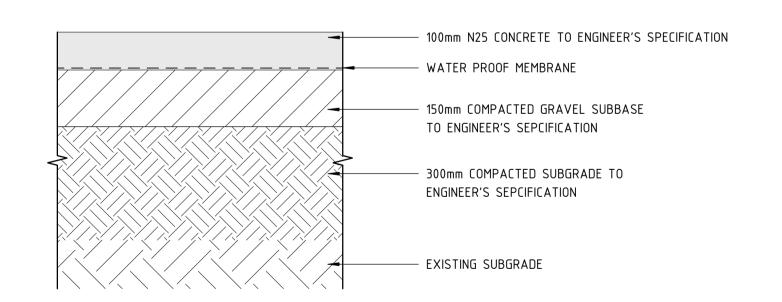

STANDARD GREY CONCRETE (P1-05B)

1:10

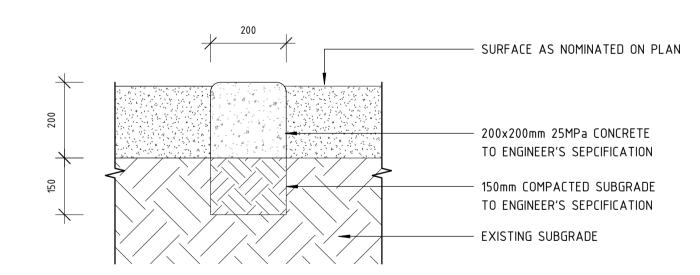

MOW KERB - EDGE RESTRAINT (E1-02A)

1:10

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CH YD MH AE

REV DATE

AMENDMENT

DSN DRN CHK APP

ORIG SIZE

O 10 20 30 40 50

100mm

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Contractor No: R30-UDL-DWG-LA-330-01000 Rev: B.01

					DETAILED DESIGN			
REFERENCES	SCALE 1 : 10			C.Holdsworth	Government of Western Australia BYFORD Public Transport Authority		TENSION	
		DRAWN	PAWN Y.Demissie BYFORD STATION PRECINCT					
DATUM		CHECKED	M.Harris	LANDSCAPE				
	HORIZONTAL:	PCG2020	APPROVED	J.Davis	HARDSCAPE DETAILS 01			
	VERTICAL:	AHD71	DATE	10.07.23	PTA Drawing No: 11-A-109	9-LA0118	Rev: B.01	

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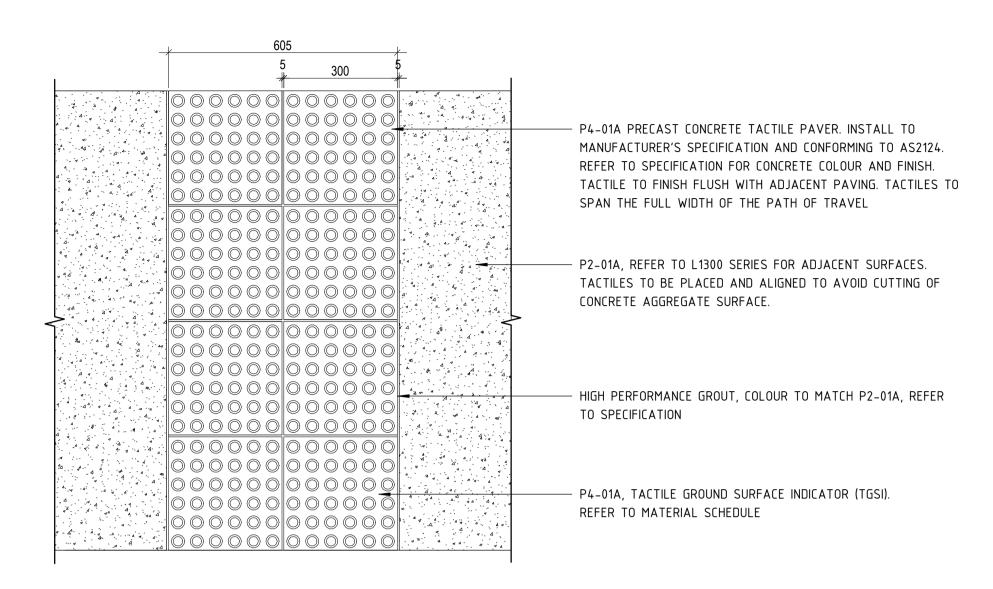


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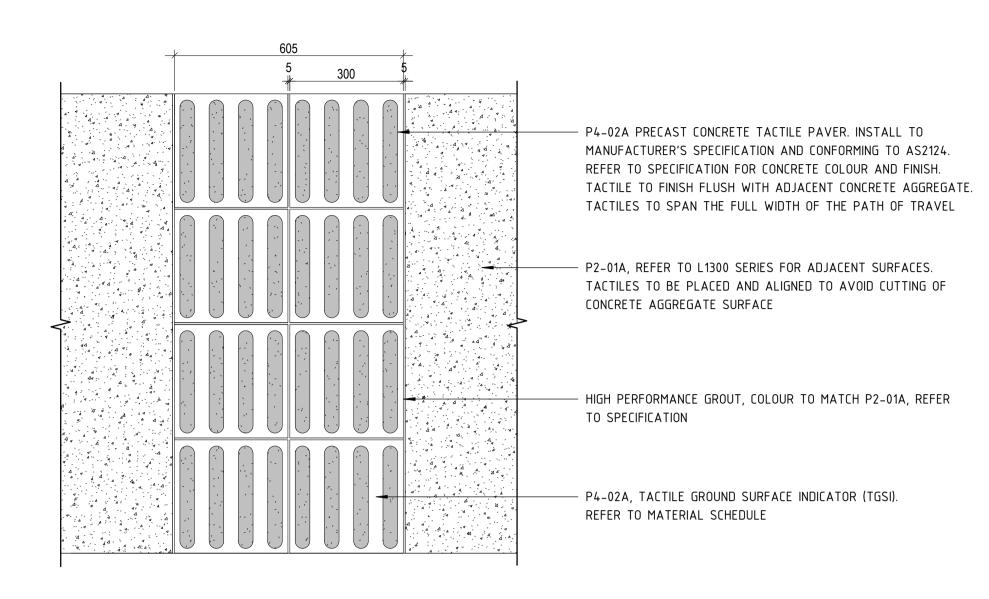
Rev: B.01




1 HAZARD TACTILE UNITS (P4-01A) - PLAN
1: 10

- P4-01A PRECAST CONCRETE HAZARD TACTILE PAVER - INSTALL TO MANUFACTURER'S SPECIFICATION AND CONFORMING TO AS2124. REFER TO SPECIFICATION FOR CONCRETE COLOUR AND FINISH. TACTILE TO FINISH FLUSH WITH ADJACENT CONCRETE AGGREGATE SURFACE. HIGH PERFORMANCE GROUT, COLOUR TO MATCH P2-01A, REFER TO SPECIFICATION - P2-01A, 100mm N25 CONCRETE WITH SL72 MESH TO ENGINEER'S SPECIFICATION. HAZARD TACTILES TO BE PLACED AND ALIGNED TO AVOID CUTTING OF CONCRETE AGGREGATE SURFACE. WATERPROOF MEMBRANCE 150mm COMPACTED GRAVEL SUBBASE TO ENGINEER'S SEPCIFICATION 300mm COMPACTED SUBGRADE TO ENGINEER'S SEPCIFICATION - EXISTING SUBGRADE

INTEGRATED TACTILE UNITS (P4-01A) - SECTION




DIRECTIONAL TACTILE UNITS (P4-02A) - PLAN

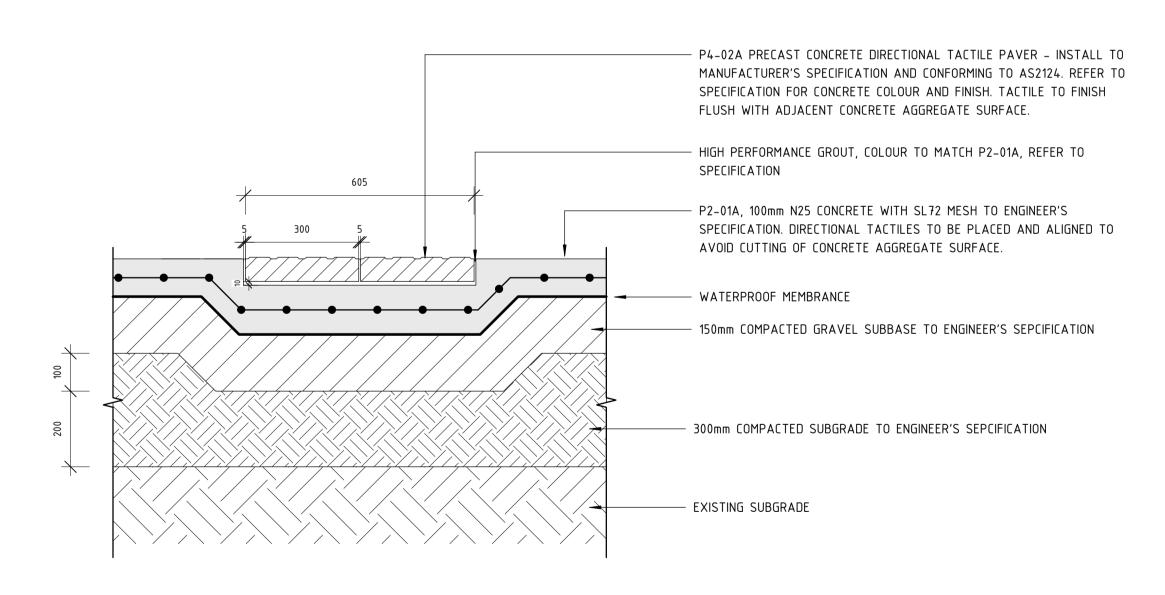

INTEGRATED TACTILE UNITS (P4-02A) - SECTION

1: 10

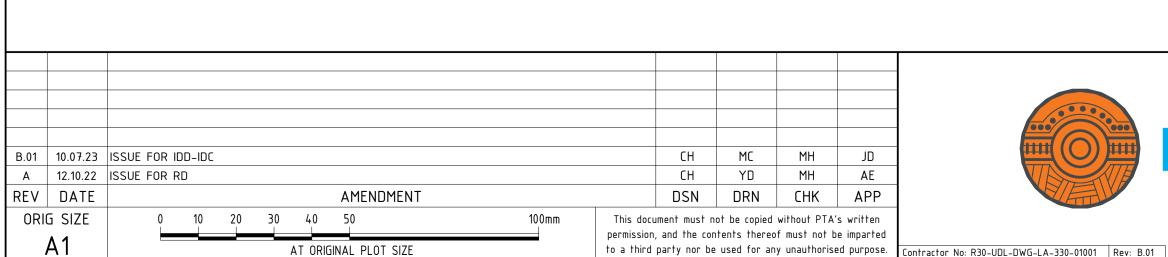




					DETAILED DESIGN				
REFERENCES	SCALE 1 : 10		DESIGNED DRAWN	C.Holdsworth	Government of Western Australia Public Transport Authority	BYFORD RAIL EX	TENSION		
				Y.Demissie	BYFORD STATION PRECINCT				
	DATUM		CHECKED	M.Harris	LANDSCAPE				
	HORIZONTAL:	PCG2020	APPROVED	J.Davis	HARDSCAPE DETAILS 02				
	VERTICAL:	AHD71	DATE	10.07.23	PTA Drawing No: 11-A-10	9-LA0119	Rev: B.0		


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1. ALL DETAILS SUBJECT TO STRUCTURAL ENGINEER REVIEW.

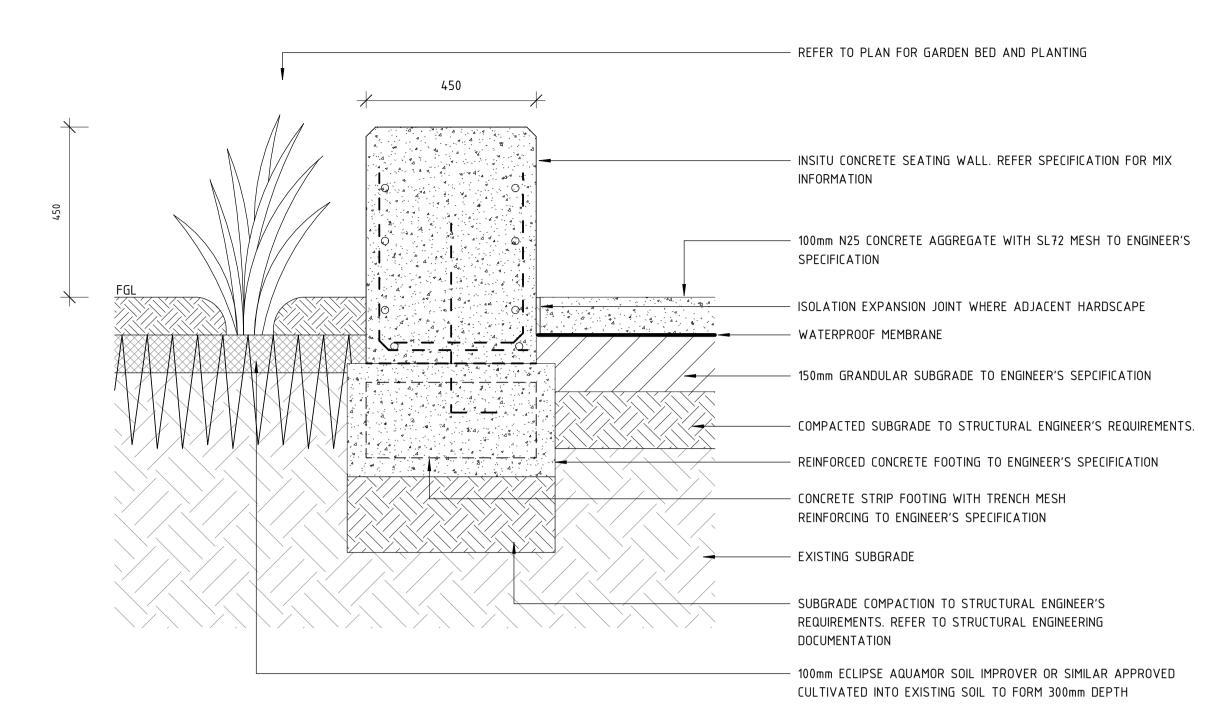


CONCRETE SEATING WALL (CONC. AGG/GARDEN BED)


1: 10

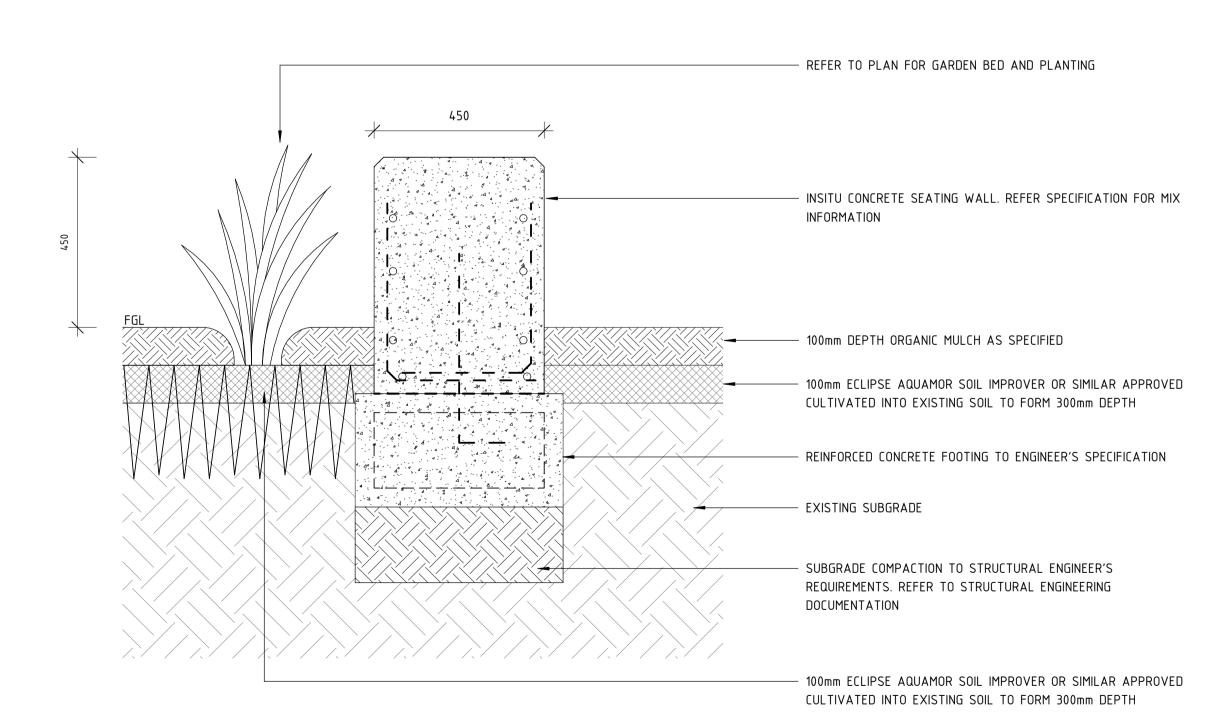

CONCRETE SEATING WALL (MULCH/GARDEN BED)

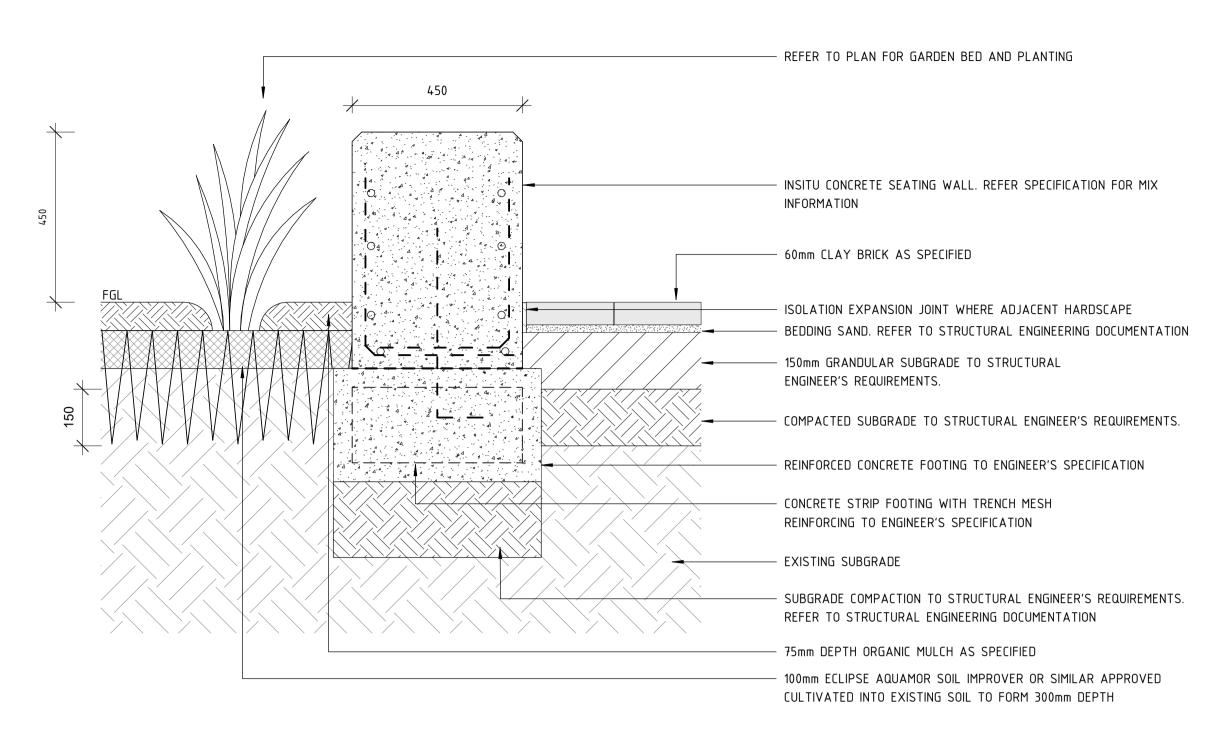

2 CONCRETE SEATING WALL (PAVEMENT/GARDEN BED)

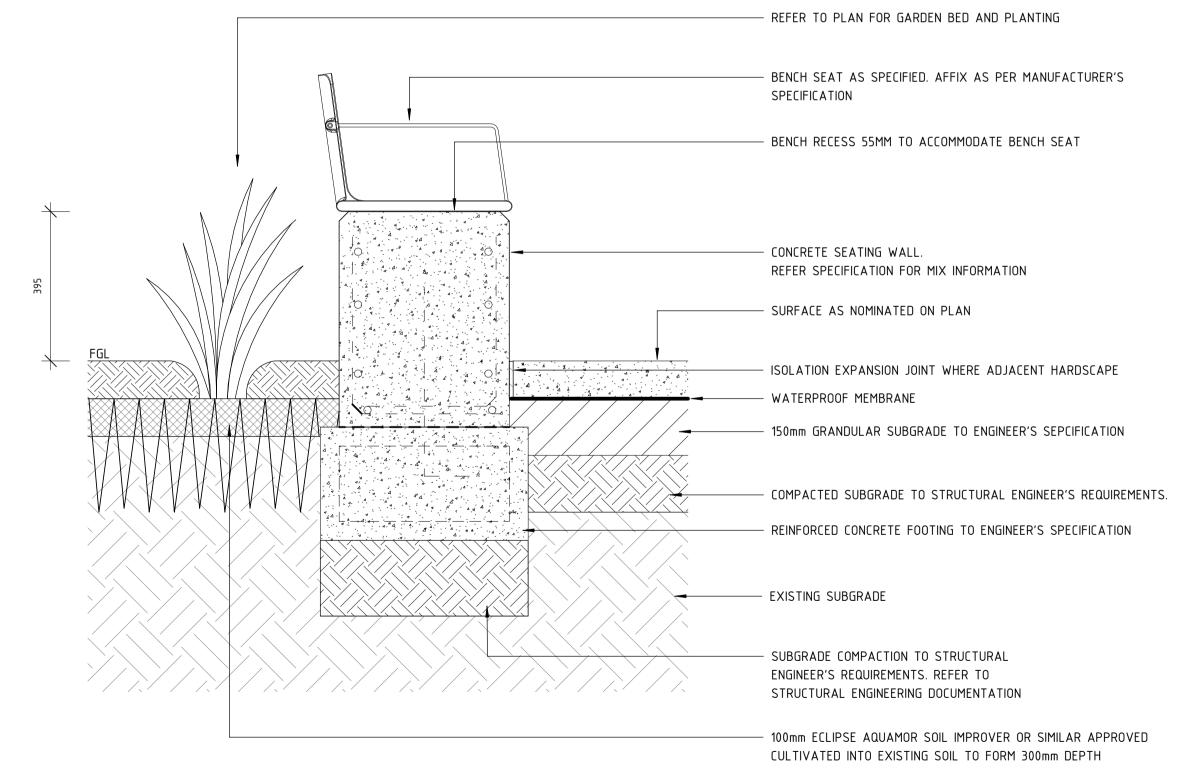

CONCRETE SEATING WALL W/ BENCH SEAT (F4-01B) - SECTION

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ORIG SIZE

0 10 20 30 40 50

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			L
REFERENCES	SCALE	DESIGNED	C.Holdsworth
	1 : 10	DRAWN	Y.Demissie
	DATUM	CHECKED	M.Harris
	HORIZONTAL: PCG2020	APPROVED	J.Davis
	VERTICAL: AHD71	DATE	10.07.23

DETAILED DESIGN

Government of Western Australia
BYFORD RAIL EXTENSION

BYFORD STATION PRECINCT

LANDSCAPE
HARDSCAPE DETAILS 03

PTA Drawing No: 11-A-109-LA0120

Rev: B.01

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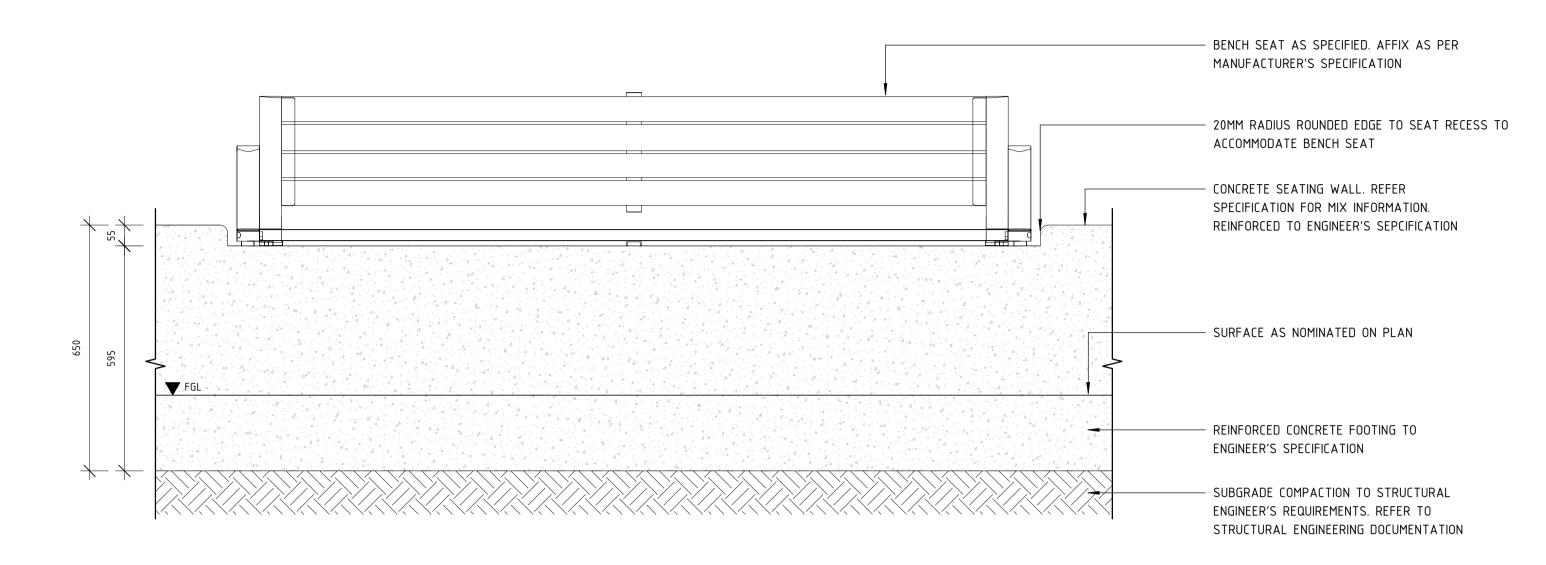
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NOTES:

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SEATED WALL BACKREST & ARMREST (F4-01B) - FRONT ELEVATION

1: 10

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Contractor No: R30-UDL-DWG-LA-330-01003 Rev: B.01



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SCALE	DESIGNED	C.Holdsworth	ſ
1 : 10		C.Hotas worth	
	DRAWN	Y.Demissie	
	CHECKED	M.Harris	
DATUM		11.1141115	
HORIZONTAL: PCG2020	APPROVED	J.Davis	
VERTICAL: AHD71	DATE	10.07.23	

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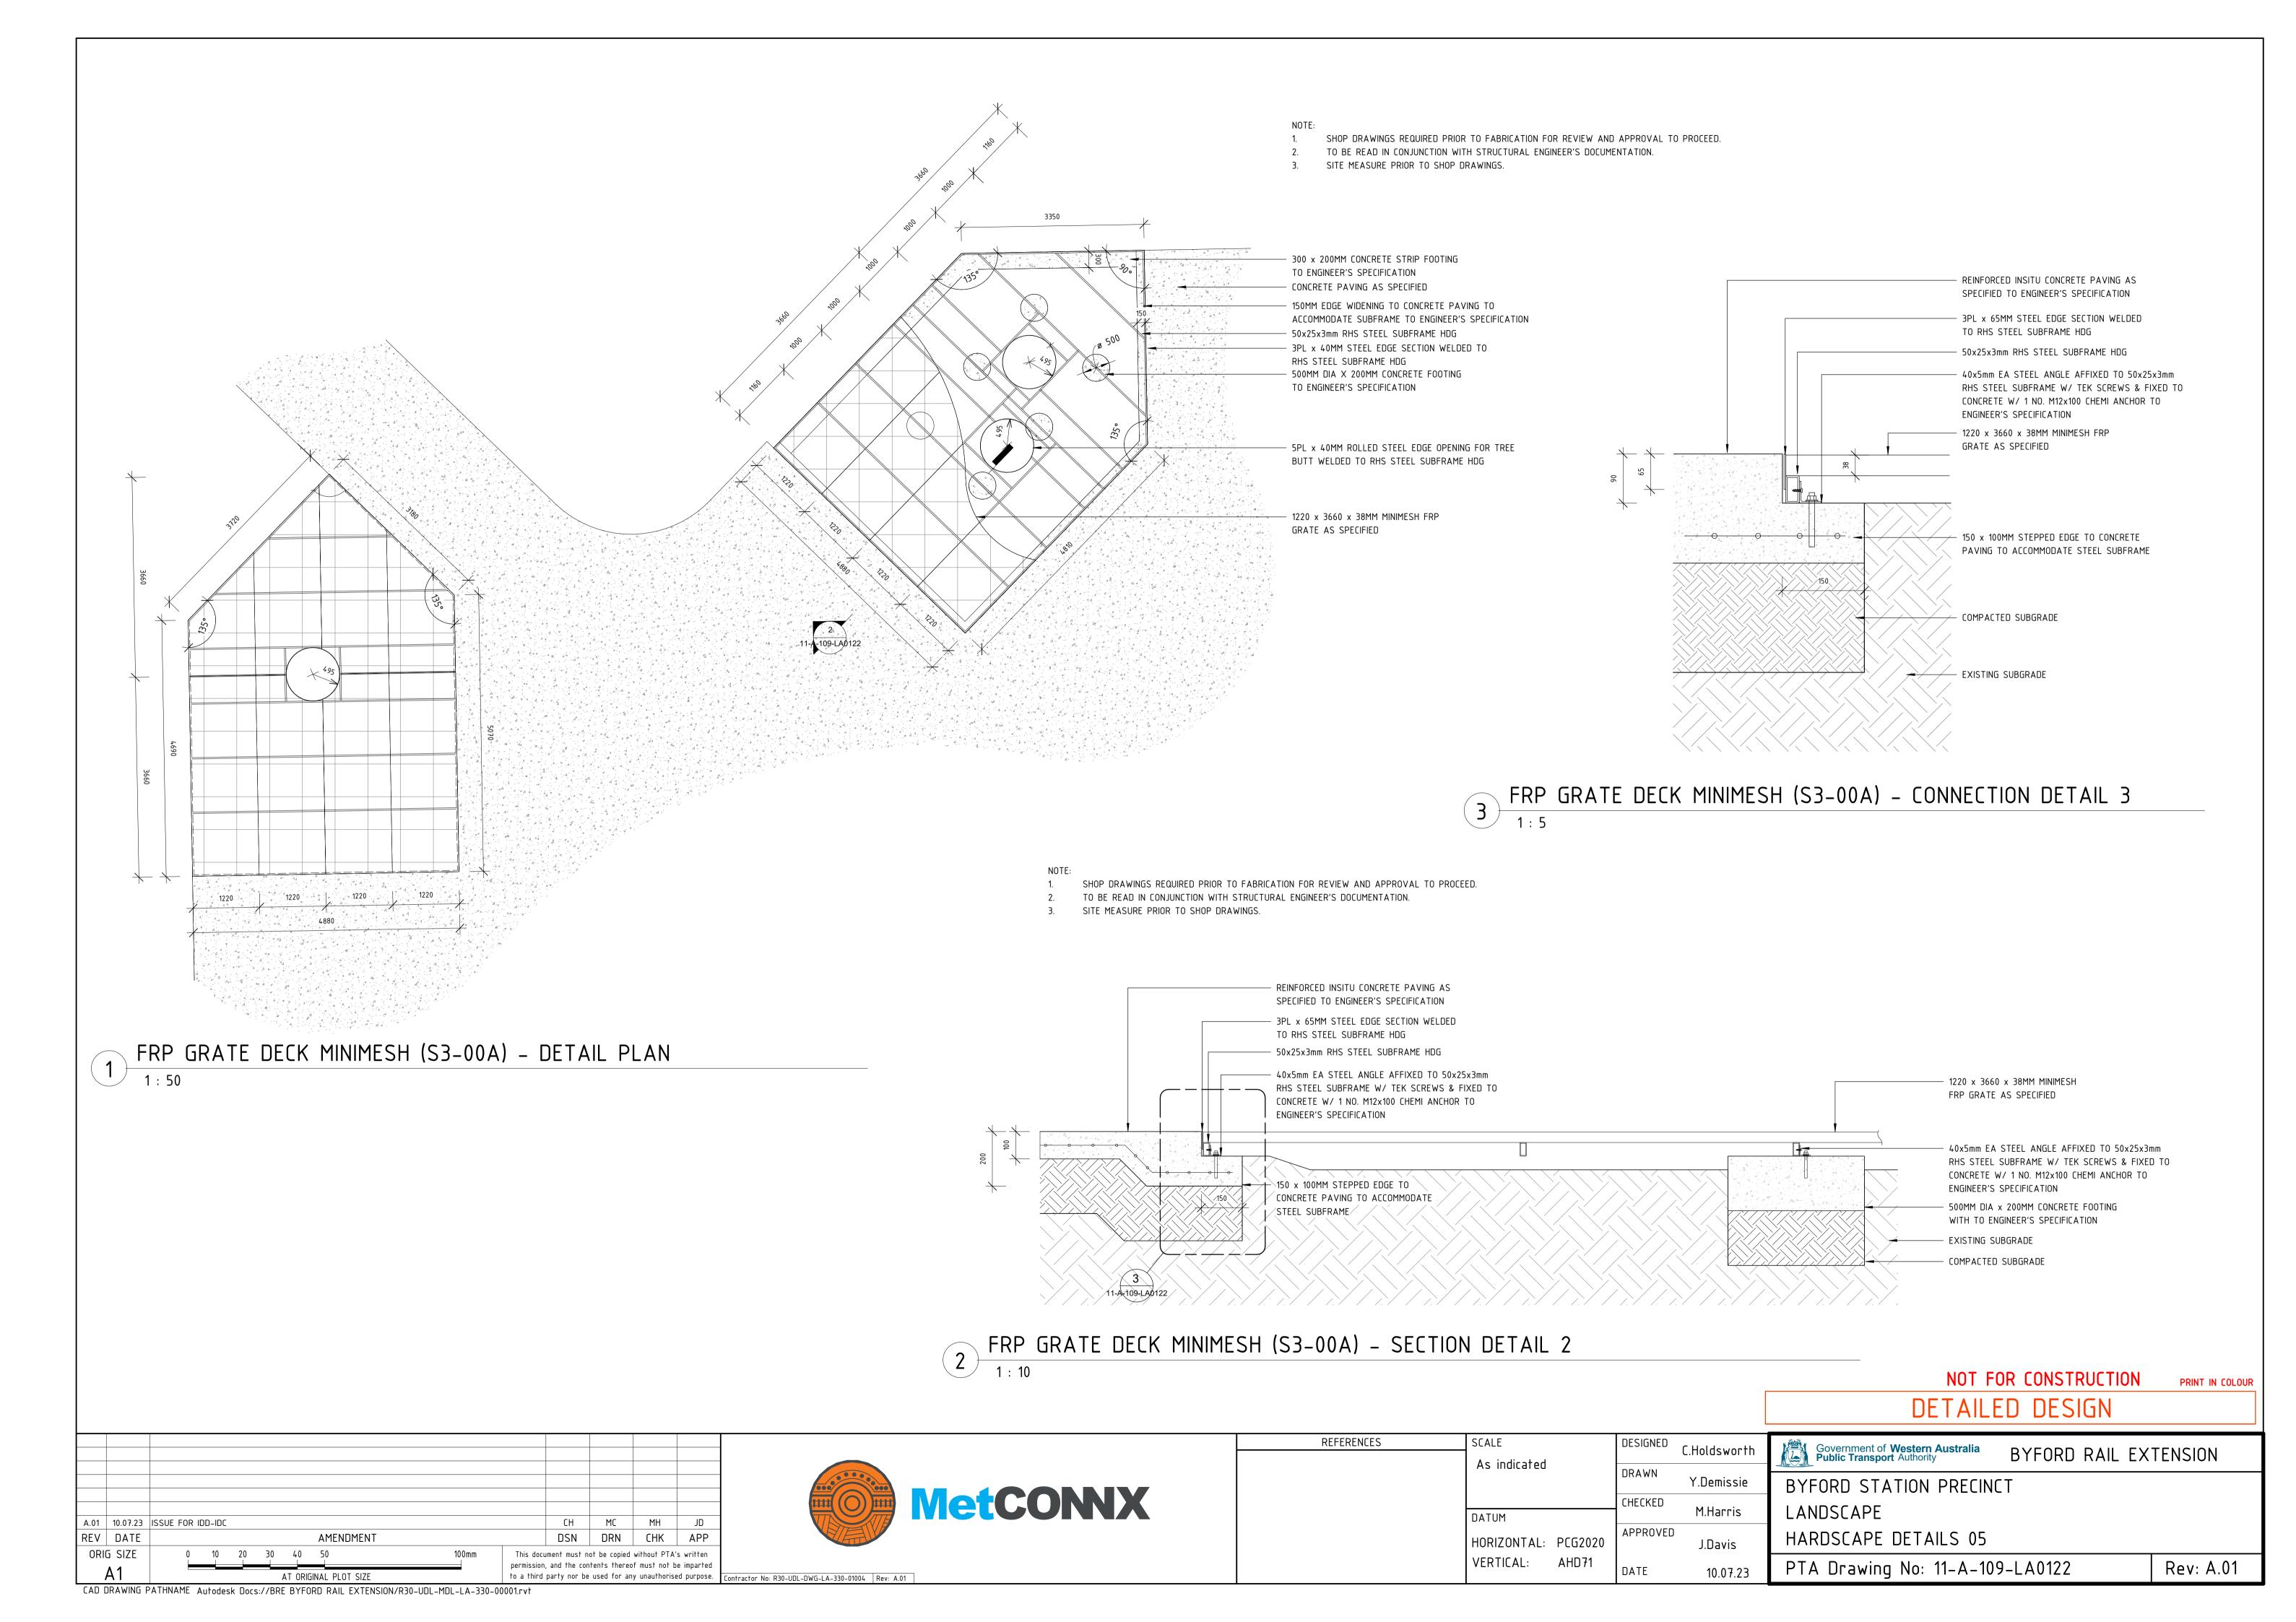
DETAILED DESIGN						
Government of Western Australia BYFORD RAIL EXTENSION BYFORD RAIL EXTENSION						
BYFORD STATION PRECINCT						
LANDSCAPE						
HARDSCAPE DETAILS 04						
PTA Drawing No: 11-A-109	-LA0121	Rev: B.01				


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PRODUCT: BIKE RACK TO MEET AS. 2890 - BST03 SUPPLIER: STREET FURNITURE AUSTRALIA MODEL: 316 GRADE STAINLESS STEEL SEMI-HOOP BICYCLE RACK NUMBER OF: 10 INSTALL TO MANUFACTURERS SPECIFICATION. TO BE SURFACE FIXED.



PRODUCT: DUAL RUBBISH & RECYCLING BIN SUPPLIER: DRAFFIN STREET FURNITURE MODEL: 800 SERIES BIN SURROUNDS WITH SLOPED COVER - 240LT NUMBER OF: 5 INSTALL TO MANUFACTURERS SPECIFICATION. TO BE SURFACE FIXED.



PRODUCT: DRINK FOUNTAIN WITH DOG BUBBLER - (DF4-DB) SUPPLIER: STREET FURNITURE AUSTRALIA MODEL: STAINLESS STEEL NUMBER OF: 1 INSTALL TO MANUFACTURERS SPECIFICATION. TO BE SURFACE FIXED.

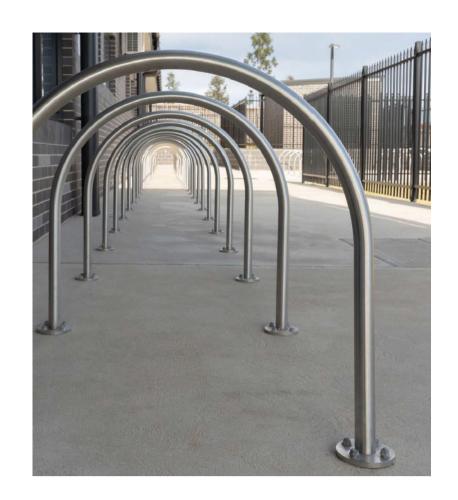DRINK FOUNTAIN (F3-01A)

1:10




PRODUCT: STANDALONE ARIA BENCH SEAT SUPPLIER: STREET FURNITURE AUSTRALIA MODEL: SPOTTED GUM TIMBER WITH STEEL NUMBER OF: TBA INSTALL TO MANUFACTURERS SPECIFICATION. TO BE SURFACE FIXED.



BENCH SEAT (F4-01A)

1:10




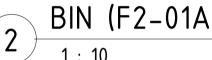



PRODUCT: ARIA 3-PERSON BENCH SEAT WITH BACK AND ARM REST SUPPLIER: STREET FURNITURE AUSTRALIA MODEL: SPOTTED GUM TIMBER AND STEEL NUMBER OF: 8 INSTALL TO MANUFACTURERS SPECIFICATION. TO BE SURFACE FIXED.

BENCH SEAT TOPPER (F4-01B)

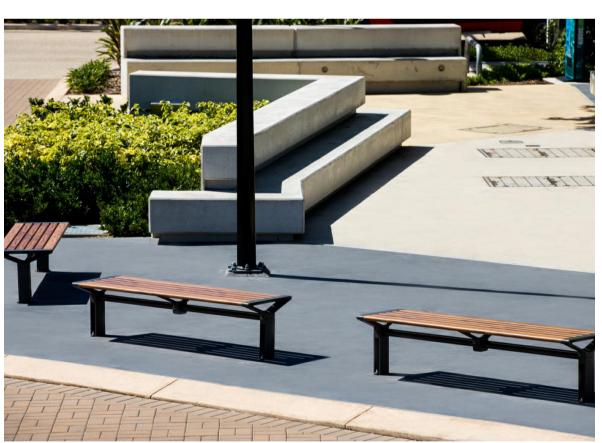

PRODUCT: ARIA 3-PERSON BENCH SEAT FLAT SUPPLIER: STREET FURNITURE AUSTRALIA MODEL: SPOTTED GUM TIMBER AND STEEL NUMBER OF: TBA INSTALL TO MANUFACTURERS SPECIFICATION. TO BE SURFACE FIXED.



BENCH SEAT FLAT (F4-01D)

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REFERENCES	SCALE		DESIGNED	C.Holdsworth	ſ
	1 : 10		DRAWN	Y.Demissie	F
	DATUM		CHECKED	M.Harris	
	HORIZONTAL:	PCG2020	APPROVED	J.Davis	
	VERTICAL:	AHD71	DATE	10.07.23	

DETAILED DESIGN Government of Western Australia Public Transport Authority BYFORD RAIL EXTENSION BYFORD STATION PRECINCT LANDSCAPE FURNITURE DETAILS 01 Rev: B.01 PTA Drawing No: 11-A-109-LA0123

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Contractor No: R30-UDL-DWG-LA-330-01005 Rev: B.01




PRODUCT: LOG CLIMBING SCRAMBLE WITH WAVY FIBREGLASS SLIDE SUPPLIER: LYPA
MODEL: L000107 - FINISHED AS SUPPLIED
NUMBER OF: TBA
INSTALL TO MANUFACTURERS SPECIFICATION.
TO BE SURFACE FIXED.





PRODUCT: A FRAME BASKET SWING SUPPLIER: LYPA MODEL: L006601 - FINISHED AS SUPPLIED NUMBER OF: TBA INSTALL TO MANUFACTURERS SPECIFICATION. TO BE SURFACE FIXED.

LYPA - BASKET SWING

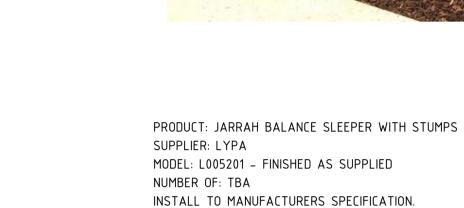

TO BE SURFACE FIXED.

3 LYPA - BALANCE SLEEPER WITH STUMPS
1: 10



PRODUCT: JARRAH TIMBER LOG STEPPERS SUPPLIER: LYPA MODEL: L005001 - FINISHED AS SUPPLIED NUMBER OF: TBA INSTALL TO MANUFACTURERS SPECIFICATION. TO BE SURFACE FIXED.

LYPA - TIMBER STEPPER

1: 10

8PL 800 x 125MM CUSTOM STEEL BOLLARD
FRAME FULLY WELDED HDG AND
POWDERCOAT AS SPECIFIED


8PL 100 x 125MM STEEL SPACER FULLY
WELDED HDG AND POWDERCOAT AS
SPECIFIED
TIMBER INSERT NATURAL OILED AS SPECIFIED
AFFIXED 2No. M12 NUT AND BOLT ASSEMBLY

10PL 280 x 260MM BASE PLATE BUTT
WELDED TO 8PL STEEL BOLLARD FRAME

M12 THREADED ROD CHEMSET INTO THICKENED
CONCRETE WITH ACORN NUT AND WASHER
ASSEMBLY TO ENGINEER'S SPECIFICATION
REINFORCED CONCRETE PAVING TO
ENGINEER'S SPECIFICATION

BOLLARDS - FIXED (F7-03B) FRONT ELEVATION

1: 10

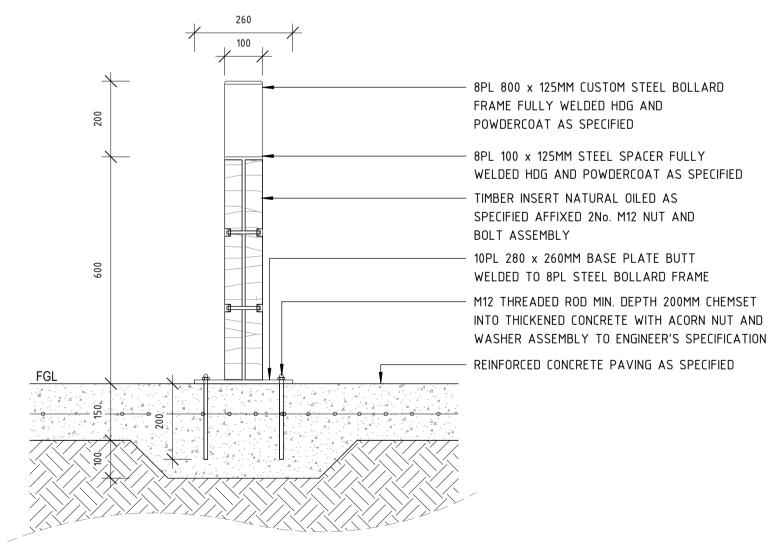

BOLLARDS - FIXED (F7-03B) SECTION

NOTE: REMOVABLE BOLLARD (F7-04B) TO BE DETAILED

B.01 10.07.23 ISSUE FOR IDD-IDC

A 12.10.22 ISSUE FOR RD

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DSN DRN CHK APP

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Contractor No: R30-UDL-DWG-LA-330-01006 Rev: B.01

REFERENCES	SCALE		DESIGNED	C.Holdsworth	
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				Y.Demissie	
	DATUM		CHECKED	M.Harris	
	HORIZONTAL:	PCG2020	APPROVED	J.Davis	
	VERTICAL:	AHD71	DATE	10 07 23	

DETAILED DESIGN

Government of Western Australia
BYFORD RAIL EXTENSION

BYFORD STATION PRECINCT

LANDSCAPE
FURNITURE DETAILS 02

PTA Drawing No: 11-A-109-LA0124


Rev: B.01

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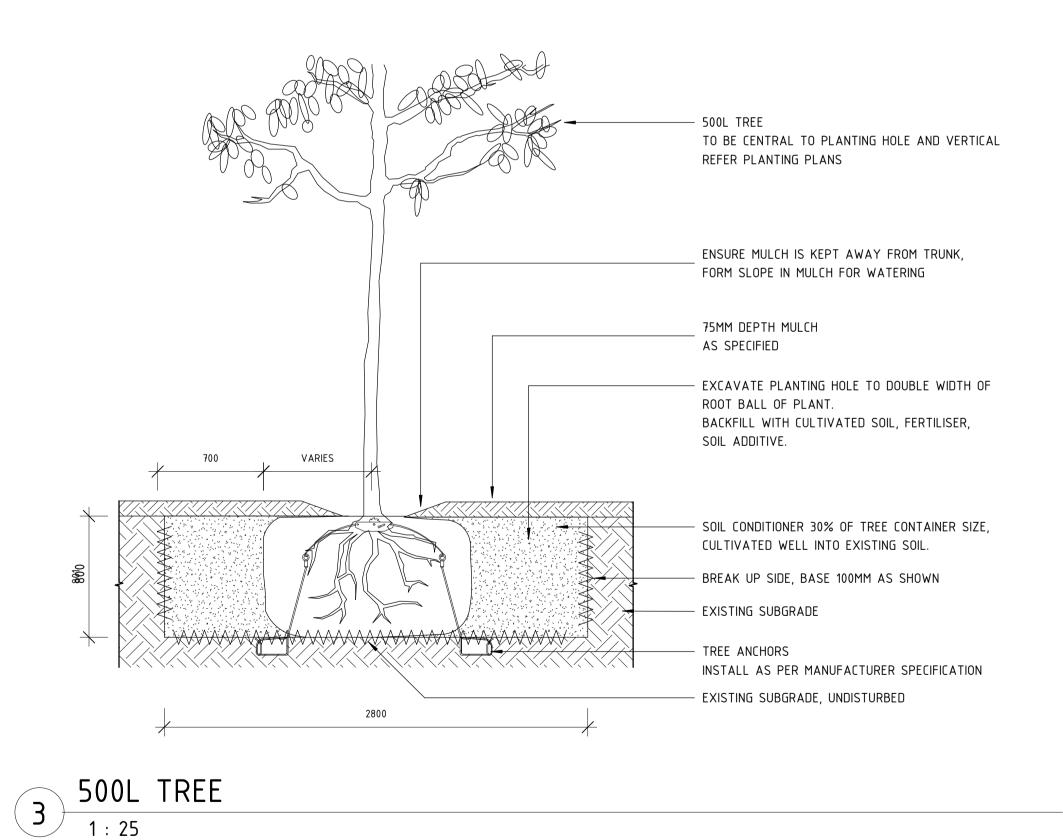
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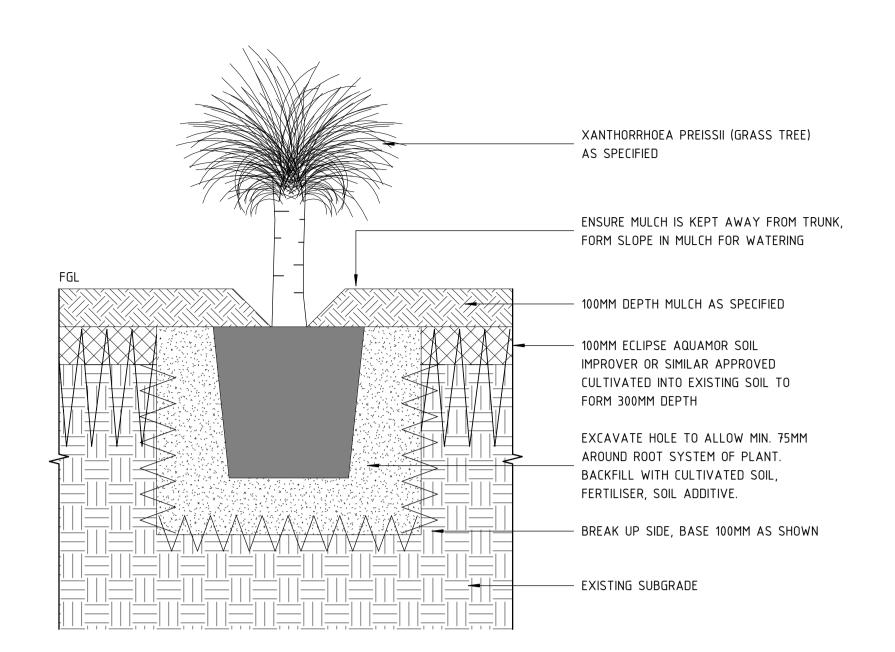
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1 45L TREE 1: 20



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2 XANTHORREA PREISSII

TO BE CENTRAL TO PLANTING HOLE AND VERTICAL REFER PLANTING PLANS - ENSURE MULCH IS KEPT AWAY FROM TRUNK. FORM SLOPE IN MULCH FOR WATERING - 75MM DEPTH MULCH AS SPECIFIED - EXCAVATE PLANTING HOLE TO DOUBLE WIDTH OF ROOT BALL OF PLANT. BACKFILL WITH CULTIVATED SOIL, FERTILISER, SOIL **VARIES** ADDITIVE. - SOIL CONDITIONER 30% OF TREE CONTAINER SIZE, CULTIVATED WELL INTO EXISTING SOIL. - BREAK UP SIDE, BASE 100MM AS SHOWN - EXISTING SUBGRADE - TREE ANCHORS INSTALL AS PER MANUFACTURER SPECIFICATION - EXISTING SUBGRADE, UNDISTURBED

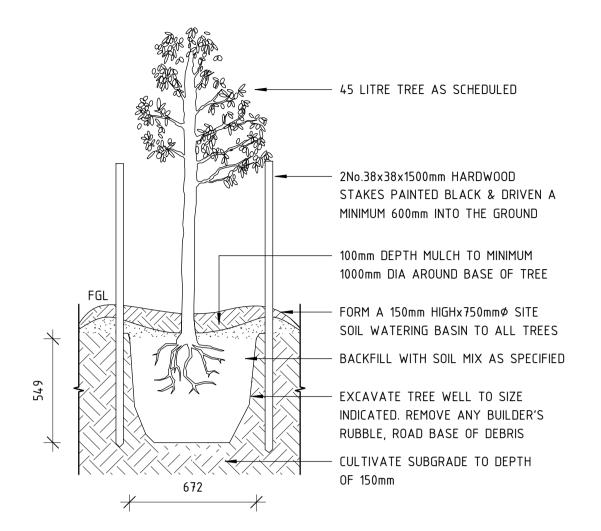1500L TREE

B.01 10.07.23 ISSUE FOR IDD-IDC

A 12.10.22 ISSUE FOR RD

CH YD MH AE

REV DATE

ORIG SIZE

O 10 20 30 40 50

100mm

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REFERENCES	SCALE		DESIGNED	C.Holdsworth
	As indicated			C.Hotasworth
			DRAWN	Y.Demissie
			CHECKED	M 11'-
	DATUM			M.Harris
	HORIZONTAL:	PCG2020	APPROVED	J.Davis
	VERTICAL:	AHD71	DATE	40.07.00

DETAILED DESIGN

Government of Western Australia BYFORD RAIL EXTENSION

BYFORD STATION PRECINCT

LANDSCAPE

SOFTSCAPE DETAILS 01


PTA Drawing No: 11-A-109-LA0128 Rev: B.01

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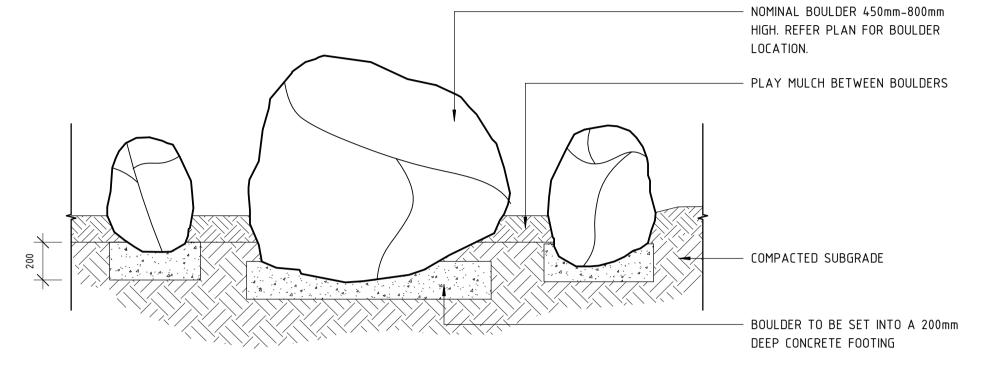
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GRANITE BOULDERS TO BE SOURCED AND INSTALLED. MIN HEIGHT SIZE 450mm-MAX SIZE 800mm. GENERALLY BOULDERS TO BE BURIED APPROX. 1/3 OF EXPOSED HEIGHT AND INSTALLED WITH MORTAR BED.



FEATURE BOULDERS

1: 20
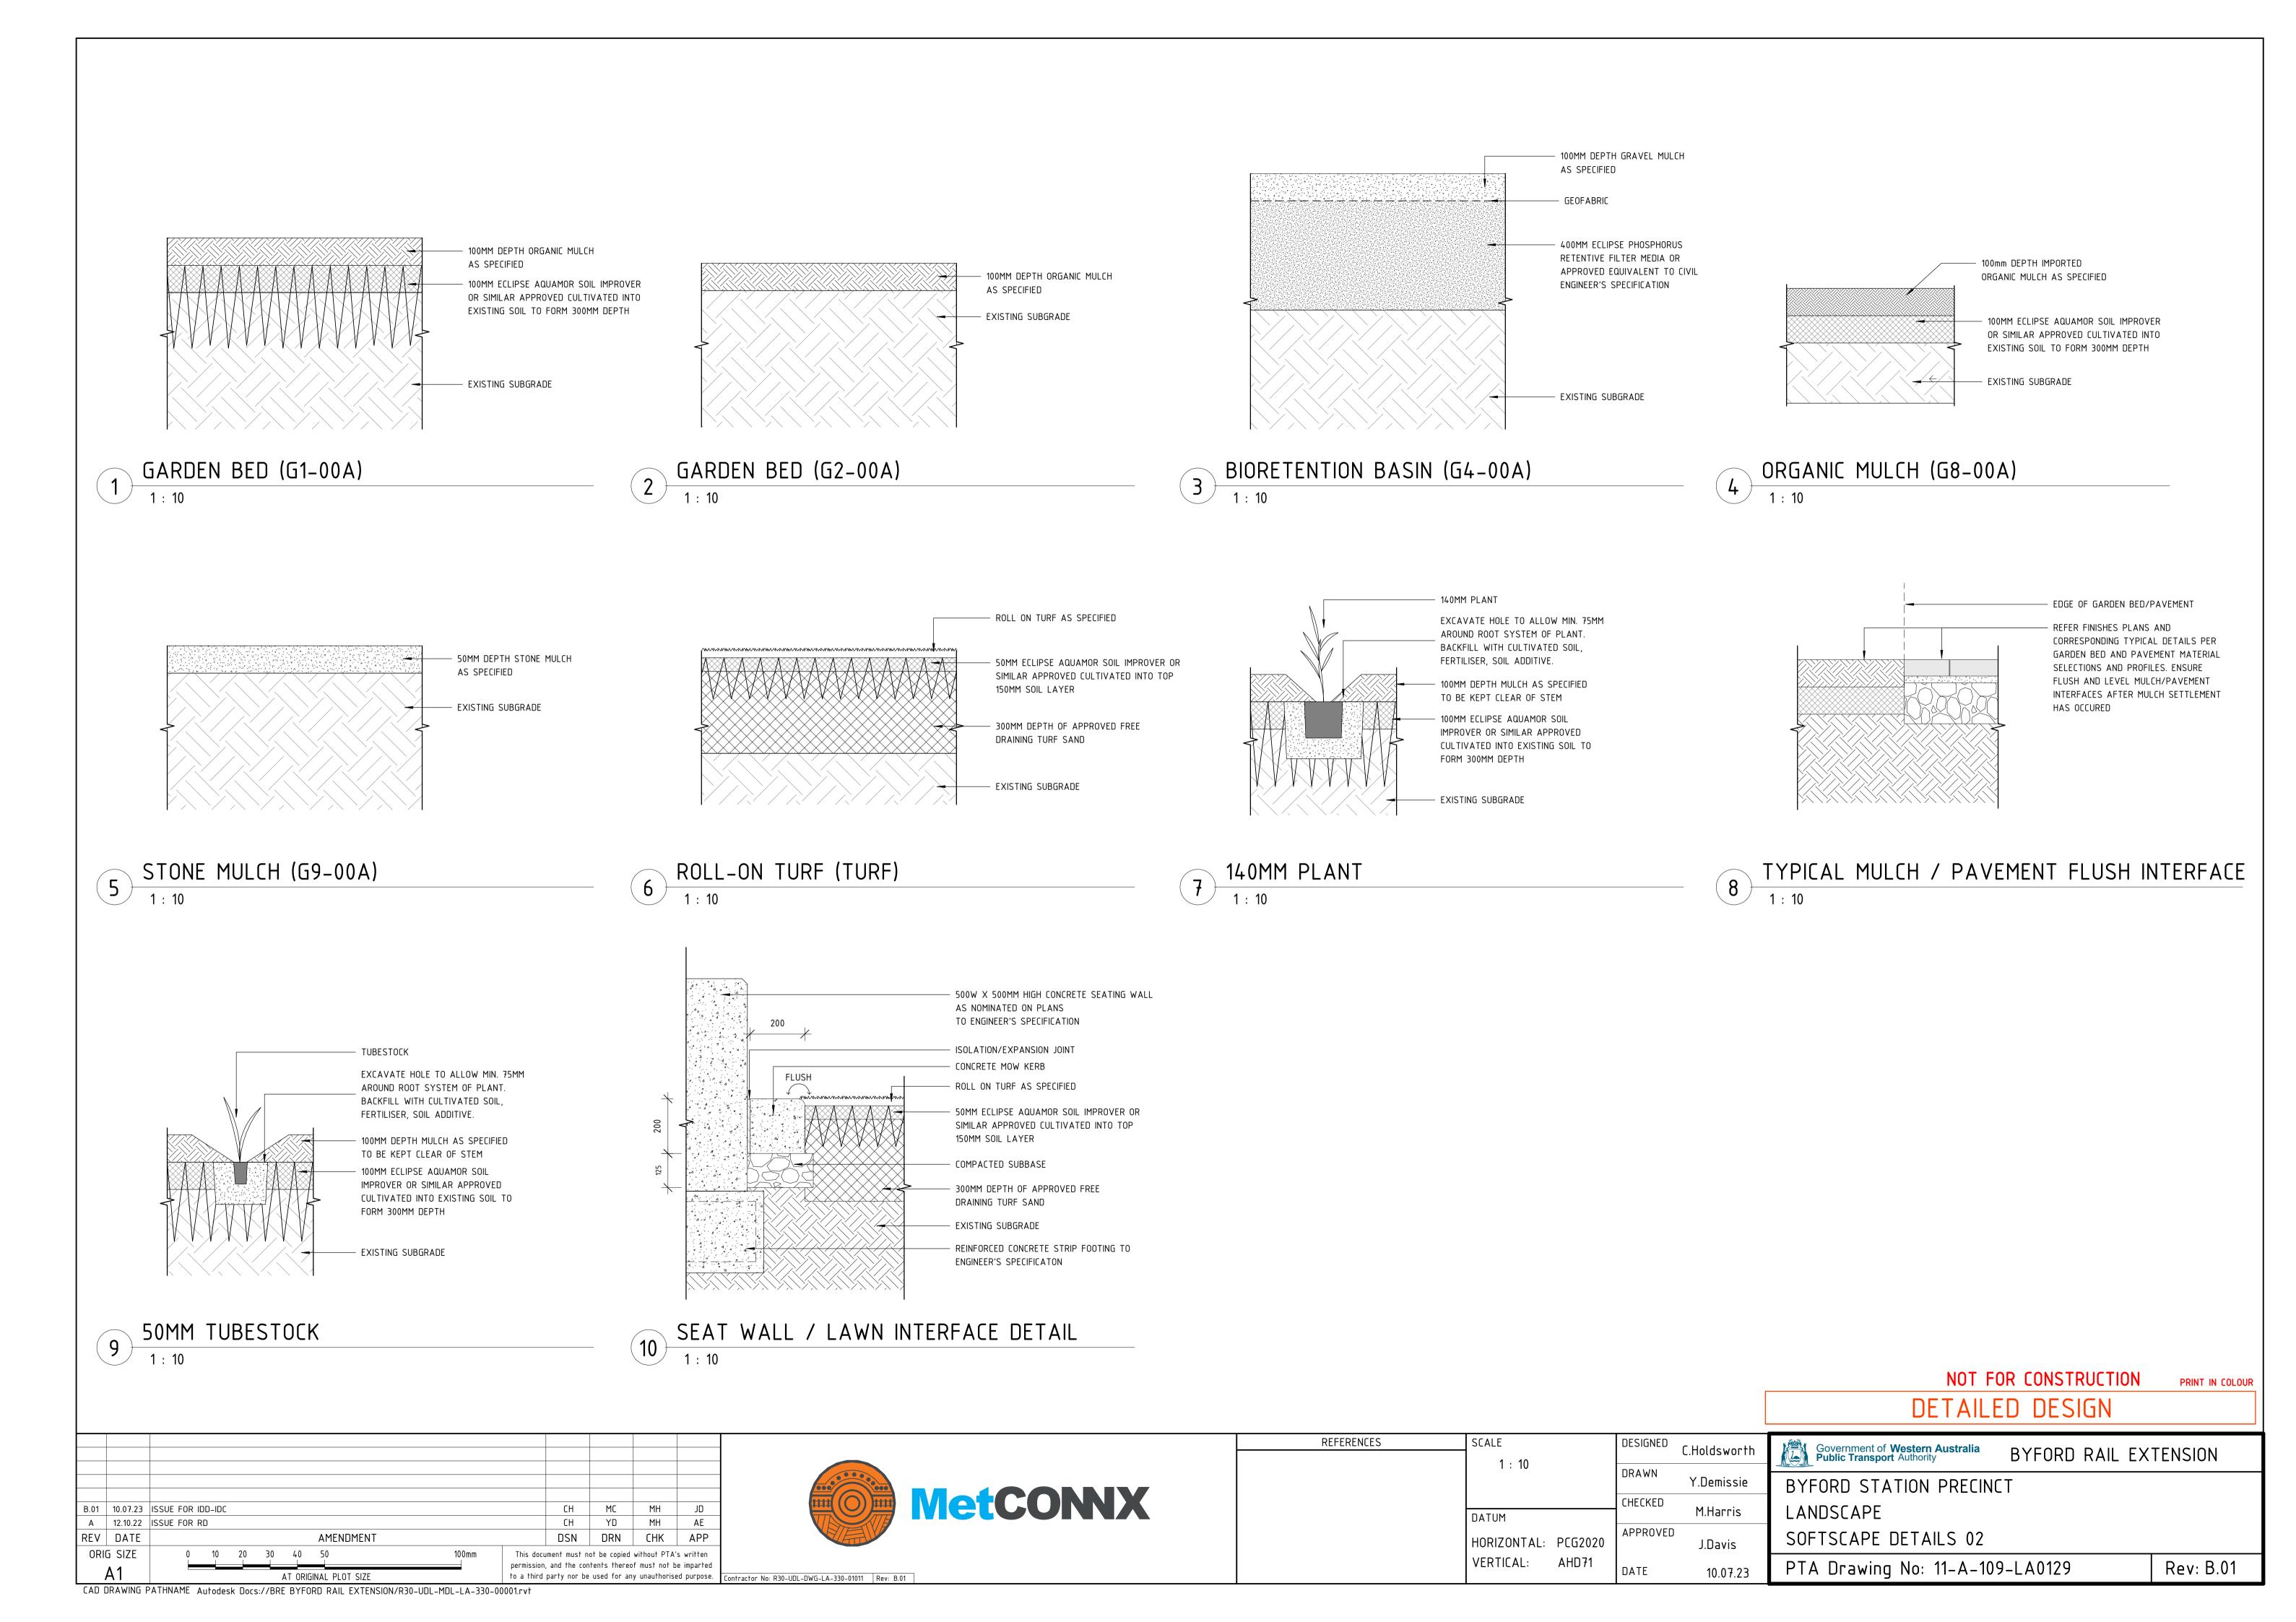
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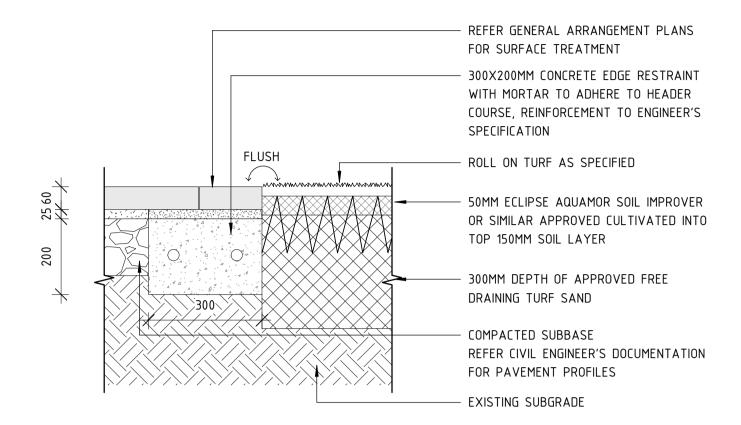
Rev: B.01

DETAILED DESIGN SCALE Government of Western Australia
Public Transport Authority C.Holdsworth 1:20 DRAWN Y.Demissie BYFORD STATION PRECINCT CHECKED LANDSCAPE M.Harris DATUM APPROVED SOFTSCAPE DETAILS 03 HORIZONTAL: PCG2020 J.Davis VERTICAL: PTA Drawing No: 11-A-109-LA0130 10.07.23

REFERENCES


B.01 10.07.23 ISSUE FOR IDD-IDC CH MC MH A 12.10.22 ISSUE FOR RD YD REV DATE AMENDMENT DSN DRN CHK APP ORIG SIZE 0 10 20 30 40 50 This document must not be copied without PTA's written permission, and the contents thereof must not be imparted to a third party nor be used for any unauthorised purpose. | Contractor No: R30-UDL-DWG-LA-330-01012 | Rev: B.01 AT ORIGINAL PLOT SIZE





1 UNIT PAVEMENT / TURF INTERFACE DETAIL
1: 10

NOTE: ALL SUBSOIL DRAINAGE AS FOLLOW UNLESS NOTED OTHERWISE. 100mm Ø 'VINIDEX DRAINCOIL' SLOTTED AG PIPE WRAPPED IN GEOTEXTILE FABRIC. LAY IN 300mm DEEP TRENCH BACKFILLED WITH STONE AGGREGATE(14mm) WITH MINIMUM100mm COVER IN TURF AREAS. MIN GRADE 1:400. GEOTEXTILE FABRIC TO BE BIDIM A14 OR SIMILARLY APPROVED MATERIAL.

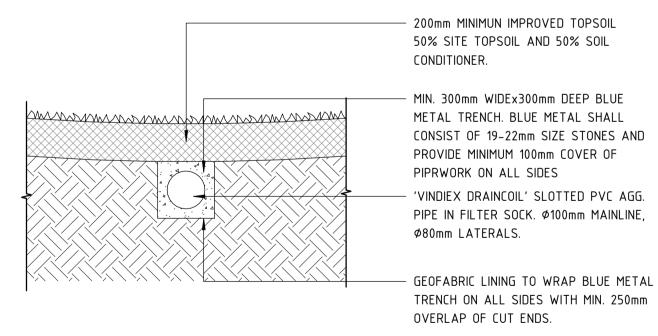


SUBSOIL DRAIN IN TURF

REFER GENERAL ARRANGEMENT PLANS FOR SURFACE TREATMENT 300X200MM CONCRETE EDGE RESTRAINT WITH MORTAR TO ADHERE TO HEADER COURSE, REINFORCEMENT TO ENGINEER'S SPECIFICATION 75MM DEPTH MULCH AS SPECIFIED 100MM ECLIPSE AQUAMOR SOIL IMPROVER OR SIMILAR APPROVED CULTIVATED INTO EXISTING SOIL TO FORM 300MM DEPTH COMPACTED SUBBASE REFER CIVIL ENGINEER'S DOCUMENTATION FOR PAVEMENT PROFILES - EXISTING SUBGRADE

2 UNIT PAVEMENT / GARDEN INTERFACE DETAIL
1: 10

NOTE: ALL SUBSOIL DRAINAGE AS FOLLOW UNLESS NOTED OTHERWISE. 100mm Ø 'VINIDEX DRAINCOIL' SLOTTED AG PIPE WRAPPED IN GEOTEXTILE FABRIC. LAY IN 300mm DEEP TRENCH BACKFILLED WITH STONE AGGREGATE(14mm) WITH MINIMUM100mm COVER IN TURF AREAS. MIN GRADE 1:400. GEOTEXTILE FABRIC TO BE BIDIM A14 OR SIMILARLY APPROVED MATERIAL.

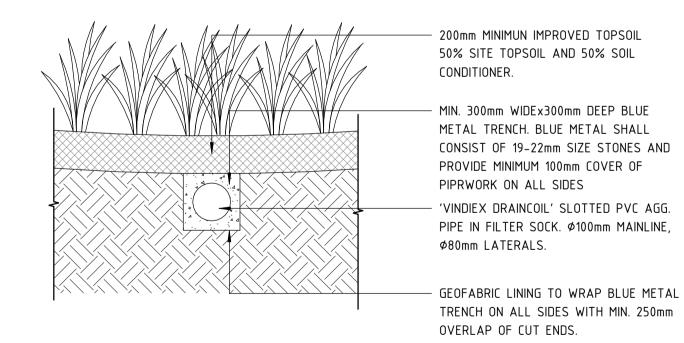

SUBSOIL DRAIN IN PLANTING

B.01	10.07.23	ISSUE FOR	IDD-IDC							CH	MC	MH	JD
Α	12.10.22	ISSUE FOR	RD							CH	YD	MH	AE
REV	DATE						AMENDMENT			DSN	DRN	CHK	APP
ORI	G SIZE	0	10	20	30	40	50	 100mm				without PTA'	
	۸ 1								permission,	and the con	tents thered	of must not b	e imparted



REFERENCES	SCALE	DESIGNED	C.Holdsworth
	As indicated		C101.05.1111
	A3 malcarea	DRAWN	Y.Demissie
		CHECKED	
	DATUM		M.Harris
	HORIZONTAL: PCG2020	APPROVED	J.Davis
	VERTICAL: AHD71	DATE	10.07.23

DETAILED DESIGN Government of Western Australia
Public Transport Authority BYFORD RAIL EXTENSION BYFORD STATION PRECINCT LANDSCAPE SOFTSCAPE DETAILS 04 PTA Drawing No: 11-A-109-LA0131 Rev: B.01

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